

First Addendum

Project Name	International Trade Center Renovations 4 th Floor Construction, Phase I							
Location	Mobile, AL							
Project #	11091 Task 6	June 2024						

First Addendum

International Trade Center Renovations 4th Floor Construction, Phase I June 12, 2024




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Location	Mobile, AL							
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The Bid Specification Book is amended to include the Drawings and Product Information sheets attached herewith.

ALABAMA STATE PORT AUTHORITY 4th FLOOR INTERIOR - PHASE 1 250 N. WATER STREET MOBLE, AL



	DRAWIN	IG II	NDEX
Τ	TITLE SHEET	P1.0	PLUMBING SCHEDULES & NOTES
		P2.0	4th FLOOR PLUMBING DEMO PLAN
A1.1	4th FLOOR PLAN - DEMOLITION	P3.0	4th FLOOR PLUMBING NEW WORK PLAN
A1.2	4th FLOOR PLAN - NEW WORK	P4.0	4th FLOOR SANITARY NEW WORK PLAN
A1.3	RESTROOM PLANS		
A1.4	REFLECTED CEILING PLAN	M1.0	HVAC SCHEDULES & NOTES
A1.5	FLOOR PATTERN PLAN	M2.0	4th FLOOR HVAC DEMO PLAN
A2.1	RESTROOM INTERIOR ELEVATIONS	M3.0	4th FLOOR HVAC NEW WORK PLAN
A2.2	RESTROOM INTERIOR ELEVATIONS	M4.0	HVAC DETAILS
A3.1	FINISH SCHEDULE and DETAILS		
A4.1	WALL SECTIONS	E1.0	ELECTRICAL LEGEND AND SPECIFICATIONS
A4.2	WALL SECTIONS	E2.0	4th FLOOR LIGHTING PLAN - DEMOLITION
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A5.1	DOOR SCHEDULE	E4.0	4th FLOOR LIGHTING PLAN - NEW WORK
		E5.0	4th FLOOR POWER PLAN - NEW WORK
		E6.0	ELECTRICAL DETAILS AND SCHEDULES

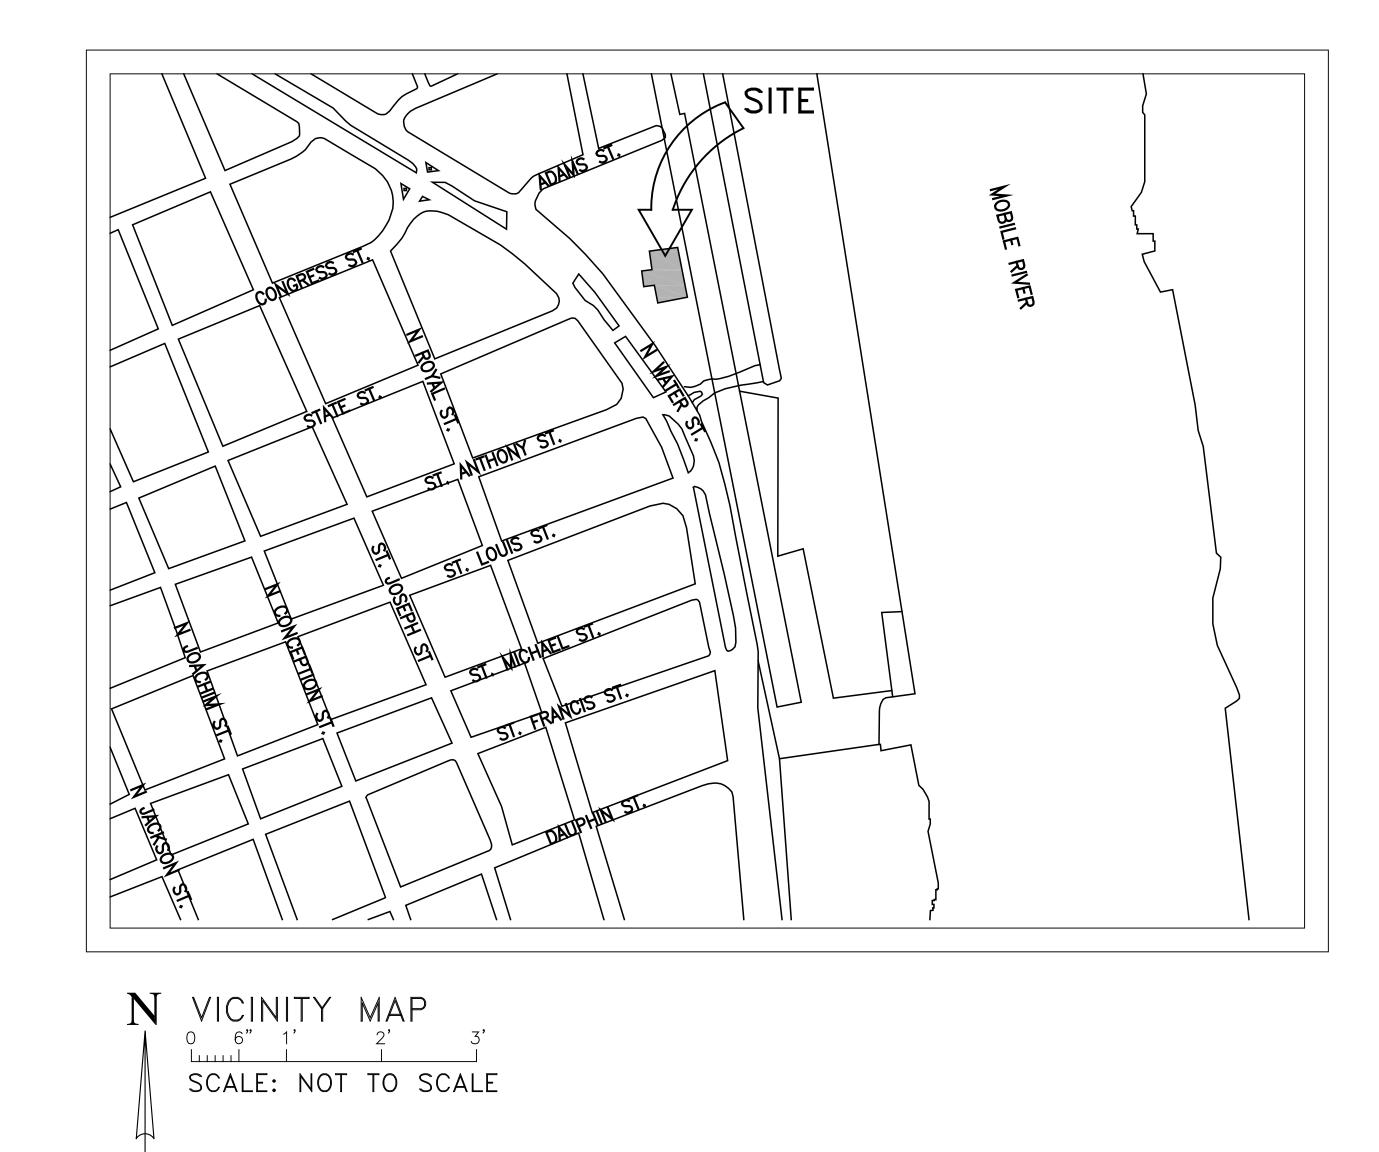	CUMMINGS ARCHITECTURE CORP
	One Houston Street Mobile, Alabama 36606 TEL 251.433.9600
	ABOO CONTRACTOR
PLAN PLAN PLAN	ALABAMA STATE PORT AUTHORITY 4th FLOOR INTERIOR - PHASE 1 250 N. WATER STREET MOBILE, AL
IOLITION LITION / WORK WORK _ES	THIS DRAWING AND ITS REPRODUCTIONS ARE THE PROPERTY OF THE ARCHITECT AND MAY <i>NOT</i> BE REPRODUCED, PUBLISHED, OR USED IN ANY MANNER WITHOUT THE PERMISSION OF THE ARCHITECT.
	SHEET NAME TITLE SHEET NAME TROJECT NO. 2024–01 DATE JUNE 6, 2024 SHEET NO. T
	ACTUAL SHEET SIZE IS 22" x 34"


DEMOLITION NOTES


- D1 WORK TO CONCRETE SLAB IN AREAS THAT ARE SHADED:
- REMOVE THE MUD BED TO EXPOSE THE CONCRETE SLAB. • CLEAN THE CONCRETE SLAB.
- REMOVE OR RELOCATE OLD PLUMBING SUPPLY AND WASTE LINES AS DIRECTED ON THE PLUMBING PLANS.
- "BLIND OFF" ALL PENETRATIONS THROUGH THE SLAB.
- APPLY PRIMER TO SLAB. • INSTALL MAPEI, SELF-LEVELER PLUS (OR EQUAL)
- SELF-LEVELING UNDERLAYMENT. INSTALL PER MANUFACTURERS INSTRUCTIONS. FILL RECESS UP TO LEVEL OF ADJACENT SLAB.
- (NOTE: IN RESTROOM WHERE HARD TILE IS STILL PRESENT, REMOVE THE TILE.)

D2 FULLY REMOVE THIS STEEL FRAME.

D3 (not used)

- D4 REMOVE THE CERAMIC TILE BLOCK FROM BETWEEN THE COLUMNS.
- EQUIPMENT AND DUCTS IN THIS AREA.
- LOBBY SHALL REMAIN.
- FOR SIZE.

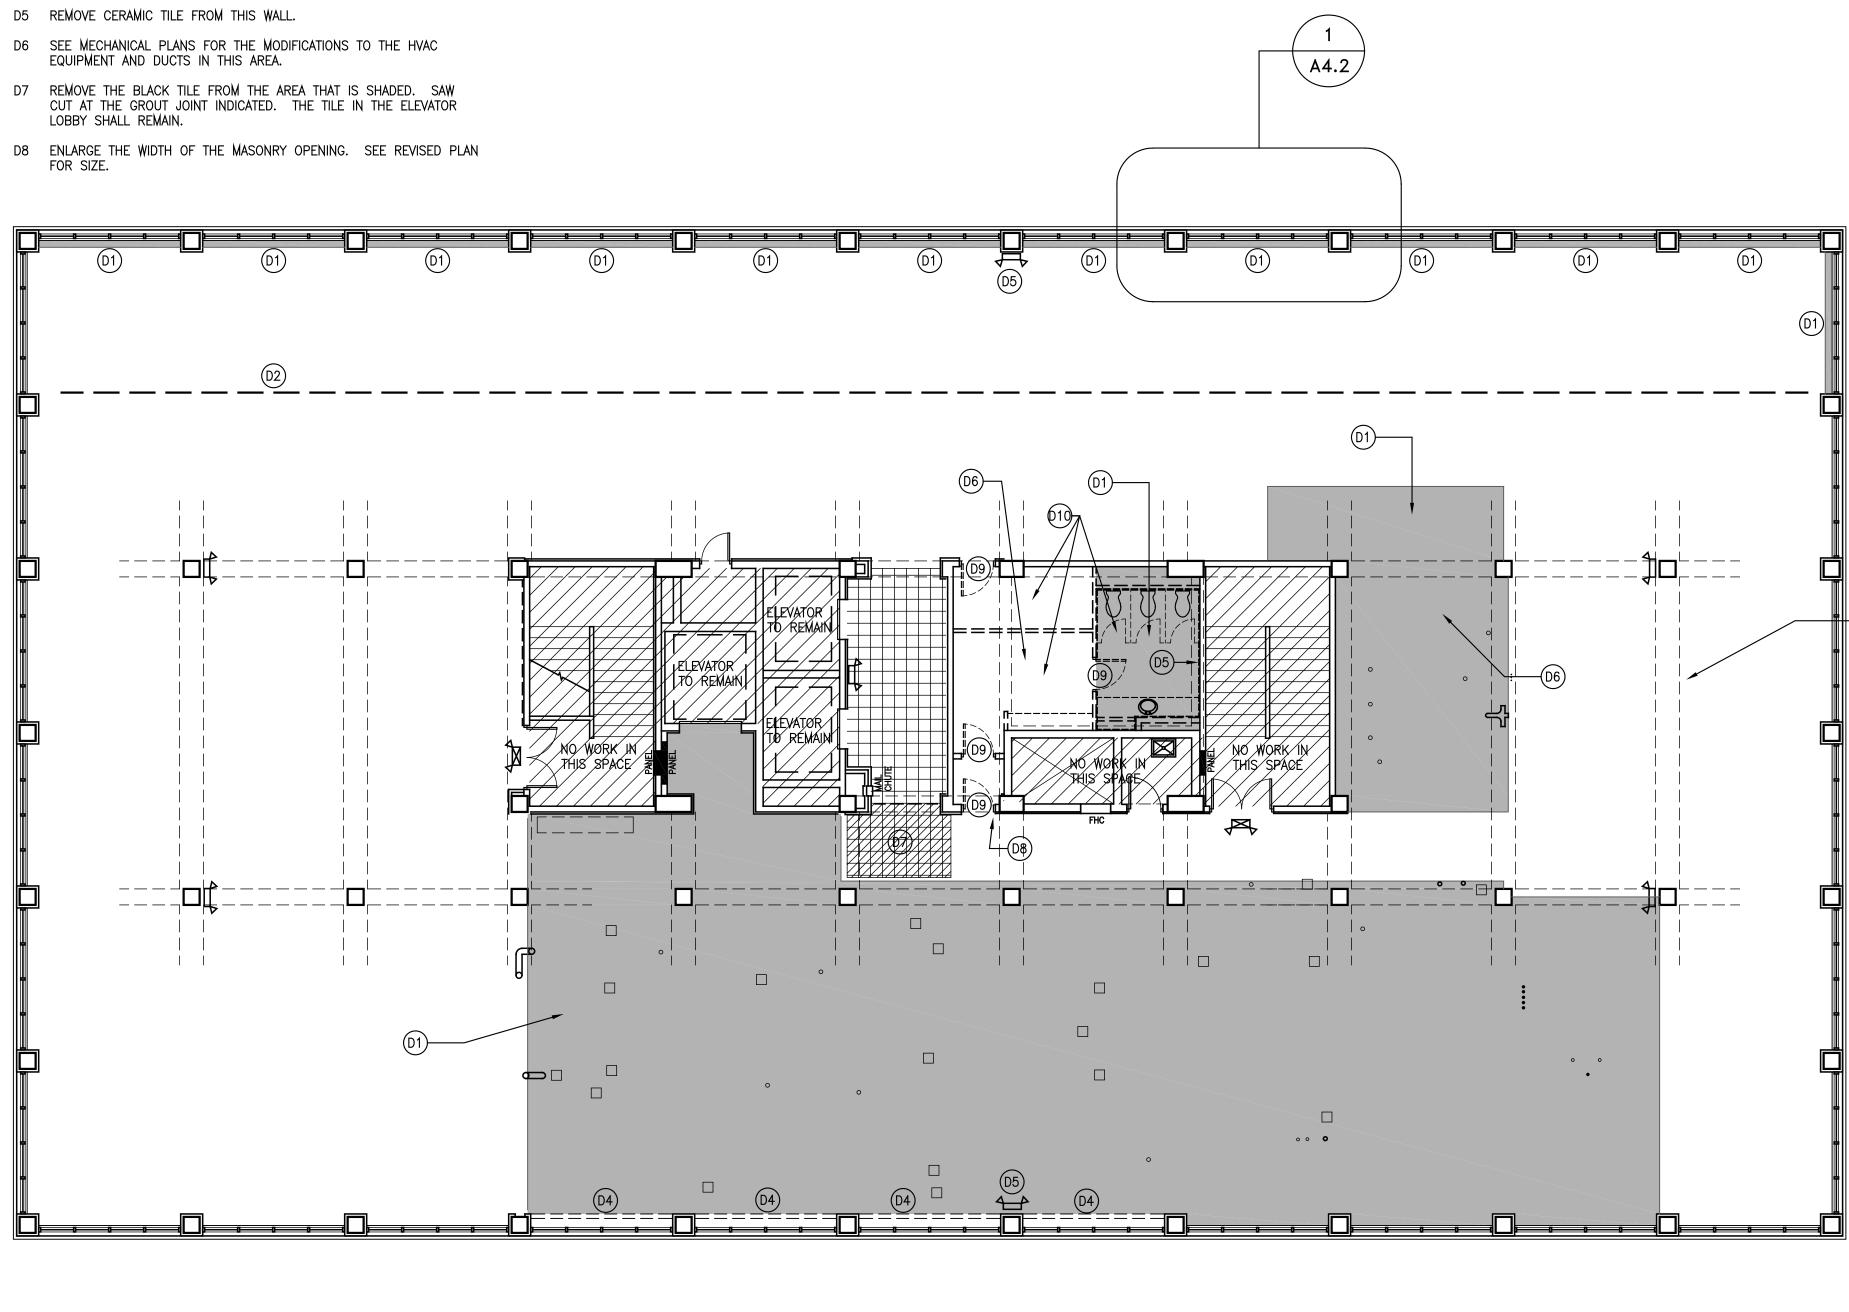

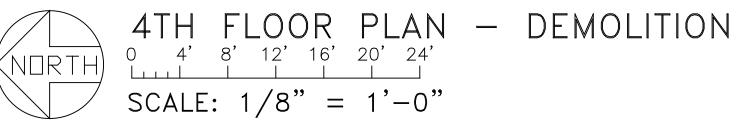



- D9 REMOVE DOOR AND FRAME.
- D10 COMPLETELY GUT THIS RESTROOM:
 - REMOVE TOILETS AND SINK. ALTER SUPPLY AND DRAIN LINES AS SHOWN ON THE PLUMBING PLANS.
 - REMOVE THE TOILET PARTITIONS. • REMOVE THE LAVATORY COUNTER AND OTHER COUNTER.
 - REMOVE MIRRORS AND ACCESSORIES.
 - REMOVE THE CARPET AND BASE. • REMOVE THE CERAMIC TILE.
 - REMOVE THE SUSPENDED CEILING SYSTEM.
 - REMOVE THE PLASTER CEILING. REMOVE WALLS THAT ARE DASHED.
 - REMOVE LIGHTS AND RECEPTACLES AND SWITCHES AND
 - ASSOCIATED CONDUIT. REMOVE CIRCUITS BACK TO SOURCE.








NOTE: THESE DASHED LINES INDICATE LOCATION OF STRUCTURAL CONCRETE BEAMS AT THE CEILING AND BELOW THE SLAB.

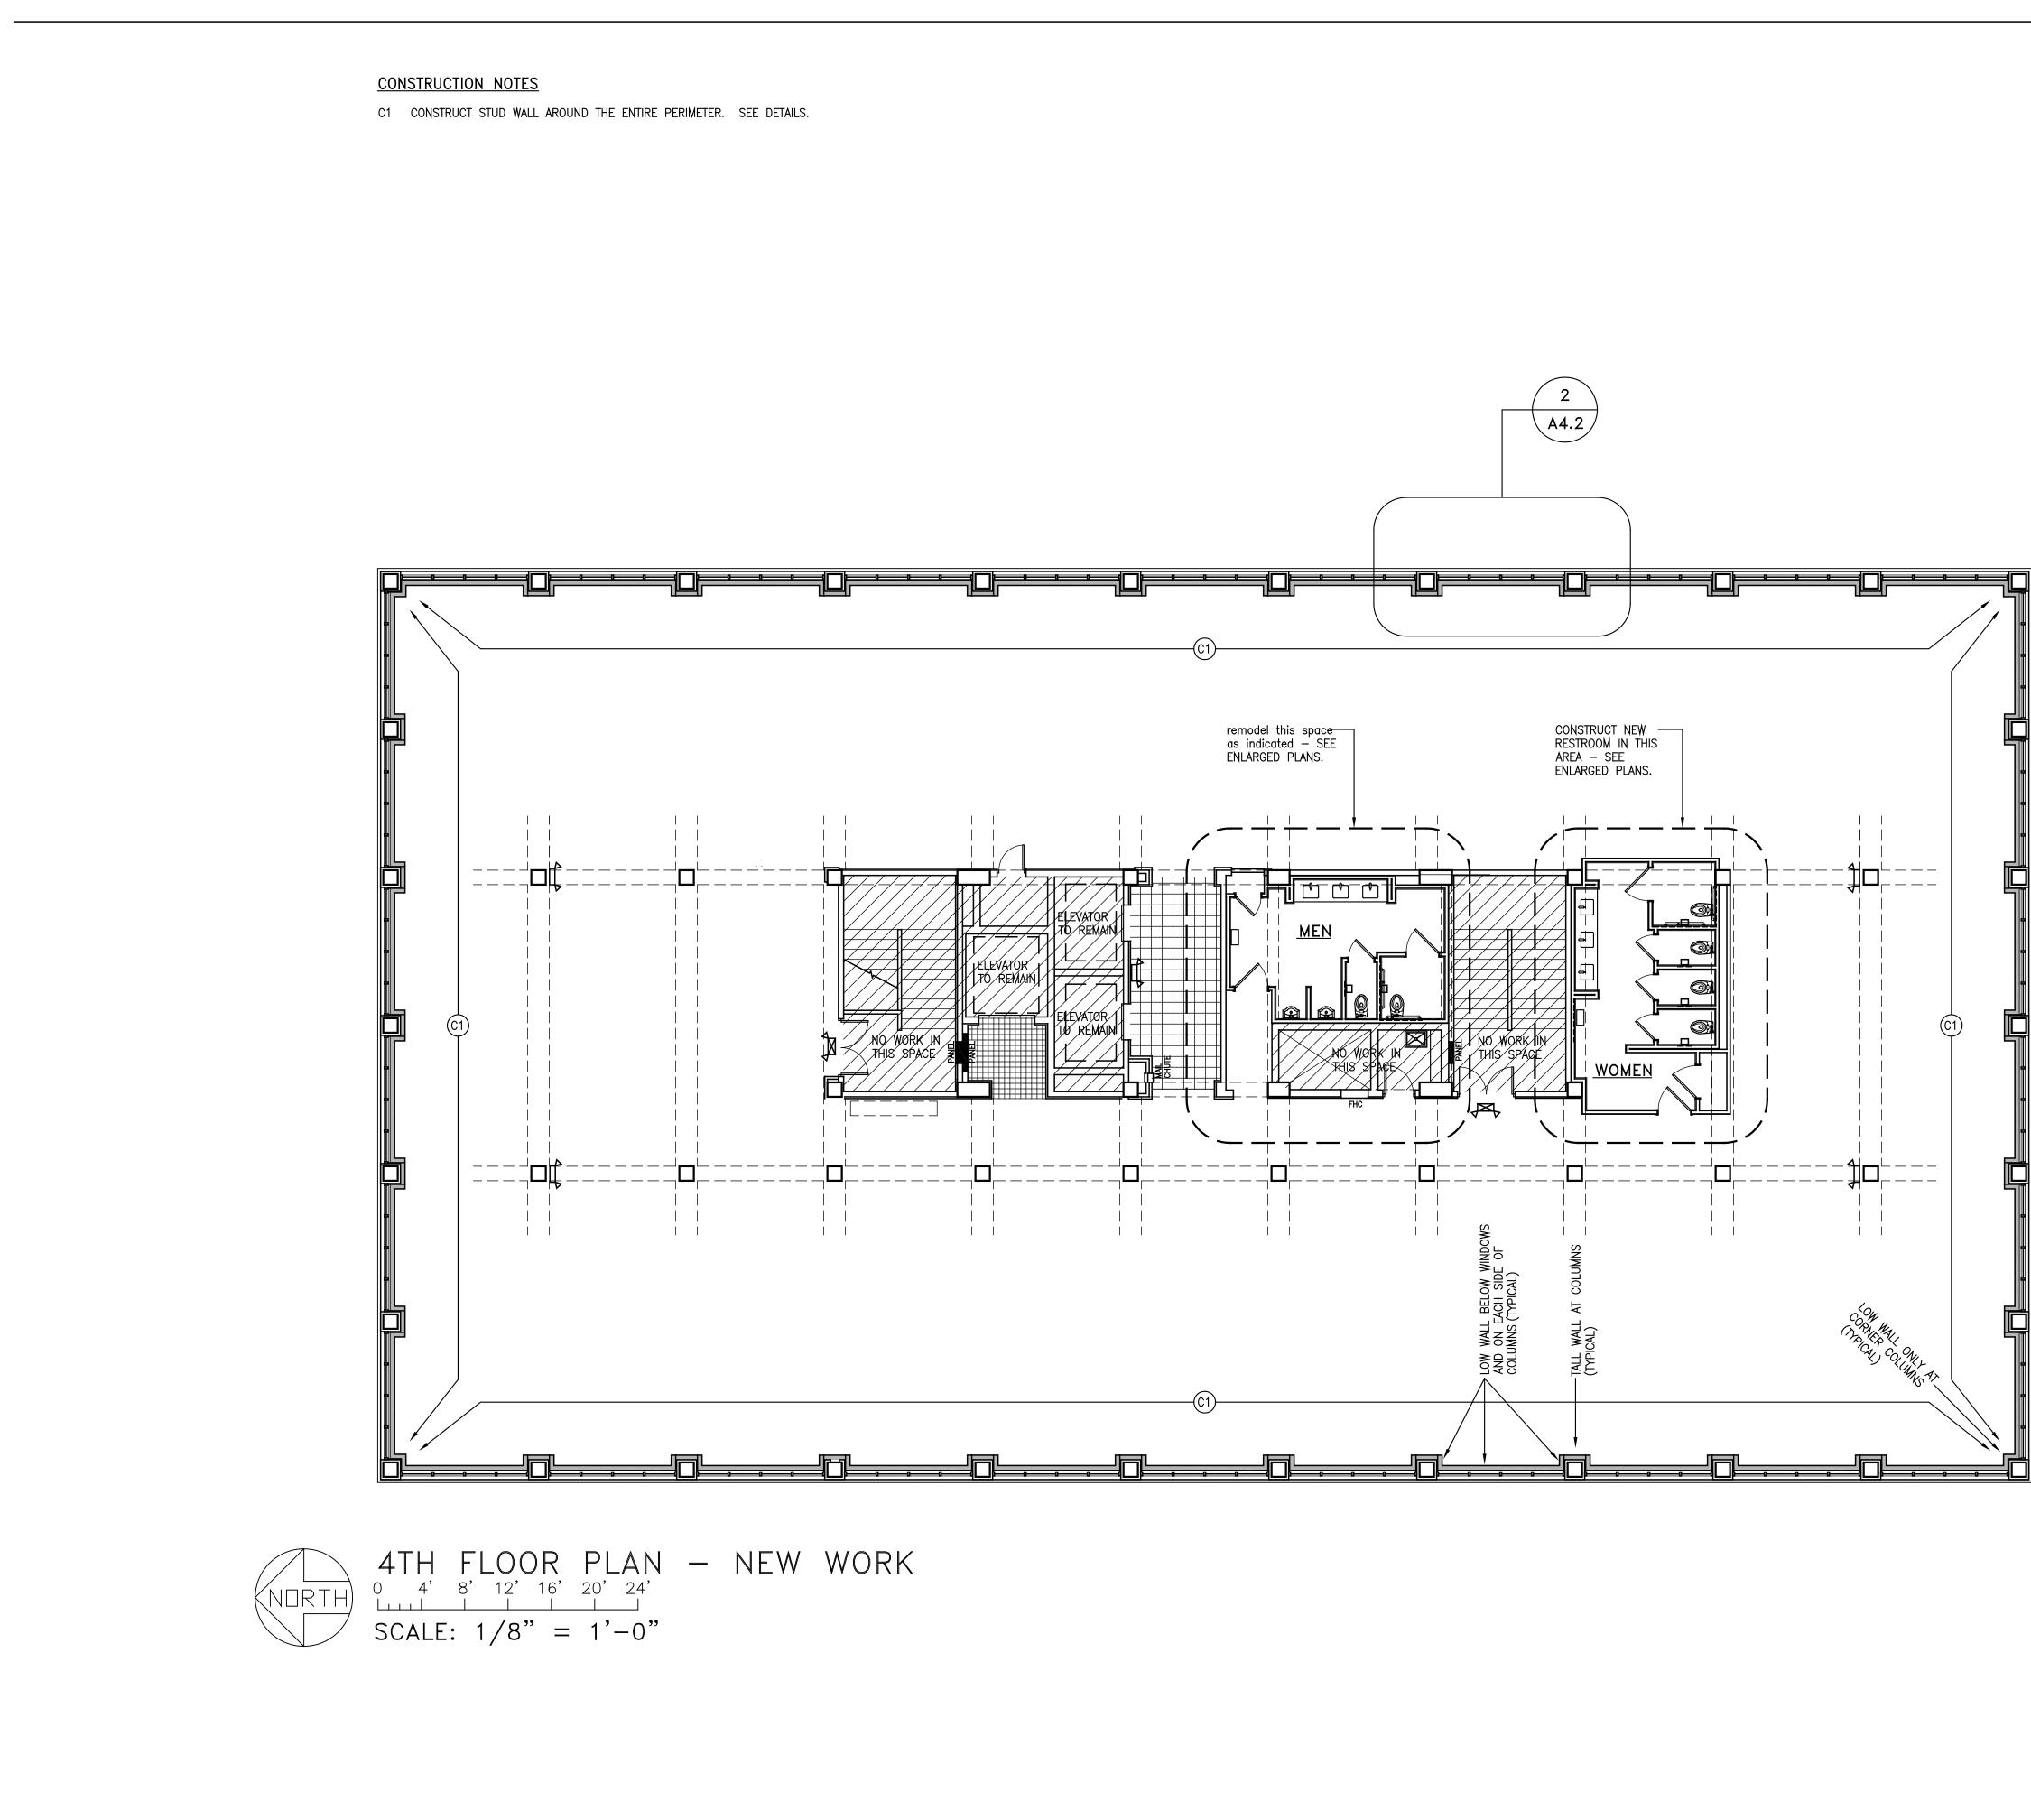


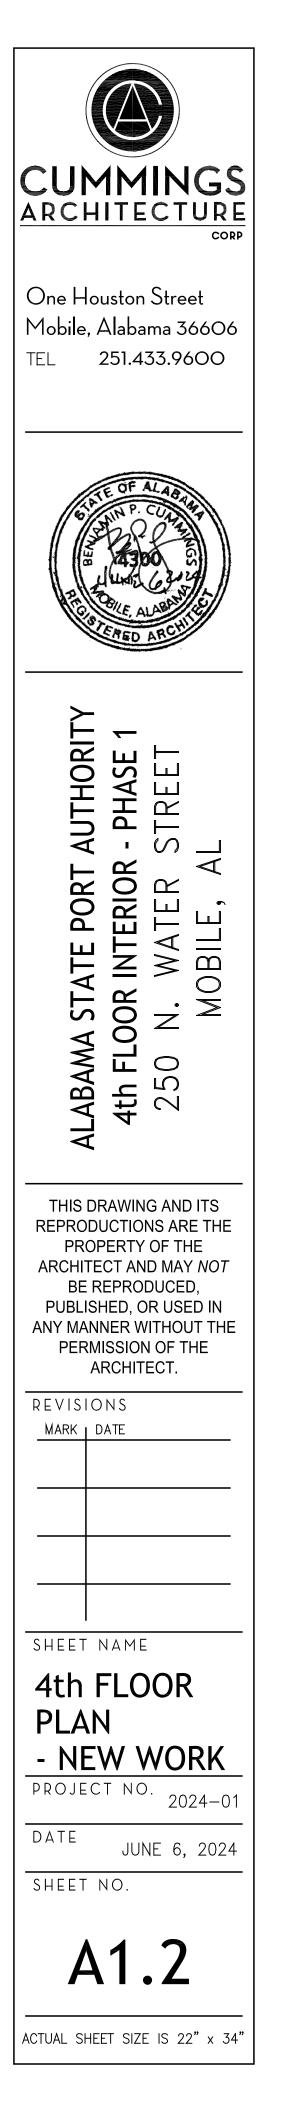


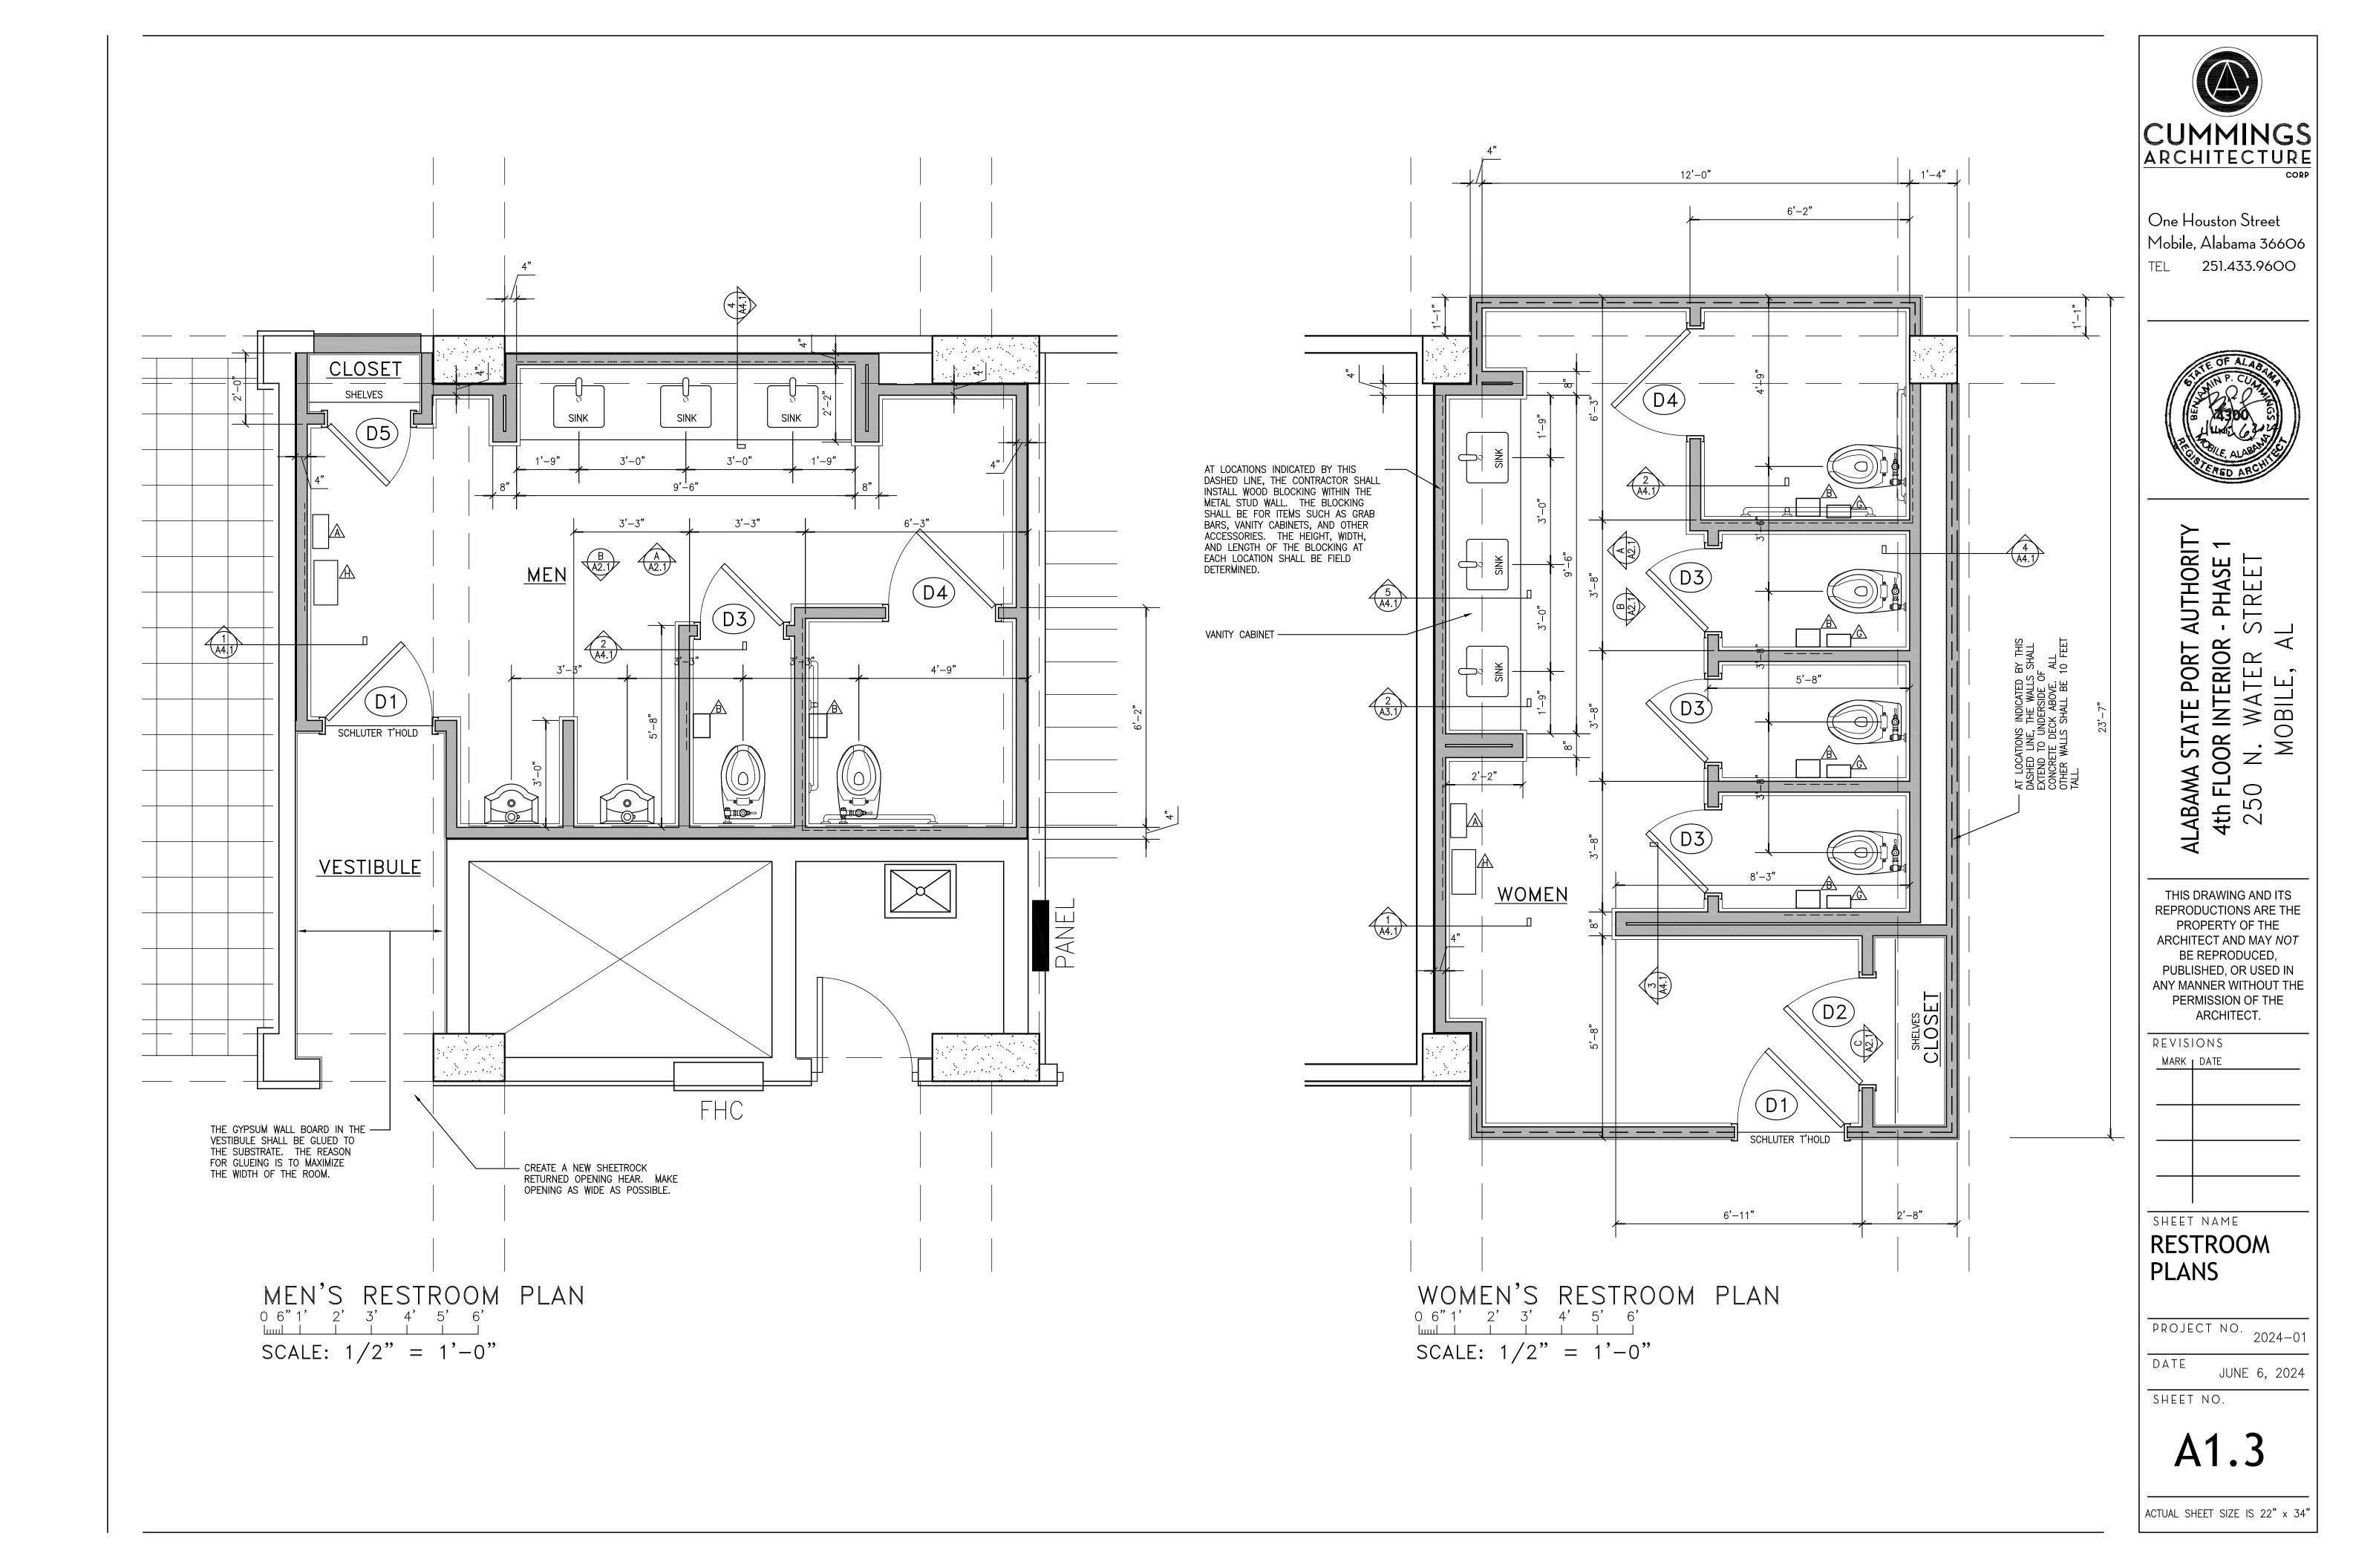


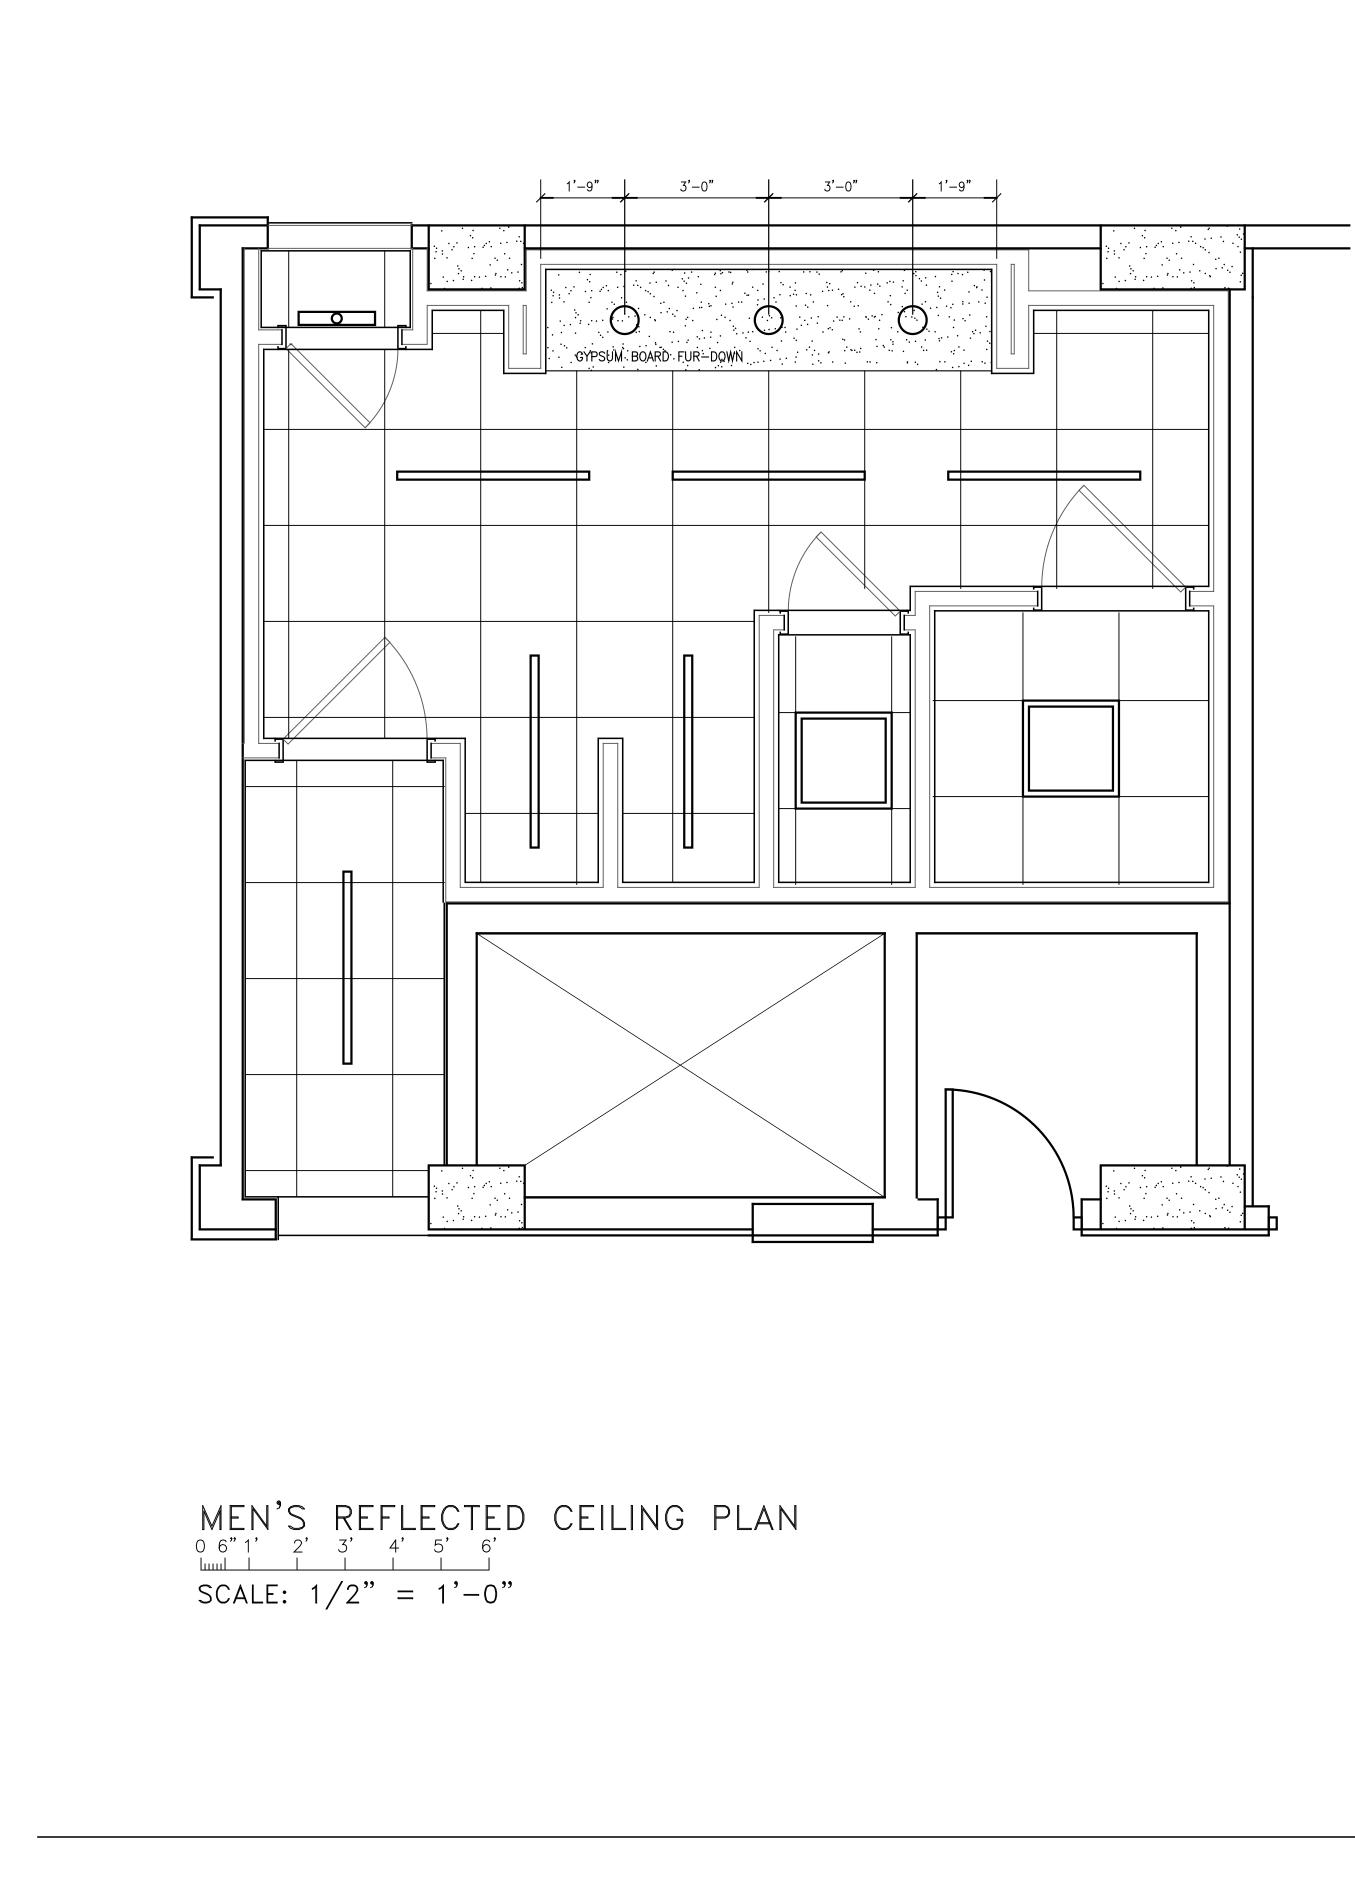


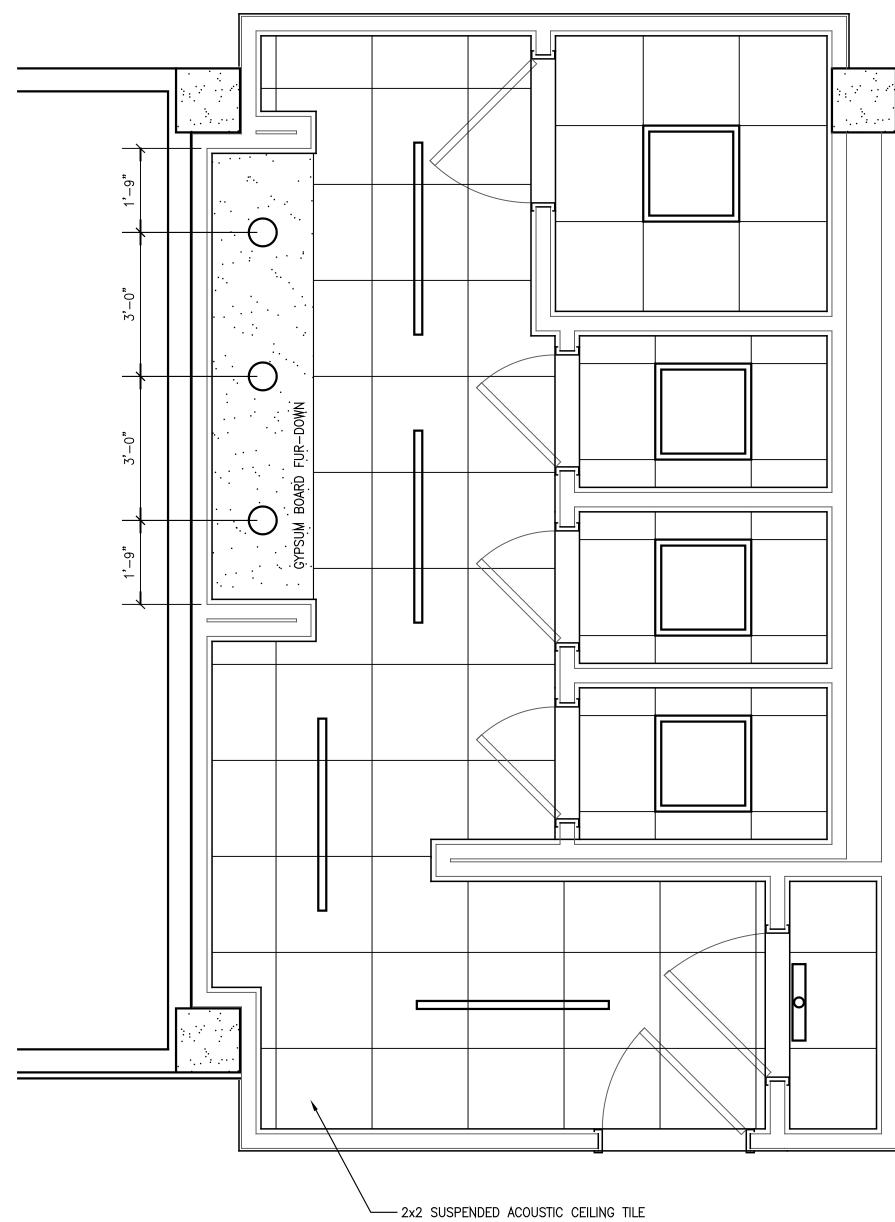

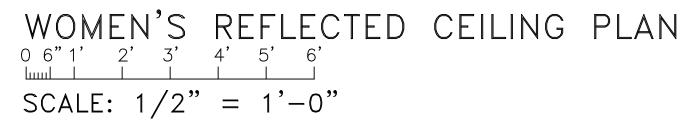

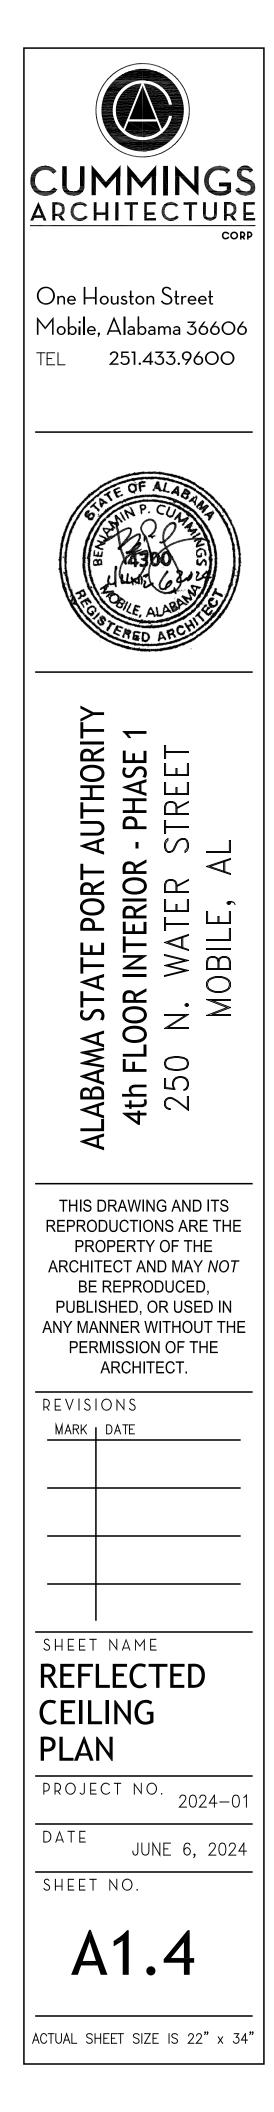


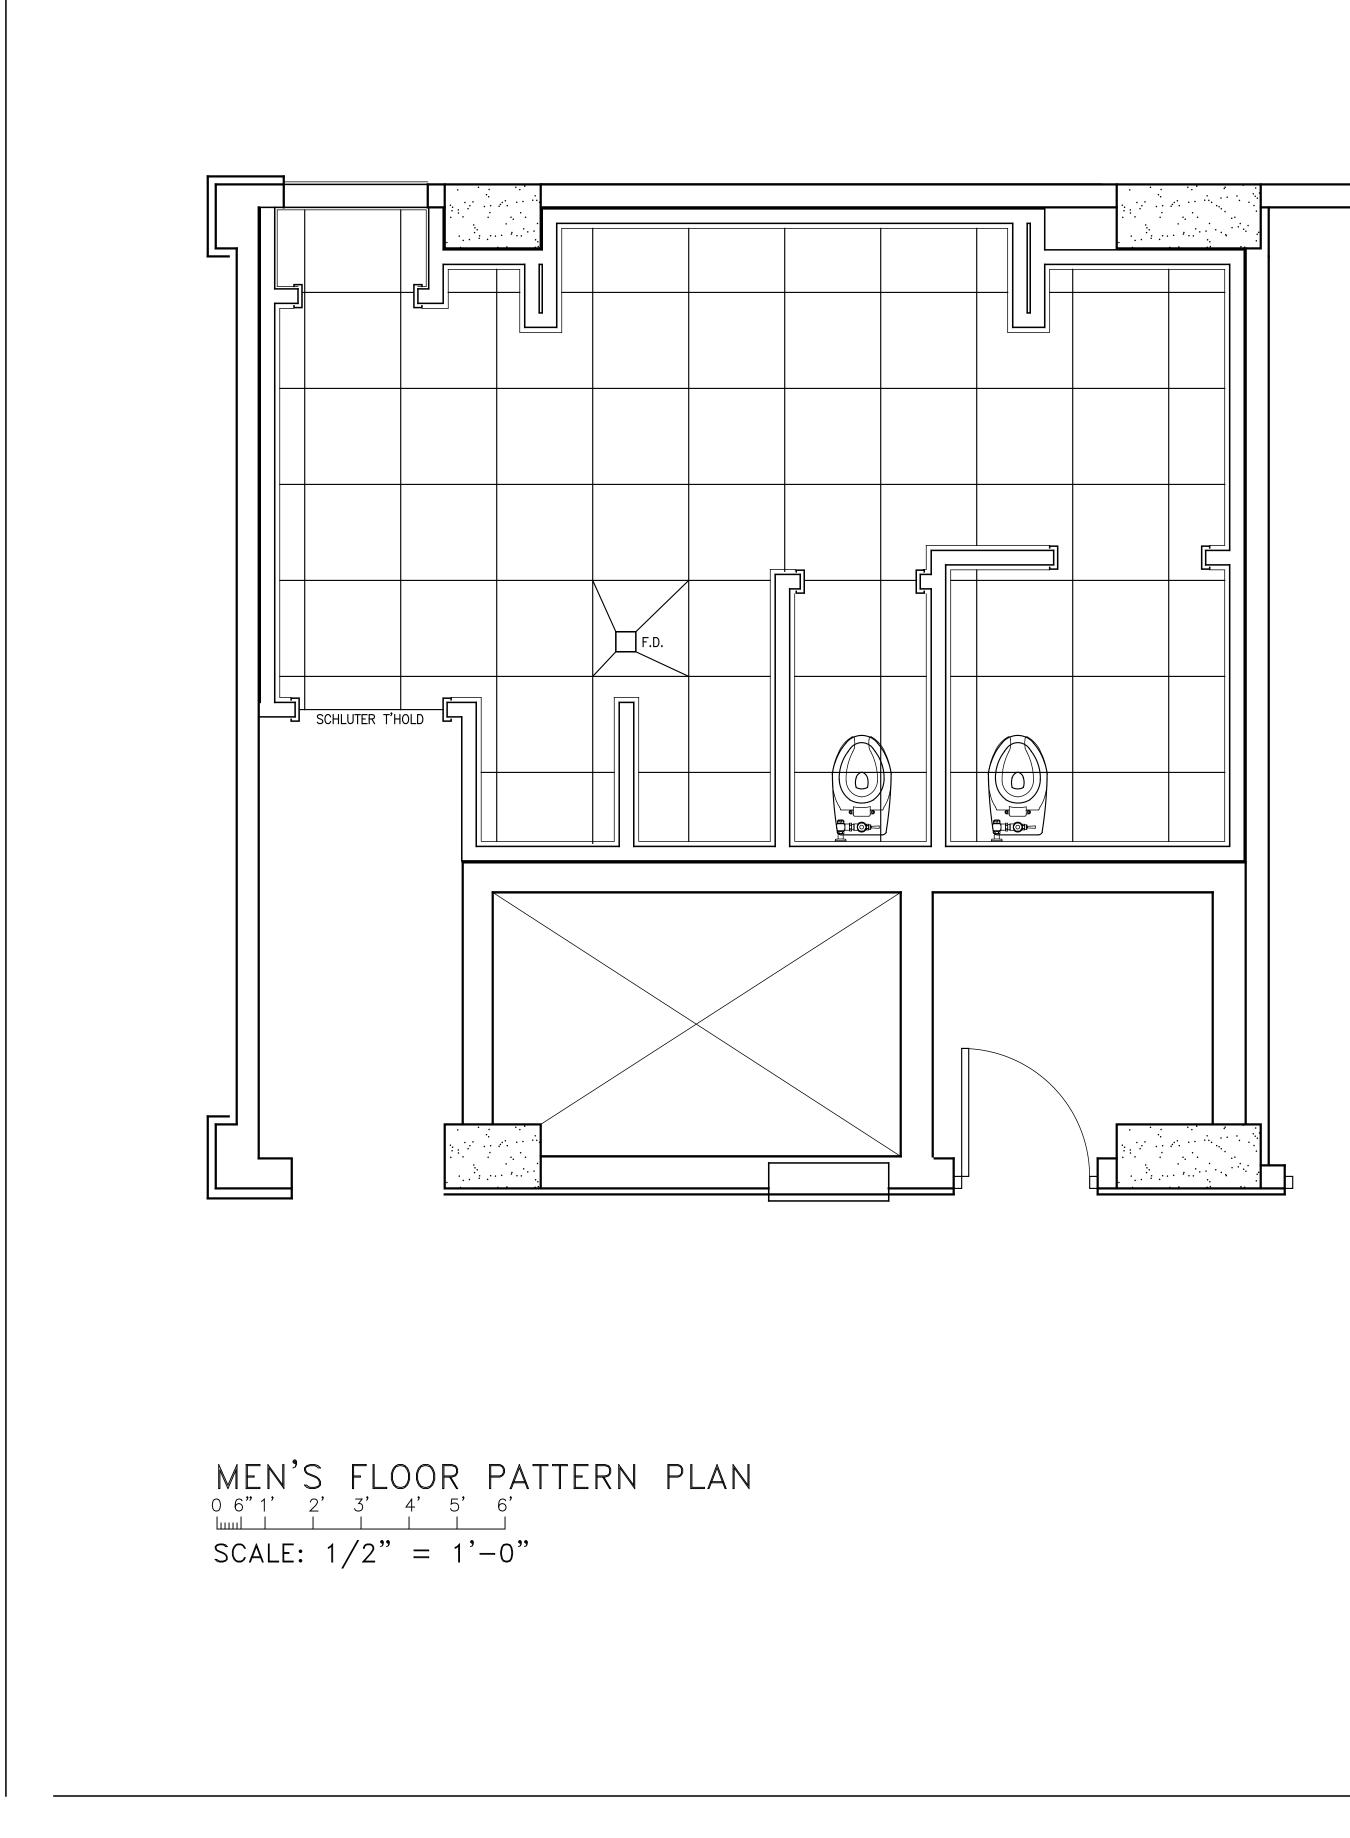


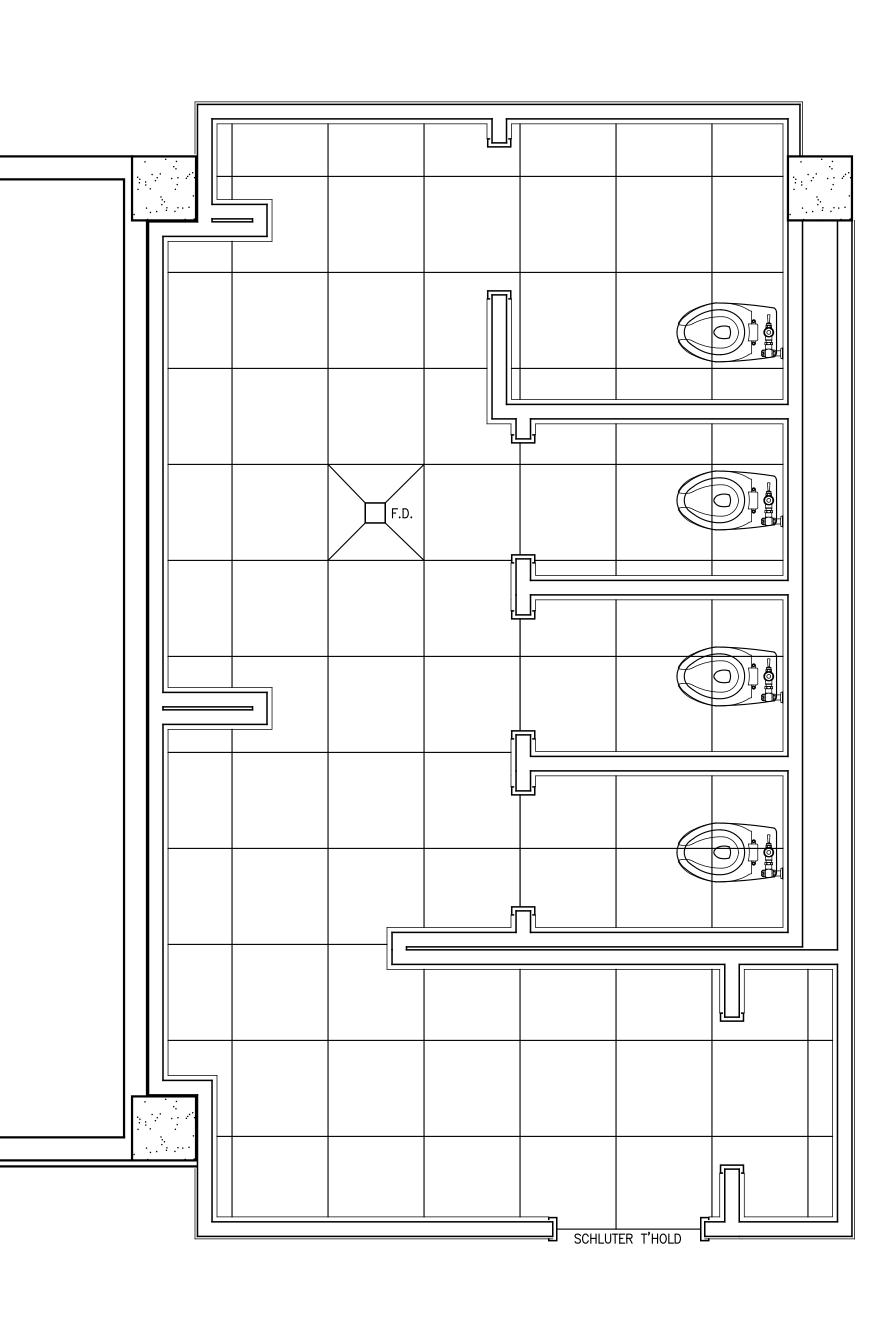



NOTE: EXCEPT FOR THE TOILET STALLS, THE 2×2 FLOOR TILE GRID PATTERN SHALL MATCH THE GRID PATTERN OF THE CEILING.

NOTE: THE JOINTS OF THE WALL TILES SHALL ALIGN WITH THE JOINTS IN THE FLOOR TILE AND THE CEILING GRID.

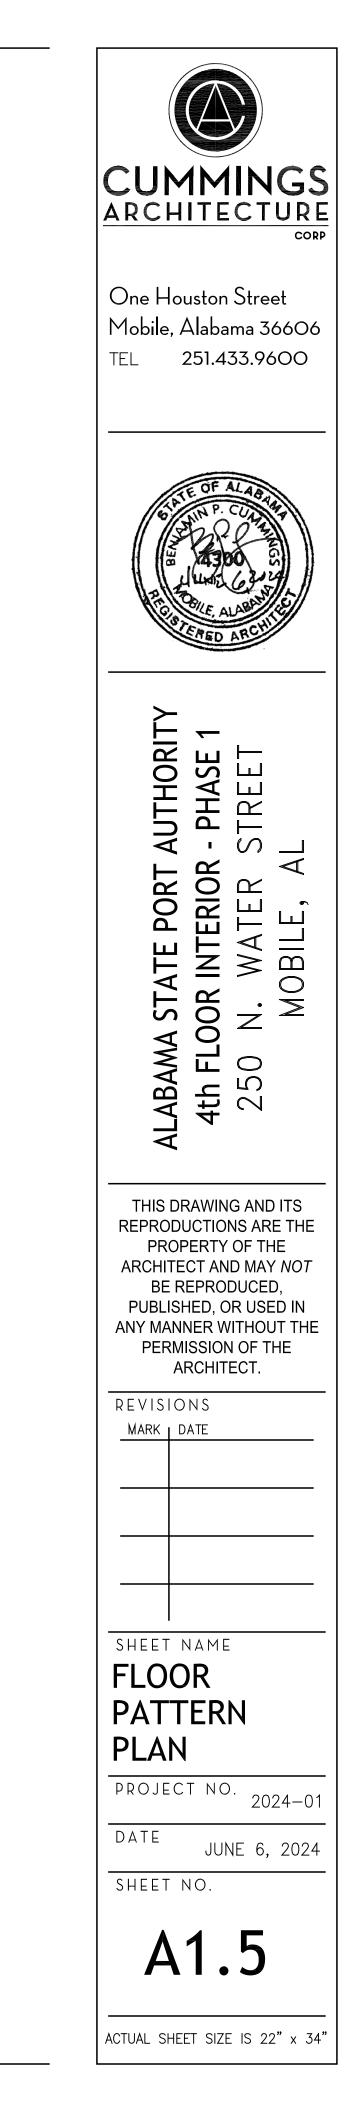

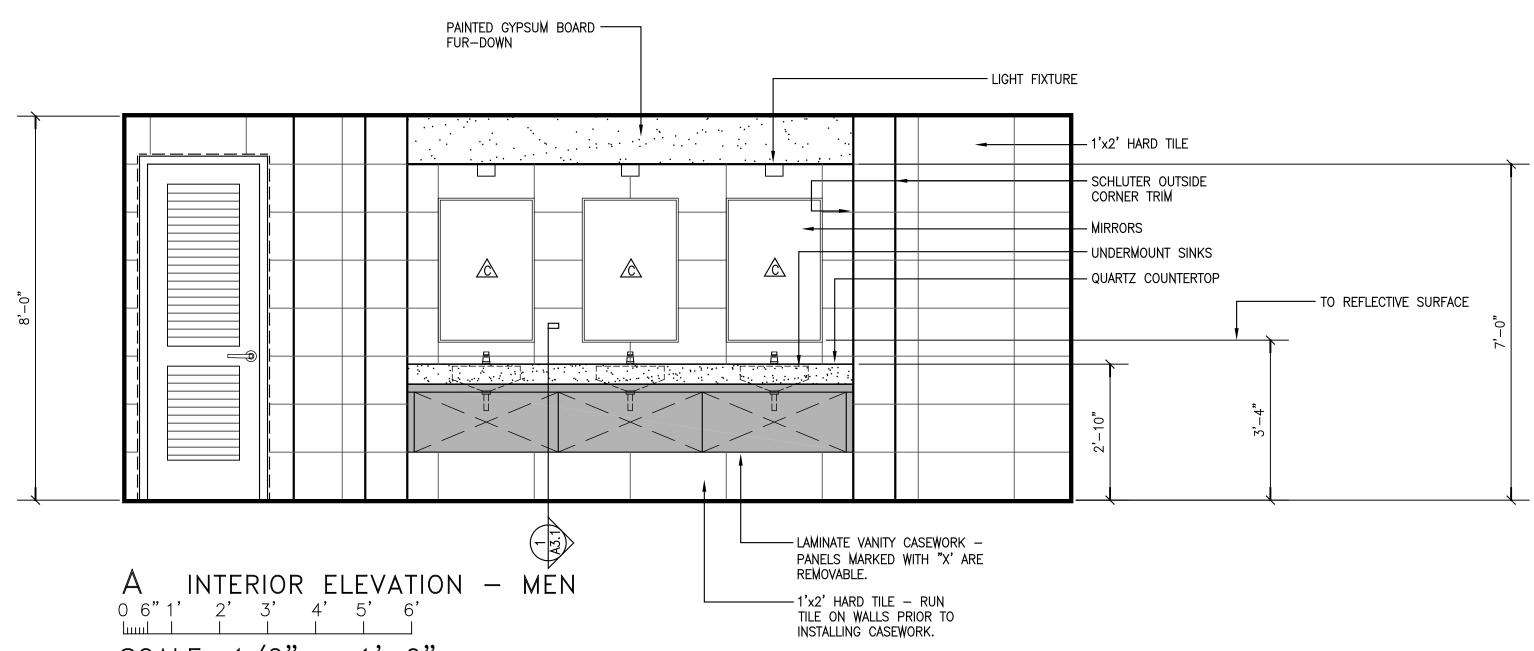


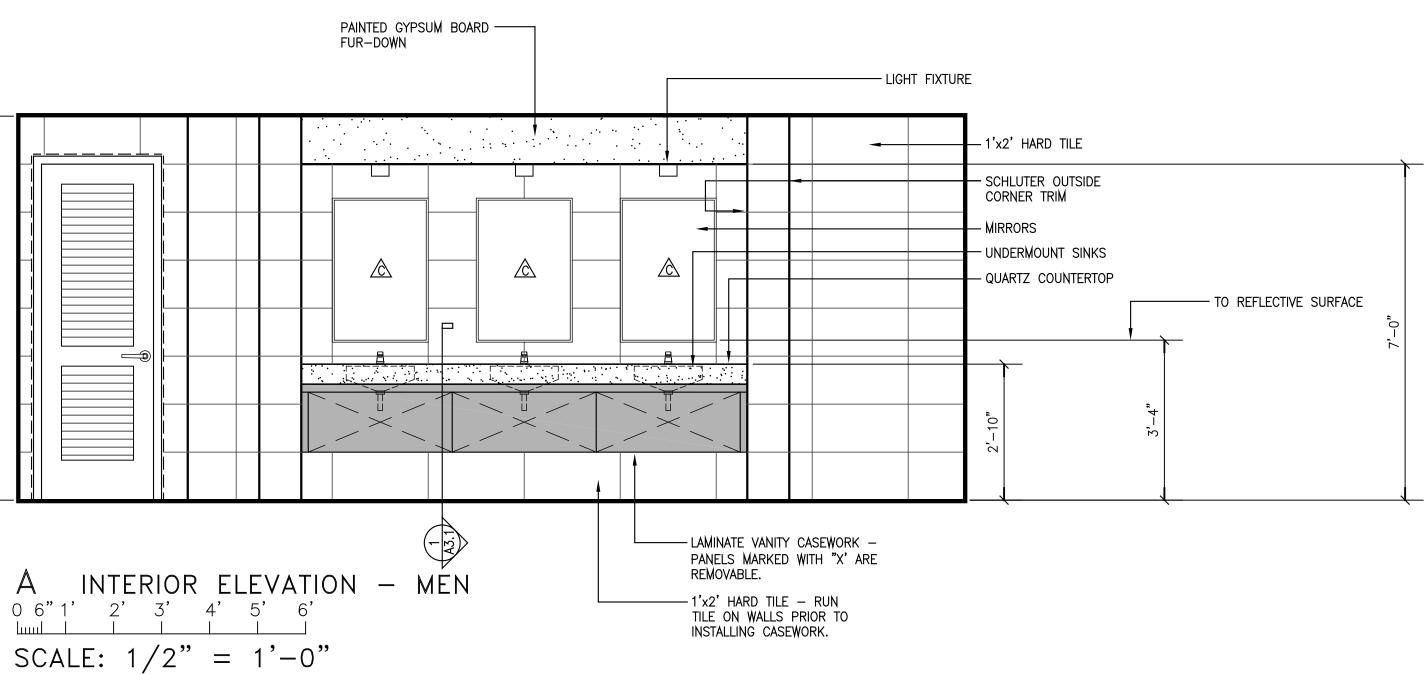


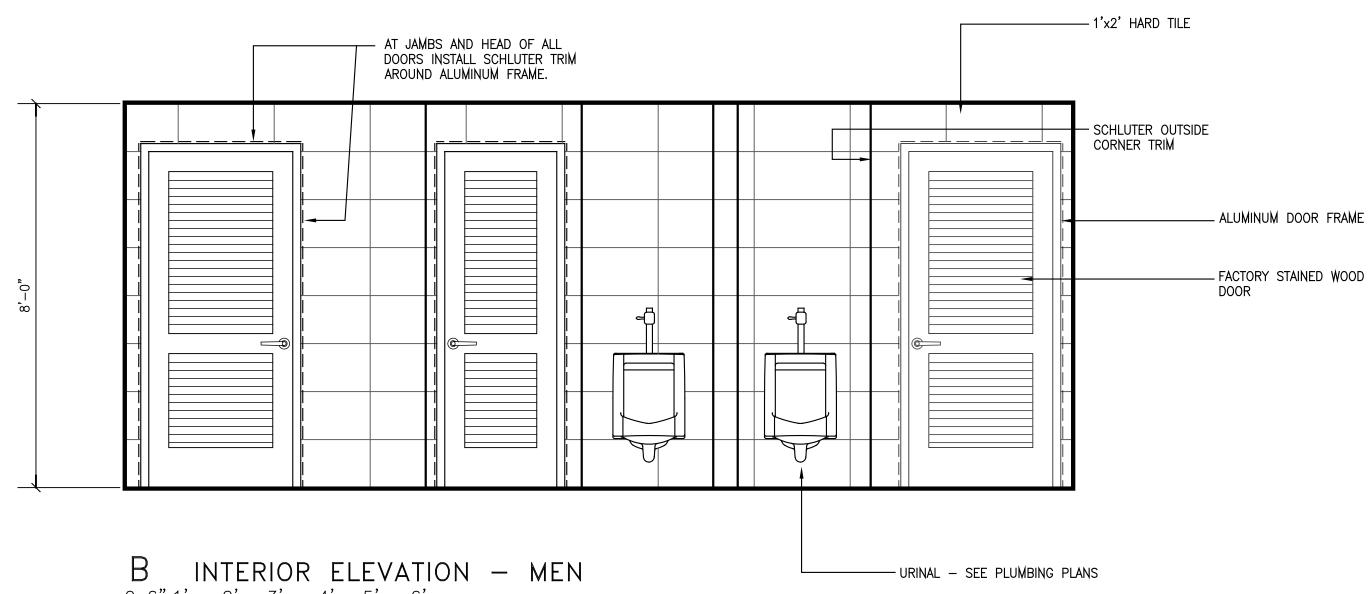


0 6" 1' 2' 3' 4' 5' 6' SCALE: 1/2" = 1'-0"



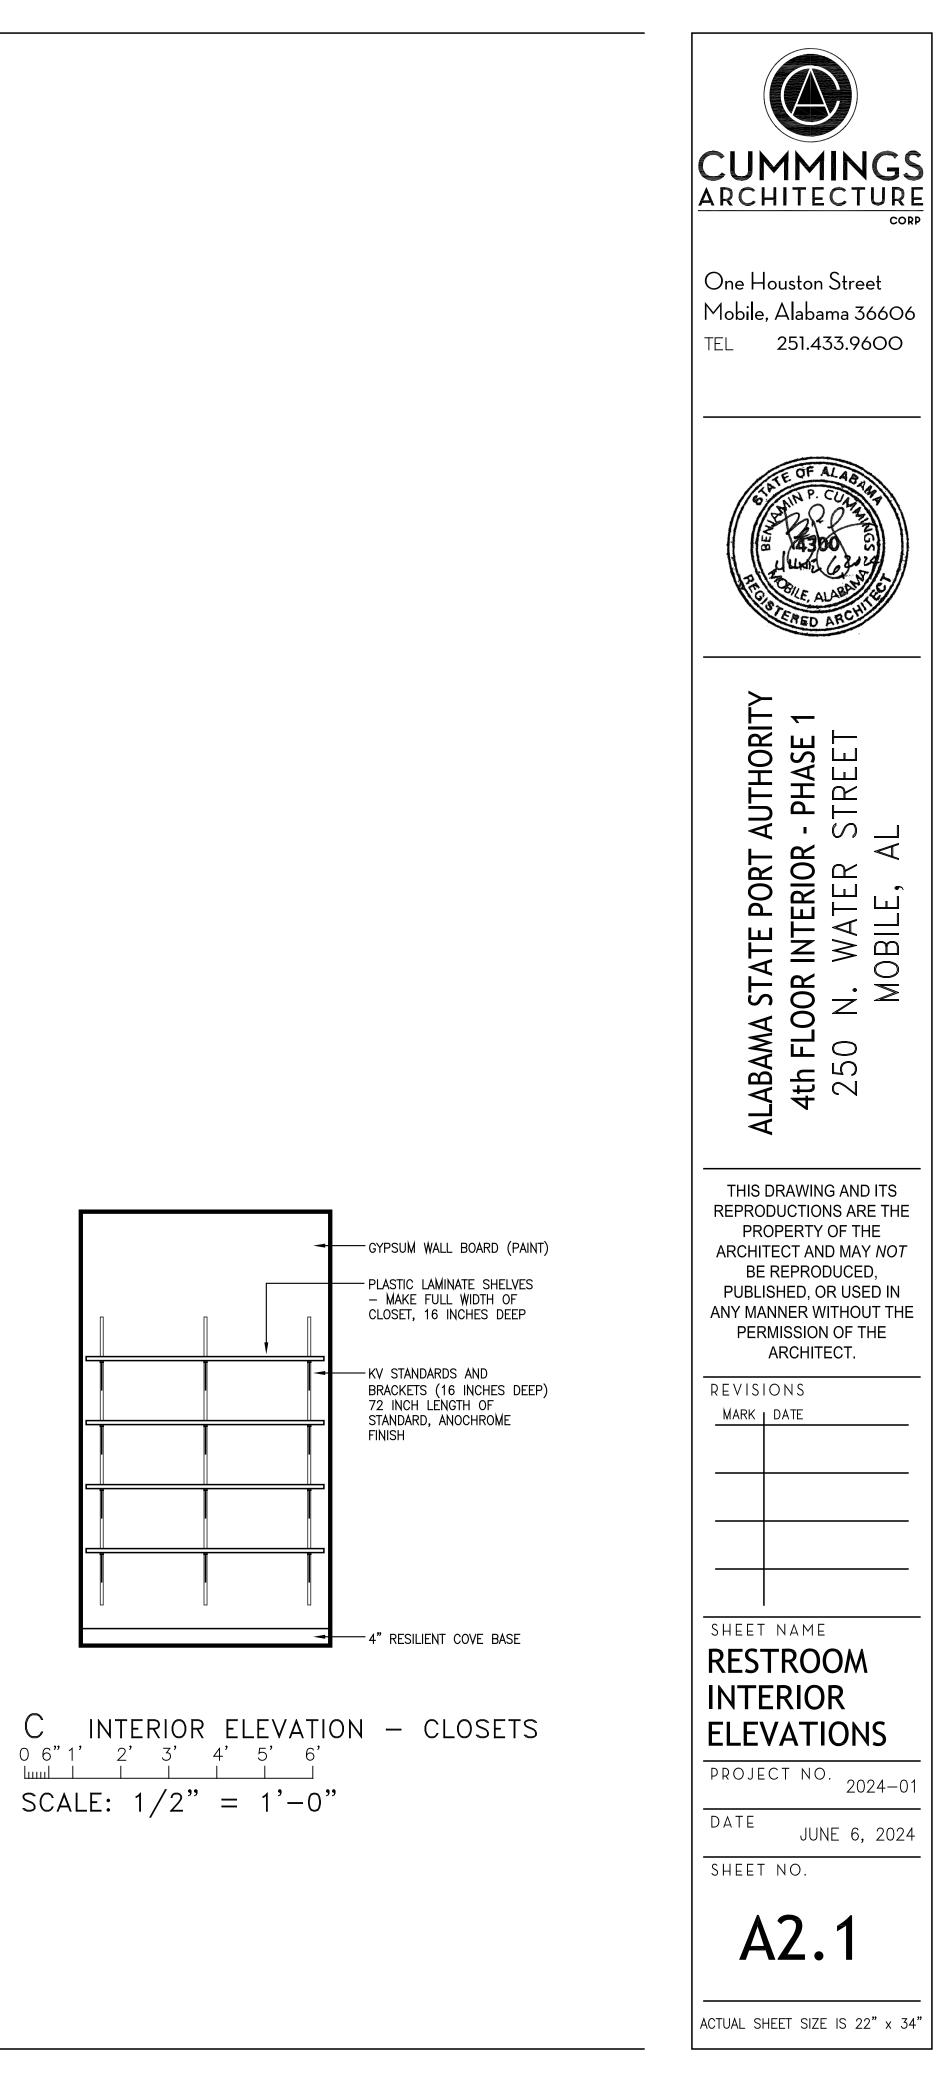


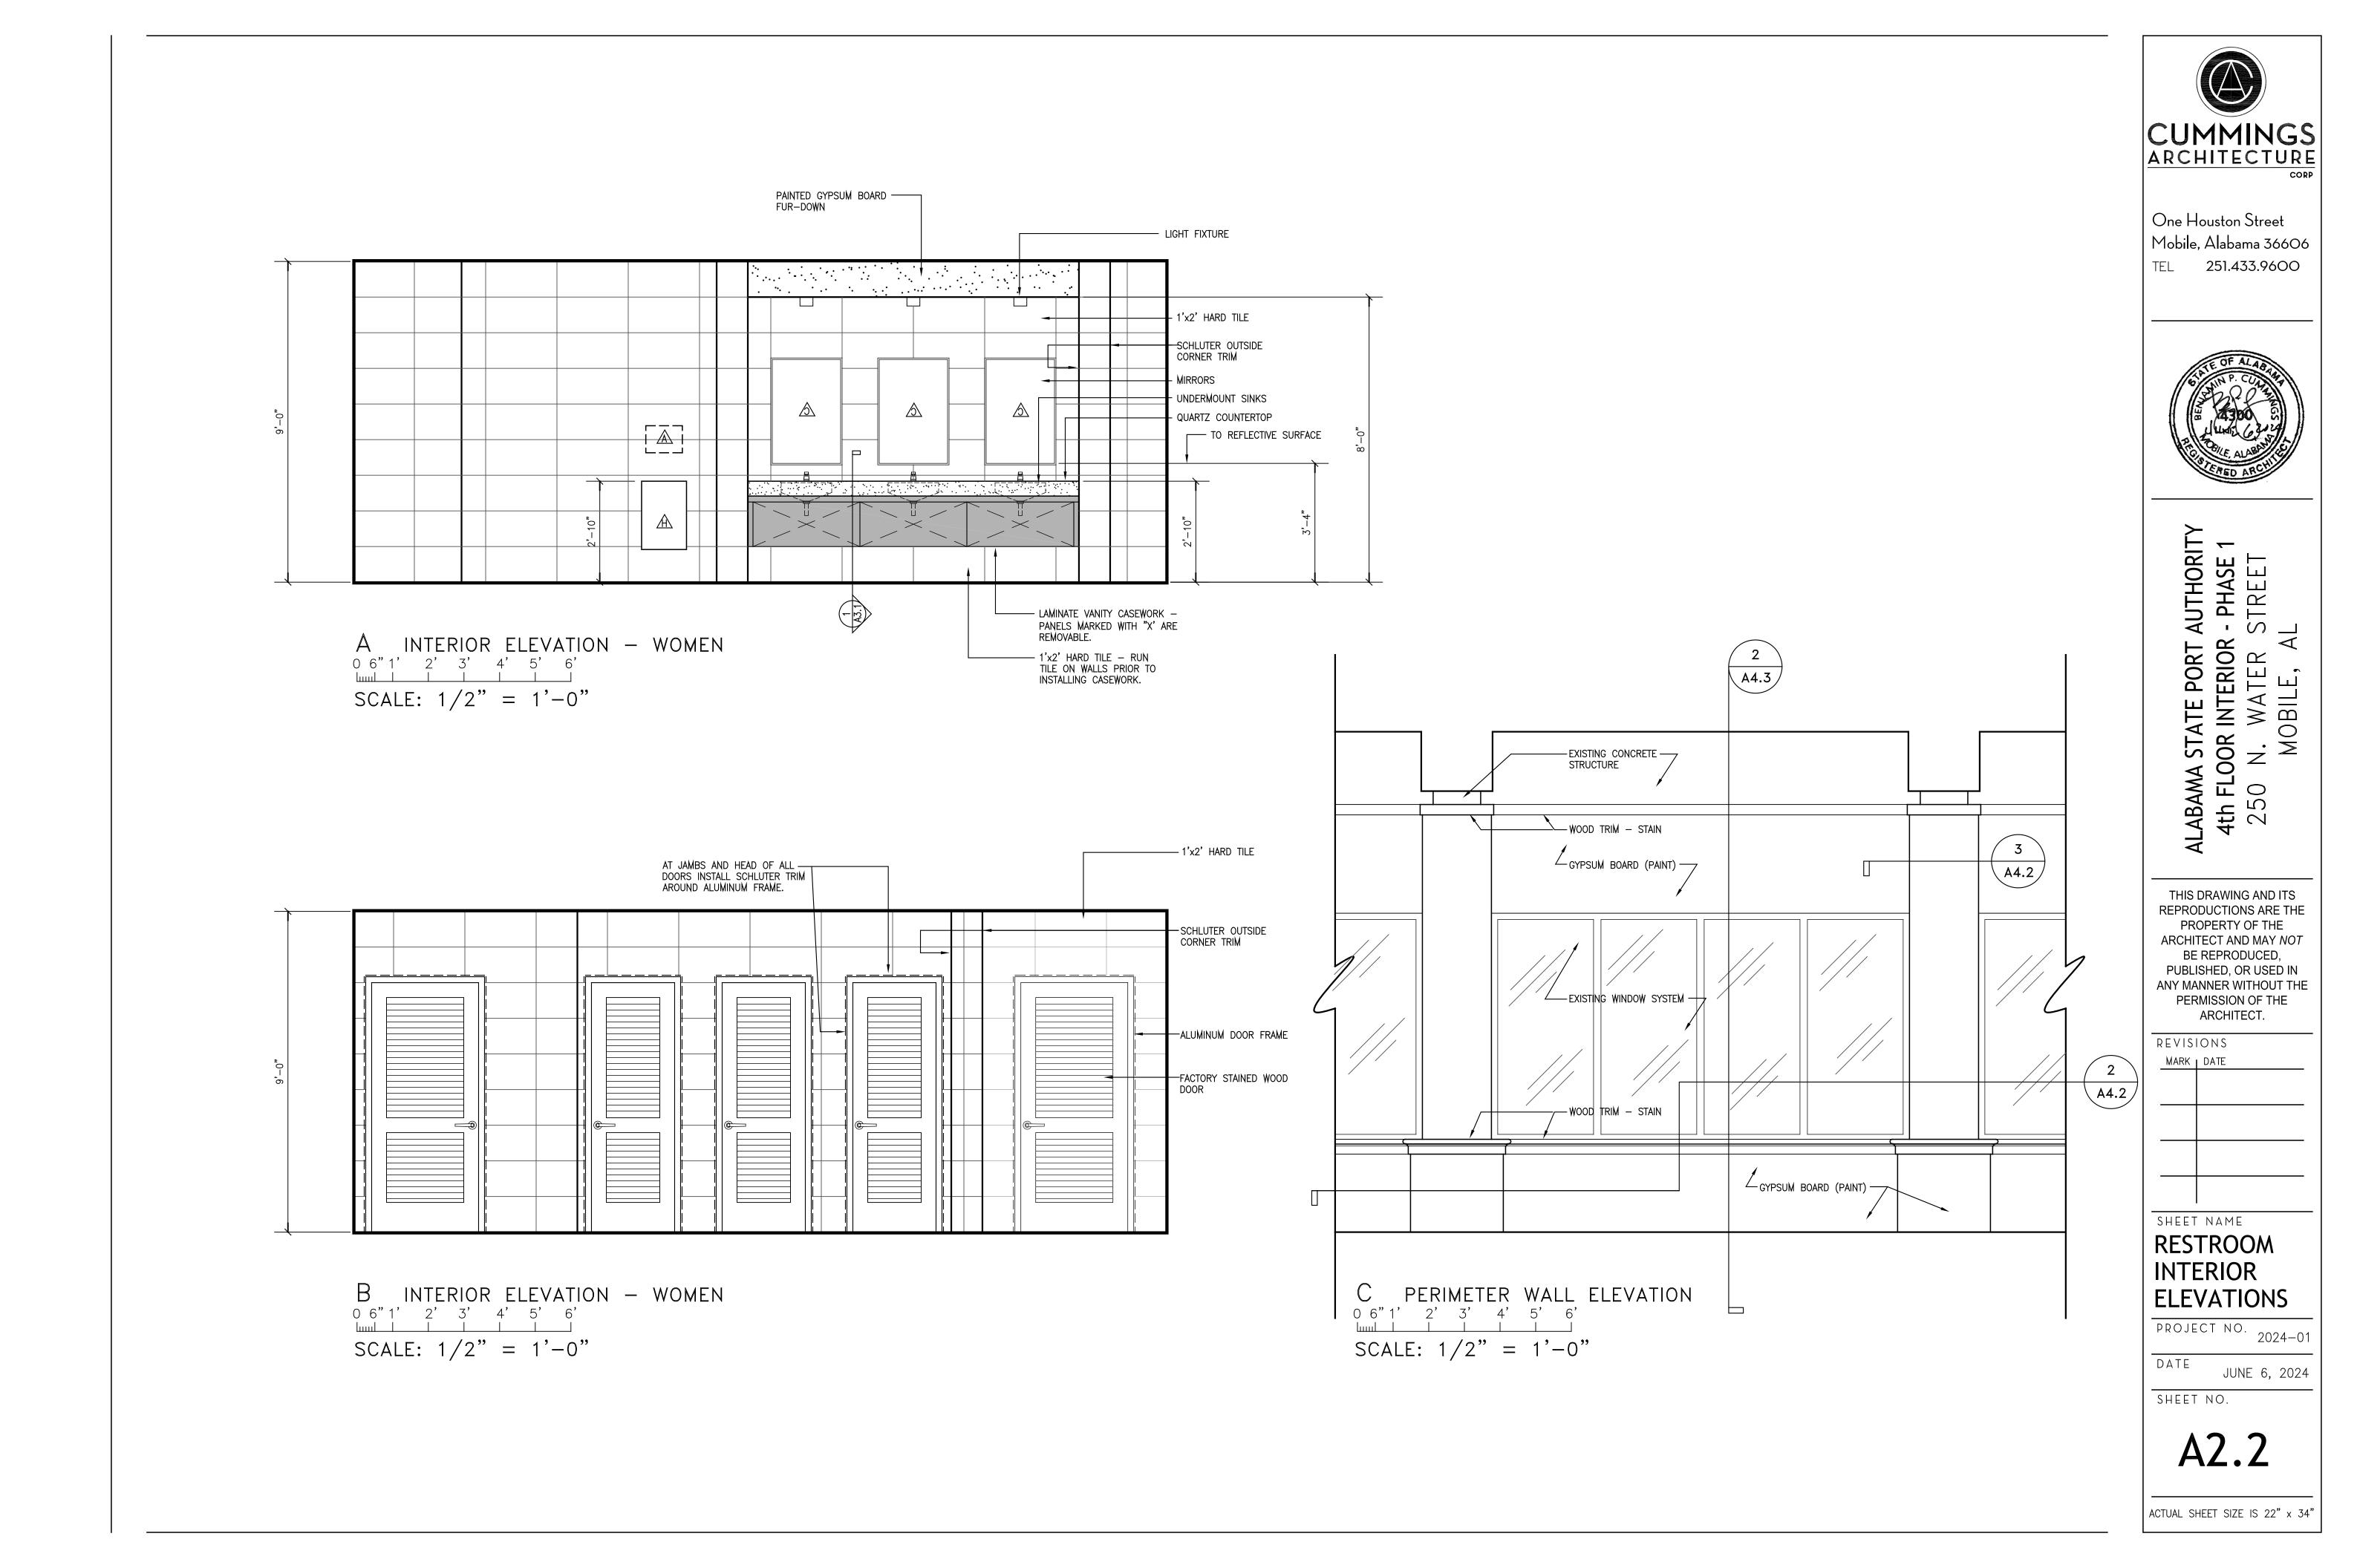


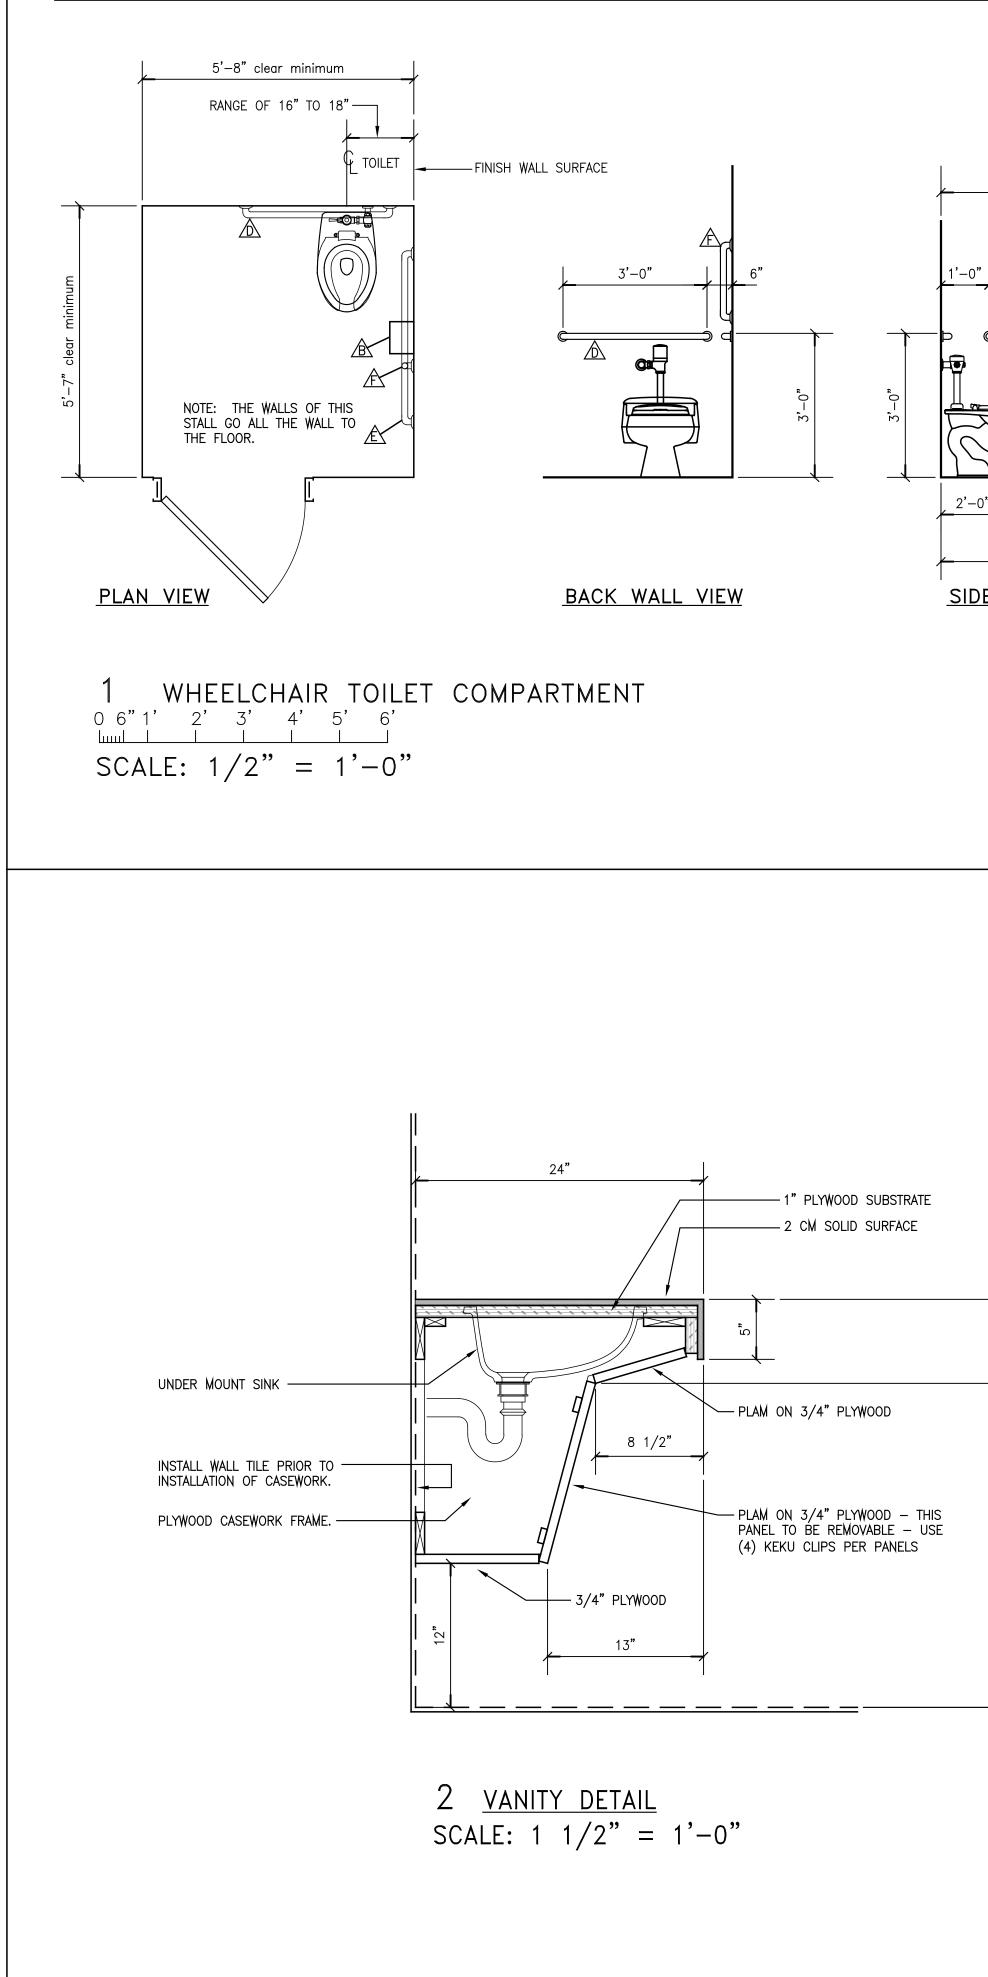



		ACCESSO	RY SCHEDULE	
	KEY	DESCRIPTION	MANUFACTURER	MODEL NUMBER
		PAPER TOWEL DISPENSER	FURNISHED AND INSTALLED BY OWNER	
、		TOILET TISSUE DISPENSER	FURNISHED AND INSTALLED BY OWNER	
3'-6" È <u></u>		MIRROR	BOBRICK	B-165 2436
		36" GRAB BAR – STAINLESS STEEL	BOBRICK	B-5806-36
	Æ	42" GRAB BAR – STAINLESS STEEL	BOBRICK	B-5806-42
5°min. 3'-4"	Æ	18" GRAB BAR – STAINLESS STEEL	BOBRICK	B-5806-18
1'-6"min		SANITARY NAPKIN DISPOSAL	BOBRICK	B – 270
LOCATION OF SURFACE		SURFACE MOUNTED WASTE RECETACLE	BOBRICK	B – 277
nax. ACCESSORIES				
<u>_</u>	• FL PA SI • GI • GI • GI HARD TILE (• 12 • IN M	TONE POLYMER—MODIFIED LARGE & HEAV OOR TILE AND WALL TILE GROUT LINES ATTERN, MEANING THAT THE SQUARE PAT HALL BE THE SAME. ROUT JOINT LINES TO BE 1/8". ROUT SHALL BE BOSTIK 1900 EPOXY MC IN MEN AND WOMEN RESTROOMS AND S 2" x 24" HARD TILE: <u>BPI —MILESTONE S</u> STALL NEW TILE USING SCHLUTER WATER DISTURE RESISTANT GYPSUM WALL BOARE ANDEACTURES INSTRUCTIONS	SHALL ALIGN. FLOOR PAT TERN AT THE CEILING AND DIFIED GROUT, COLOR: <u>STO</u> TALLS) <u>FONE, FARMHOUSE LIVING,</u> PROOFING SYSTEM. INSTA D. FLASH KERDI TO FLOOR	TERN SHALL MATCH THE CEILING TILE THE SQUARE PATTERN AT THE FLOOF <u>ORM H198</u> <u>ALABASTER MATTE</u> LL SCHLUTER KERDI PRODUCT OVER USING KERDI BAND STRIPS. INSTALI
	M(• FL • GI	ANUFACTURERS INSTRUCTIONS. USE BOS ORTAR. .OOR TILE AND WALL TILE GROUT LINES ROUT JOINT LINES TO BE 1/8". ROUT SHALL BE BOSTIK 1900 EPOXY MC	SHALL ALIGN.	
	• 5, • Pf • Sf	L BOARD (IN CLOSETS, FUR—DOWN ABO /8" MOISTURE RESISTANT GYPSUM WALL RIME AND PAINT HEEN: EGGSHELL DLOR: SHERWIN WILLIAMS, 6105 DIVINE	BOARD.	
5	SCHLUTER TRIM PROVIDE ANI • FL • IN • OI • AF	D INSTALL SCHLUTER STAINLESS STEEL T OOR TO WALL (BASE): SCHLUTER DILEX SIDE CORNERS OF WALLS: SCHLUTER DIL TSIDE CORNERS OF WALLS AND END CA ROUND DOOR FRAMES: SCHLUTER SCHIEN ROVIDE INSIDE AND OUTSIDE CORNER TRI	RIM AT THE FOLLOWING LC AHK 1S 100 .EX AHK 1S 100 .PS: SCHLUTER SCHIENE IE	CATIONS:
	2 x 2 ACOU • GI • TI	ROOMS AND CLOSETS) ISTIC SUSPENDED CEILING SYSTEM RID: ARMSTRONG, PRELUDE XL 15/16", LE CEILINGS: ARMSTRONG, 2×2, DUNE DORDINATE GRID LAYOUT WITH FLOOR TIL	E, 15/16" ANGLED TEGULA	R EDGE RID AND THE FLOOR TILE SHALL ALIC
<u>↓</u>	RESILIENT BASE (I 4 INCH COV	N CLOSETS ONLY) E BASE, JOHNSONITE, GREY HAZE \G		
	COUNTERTOF	<u>R</u> (IN RESTROOMS) 9 AND BACKSPLASH: CORIAN QUARTZ, 2 9 SINK: PLASTIC LAMINATE: FORMICA, 1		
	LAMINATE SHELVES	(IN CLOSETS)	, 010 ⁻ 00 N	
		INATE: EODMICA NEUTON MUTE OF	58 MATTE EINICH	
	PLASTIC LAM	INÀTE: FORMÍCA, NEUTRAL WHITE, 918–	58 MATTE FINISH	


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One Houston Street
Mobile, Alabama 36606 TEL 251.433.9600
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REVISIONS MARK DATE
sheet name FINISH
SCHEDULE
and DETAILS
PROJECT NO. 2024-01
JUNE 6, 2024
A3.1
ACTUAL SHEET SIZE IS 22" x 34

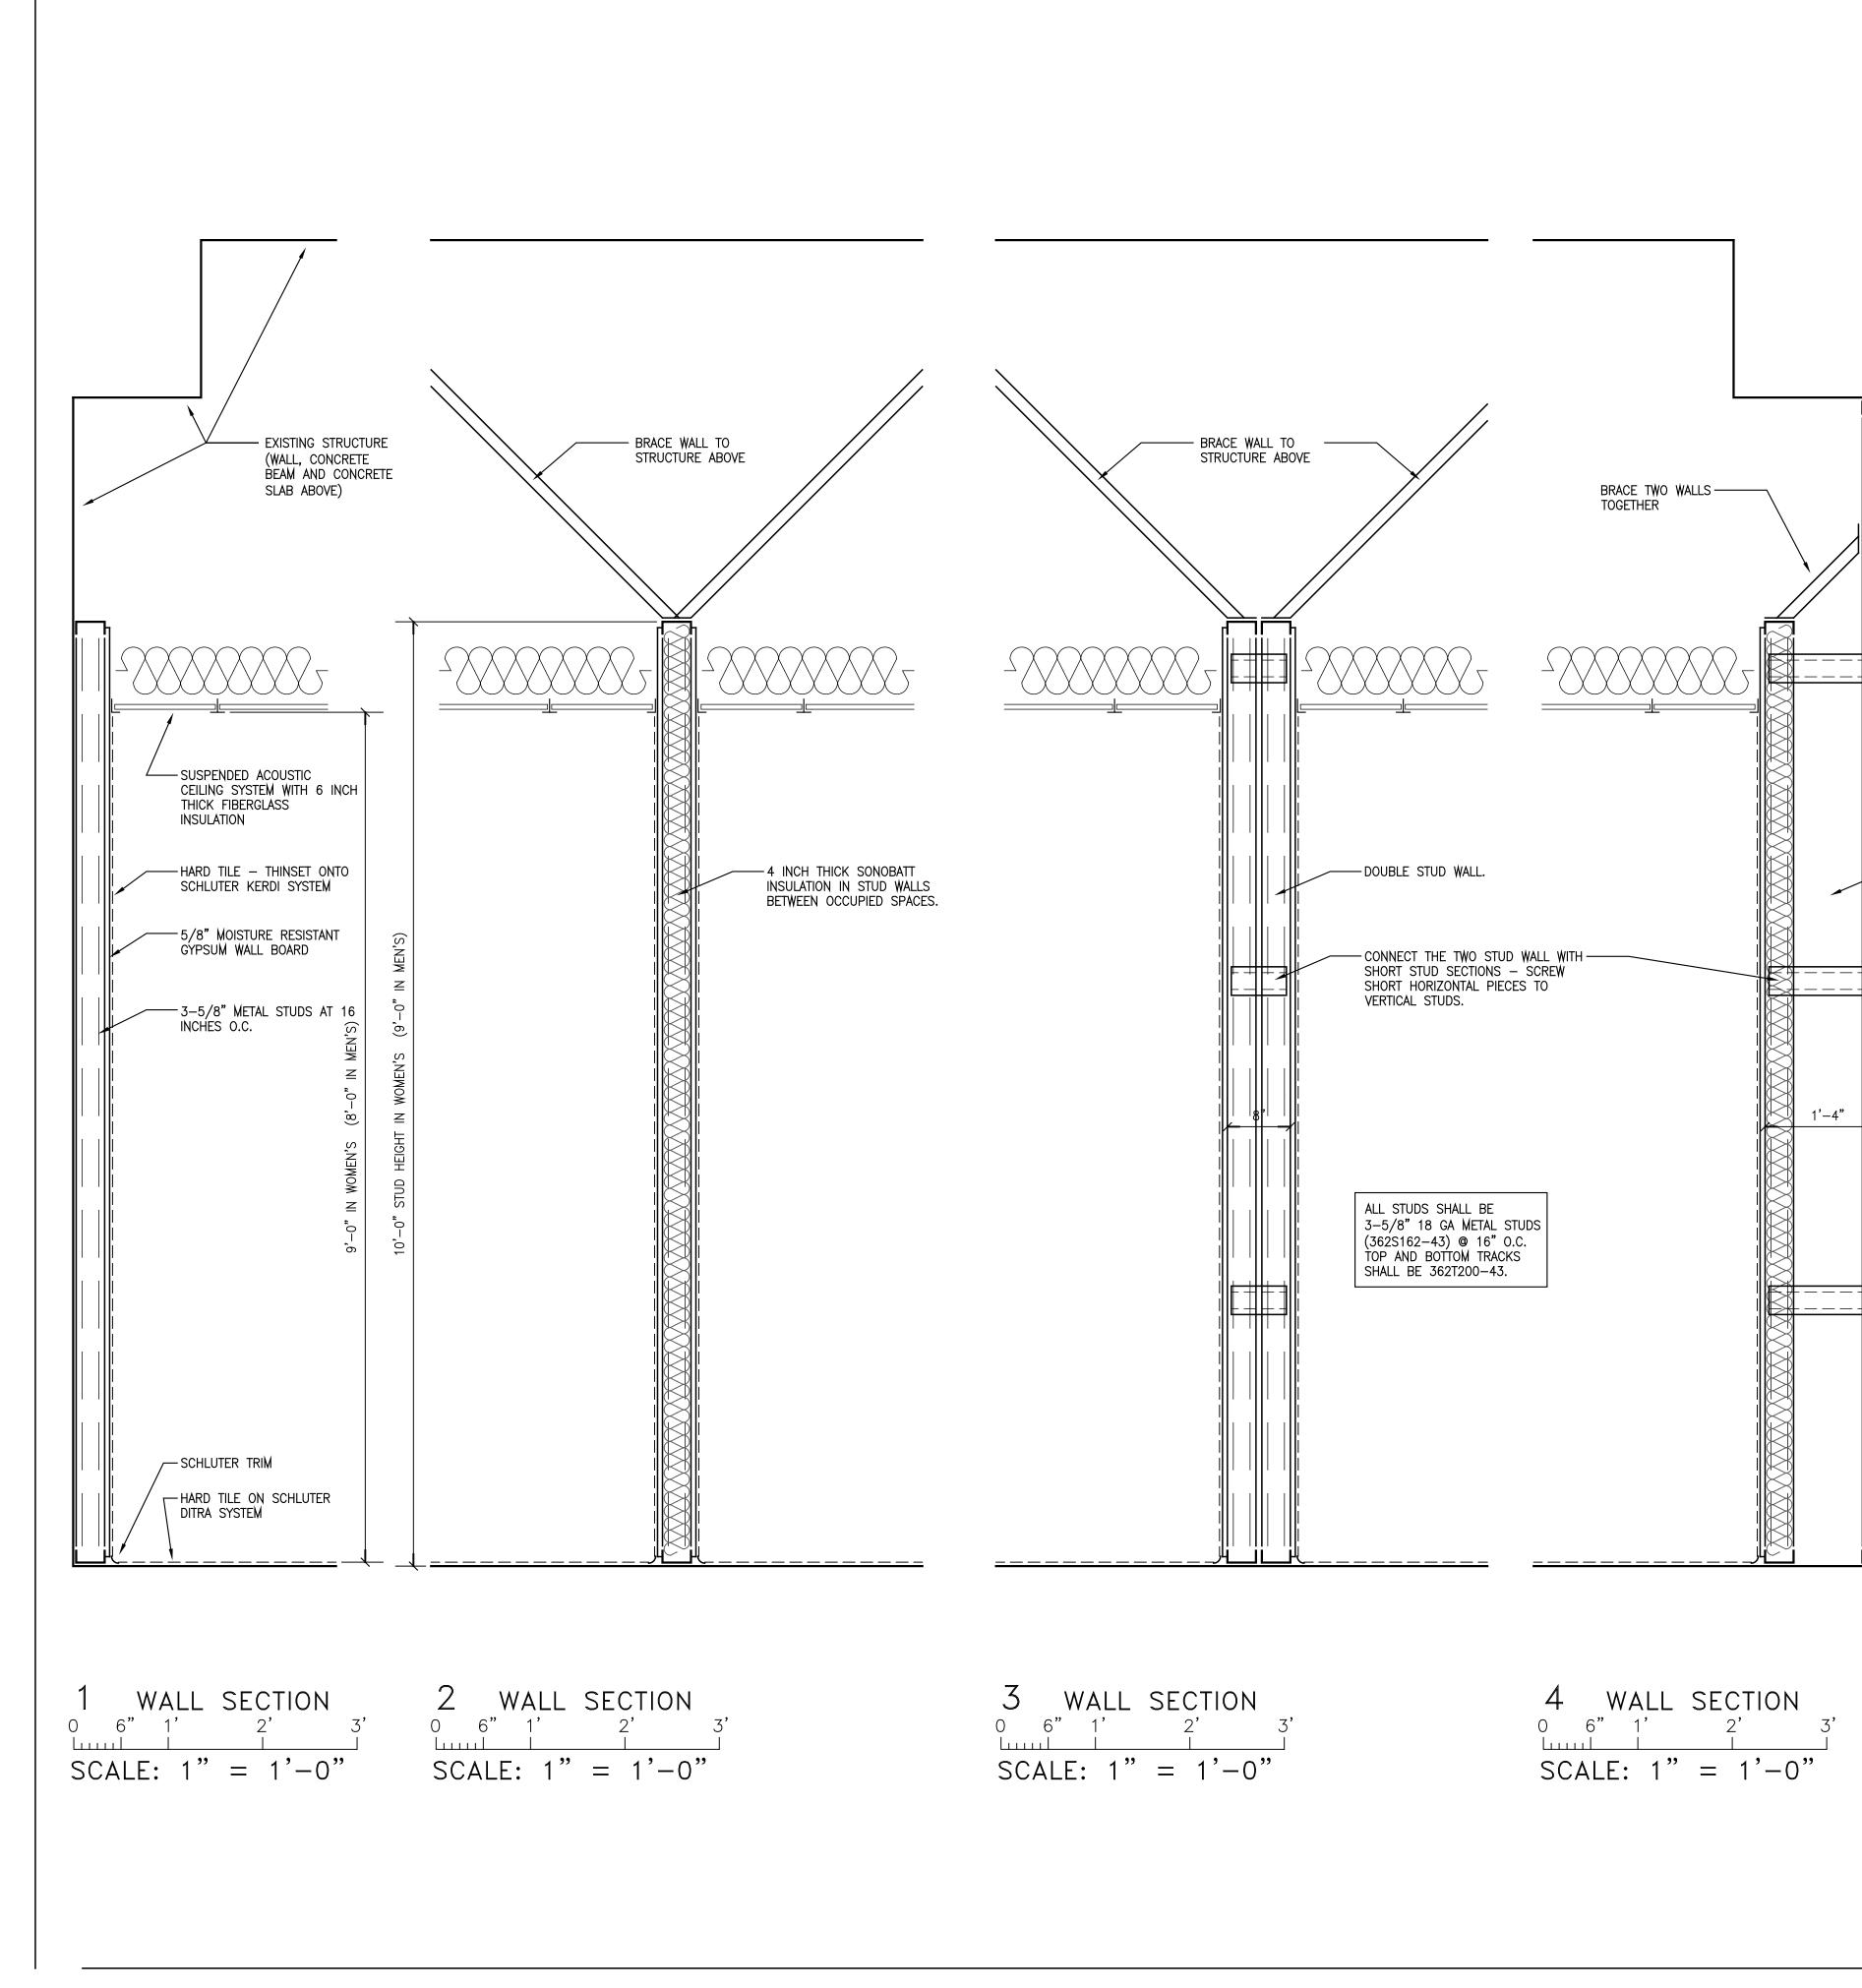


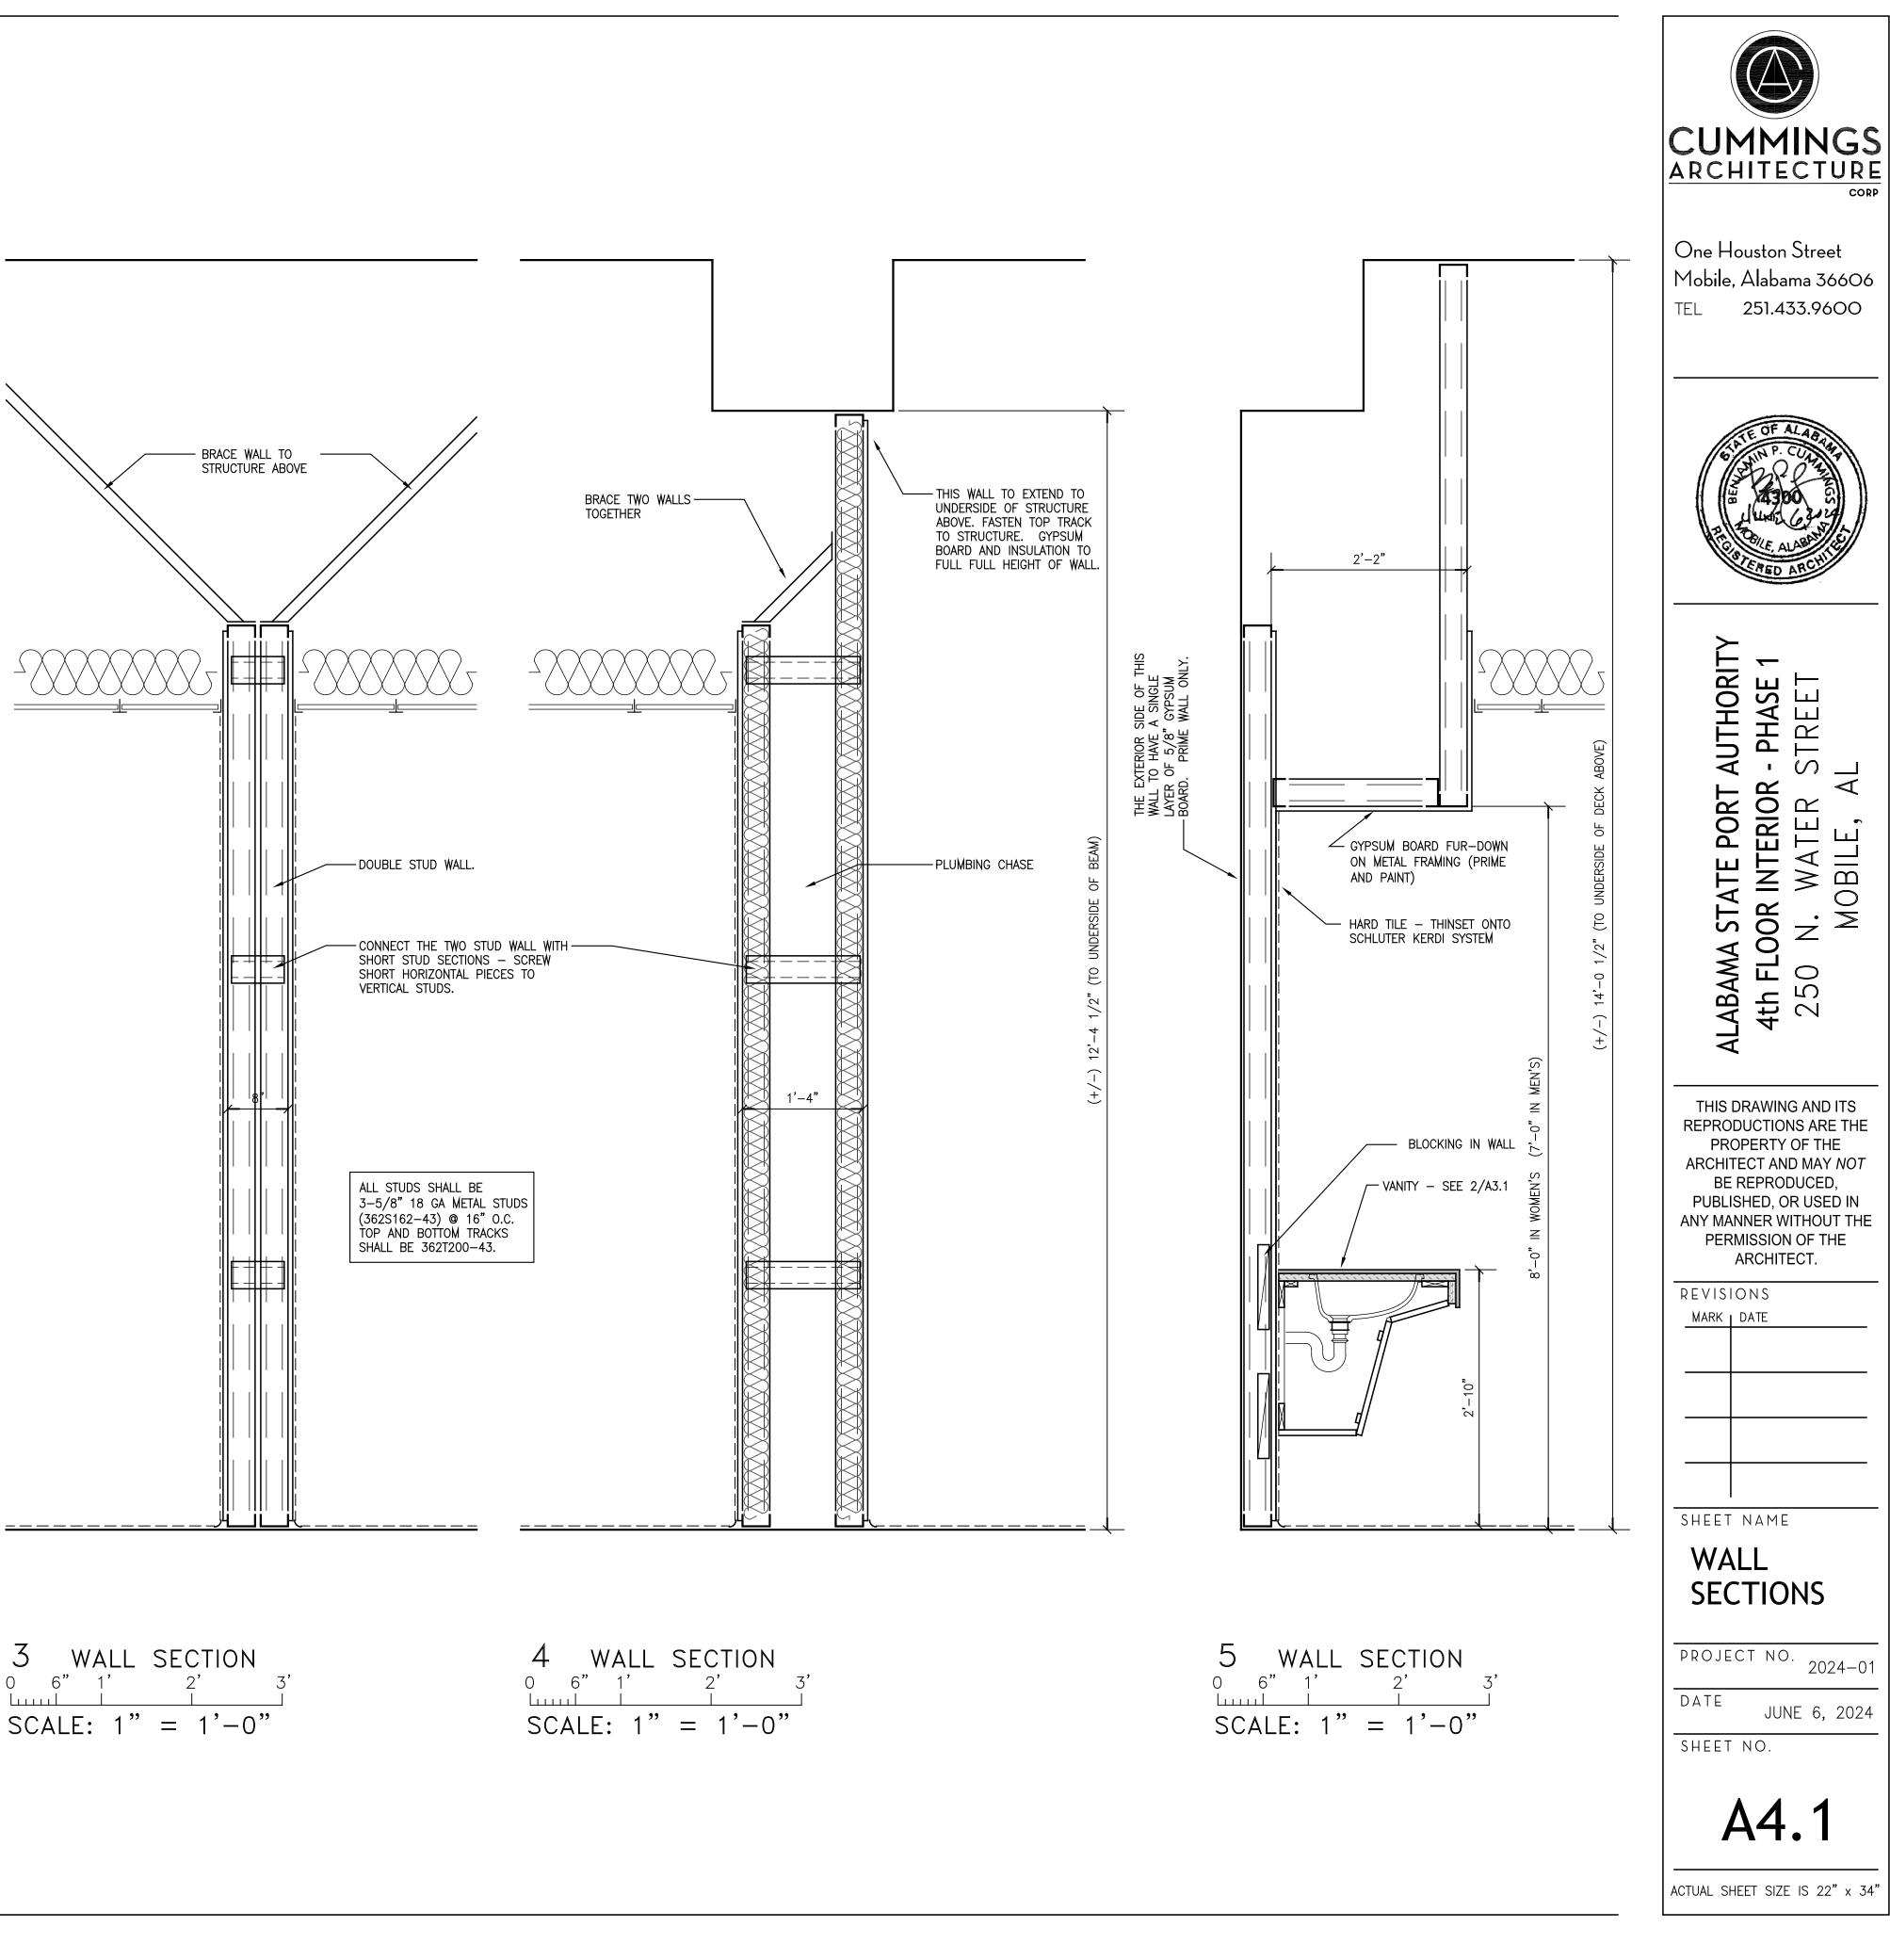

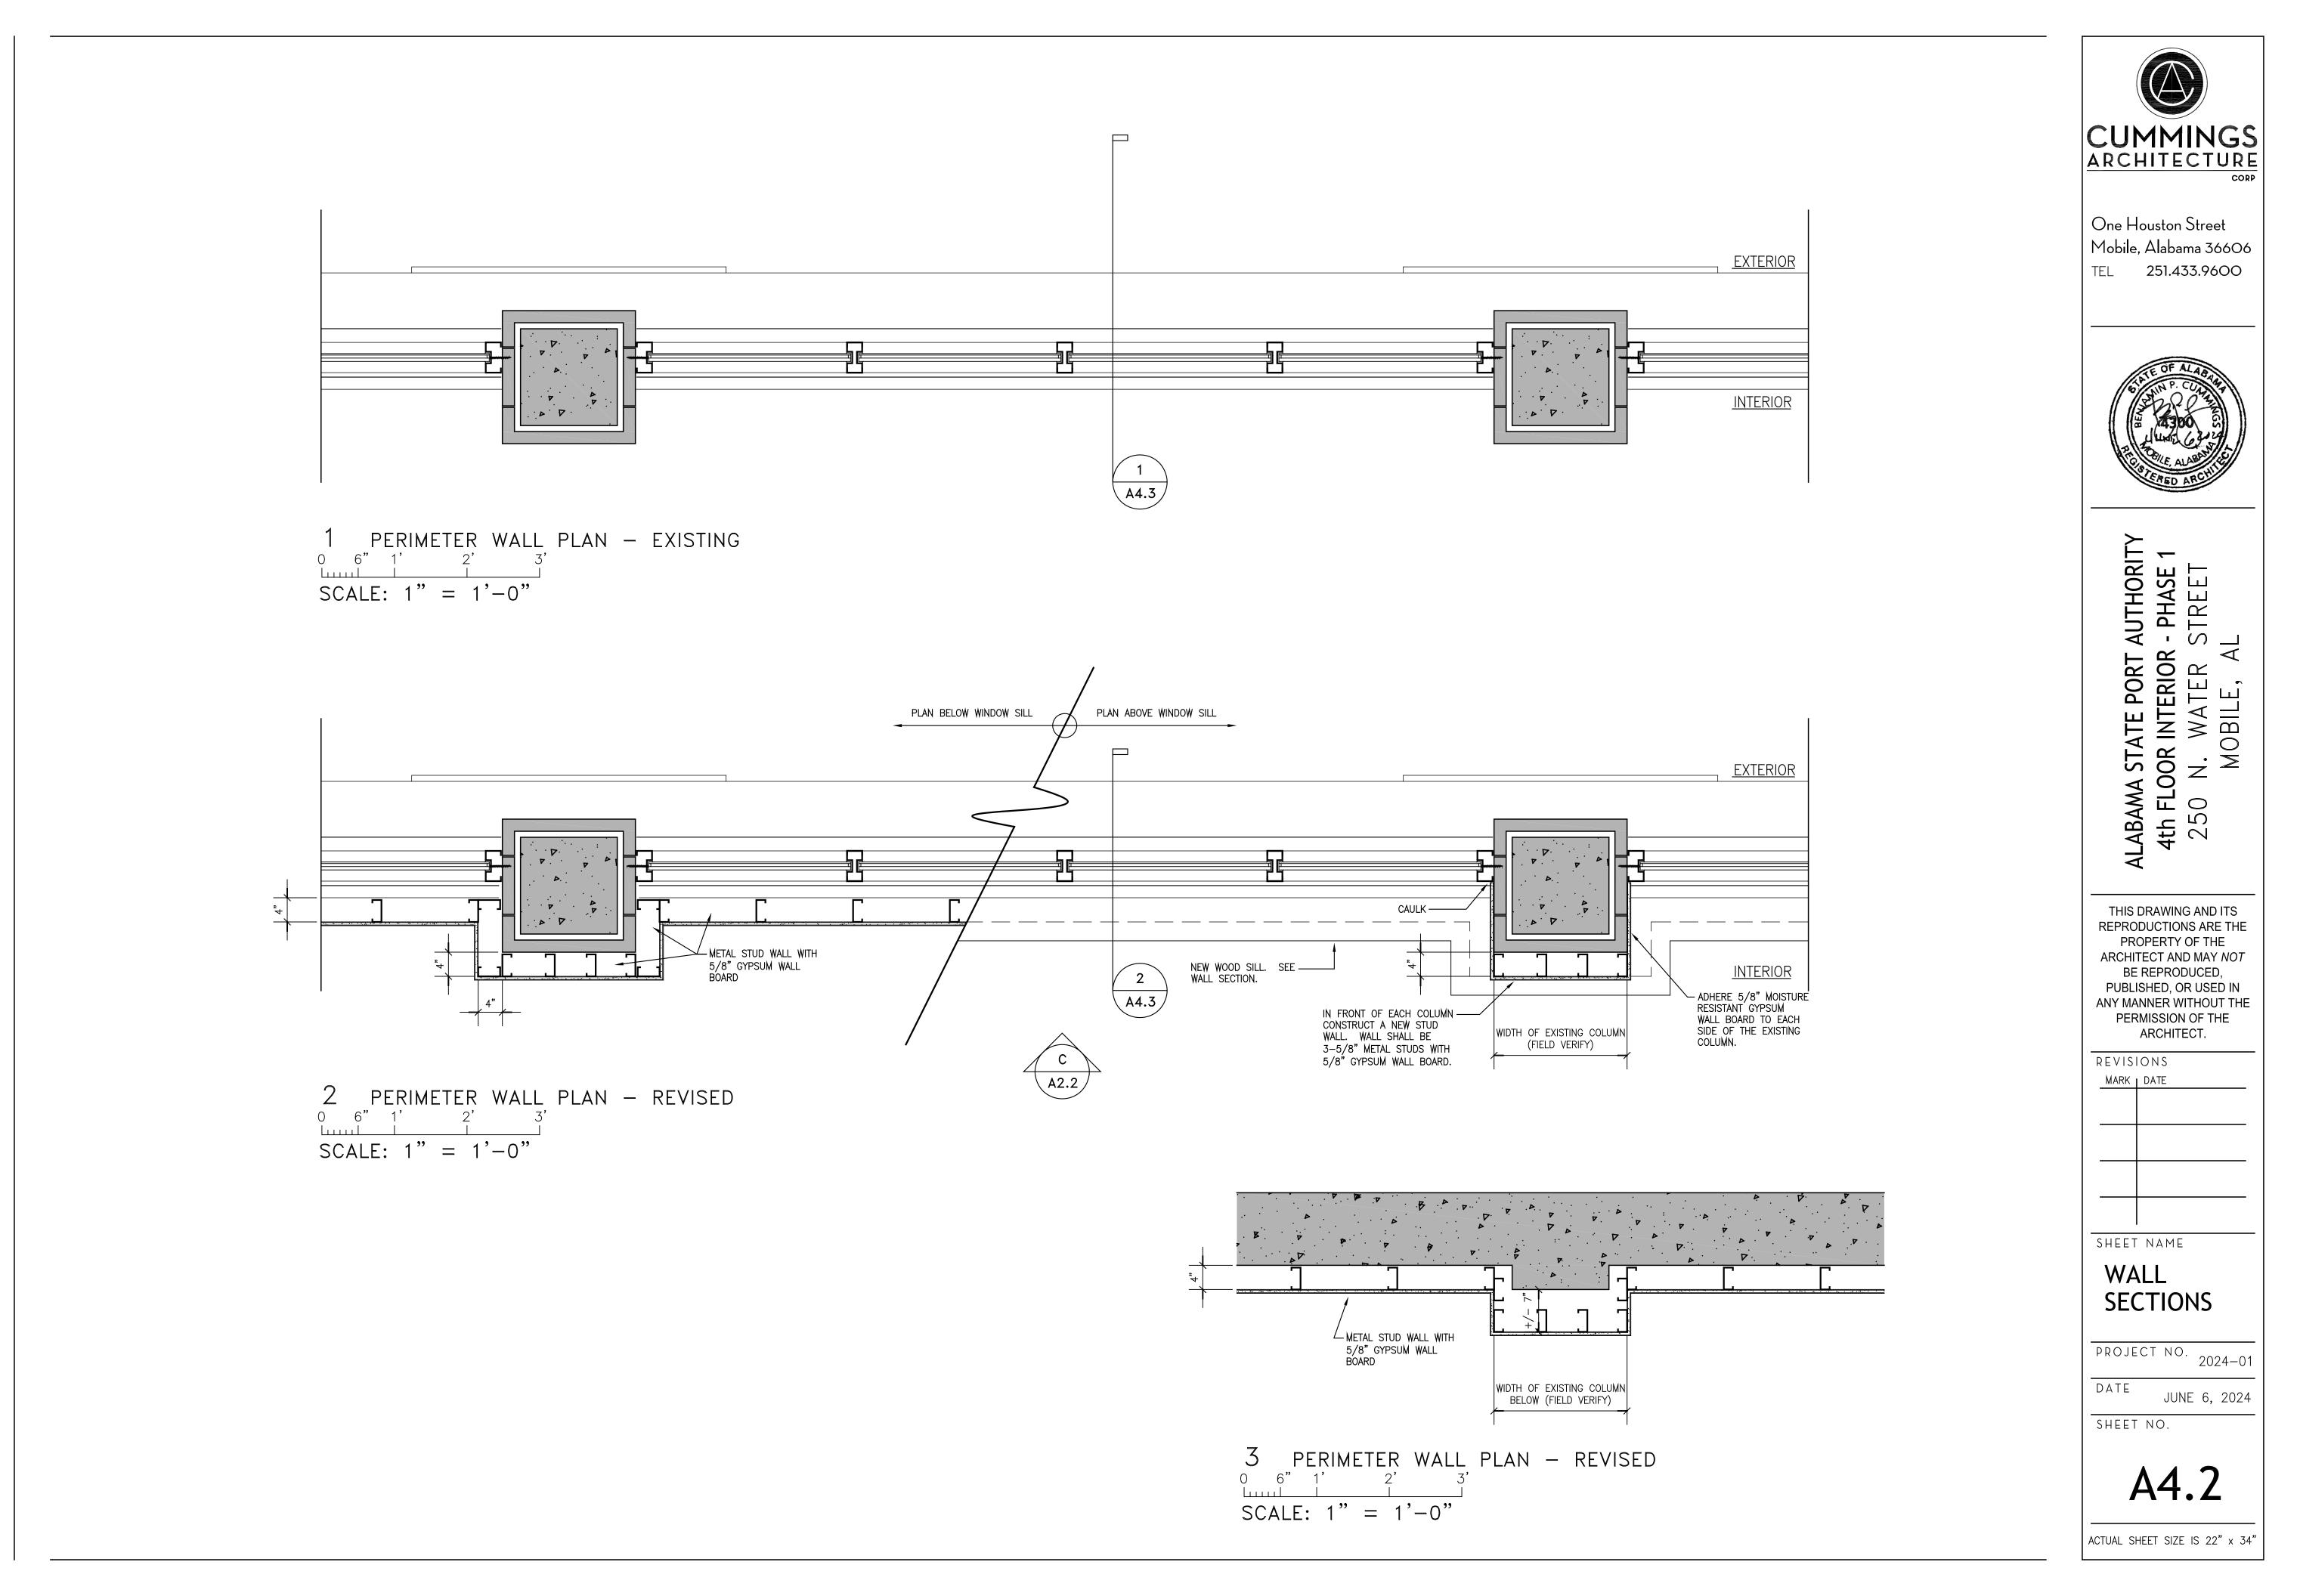

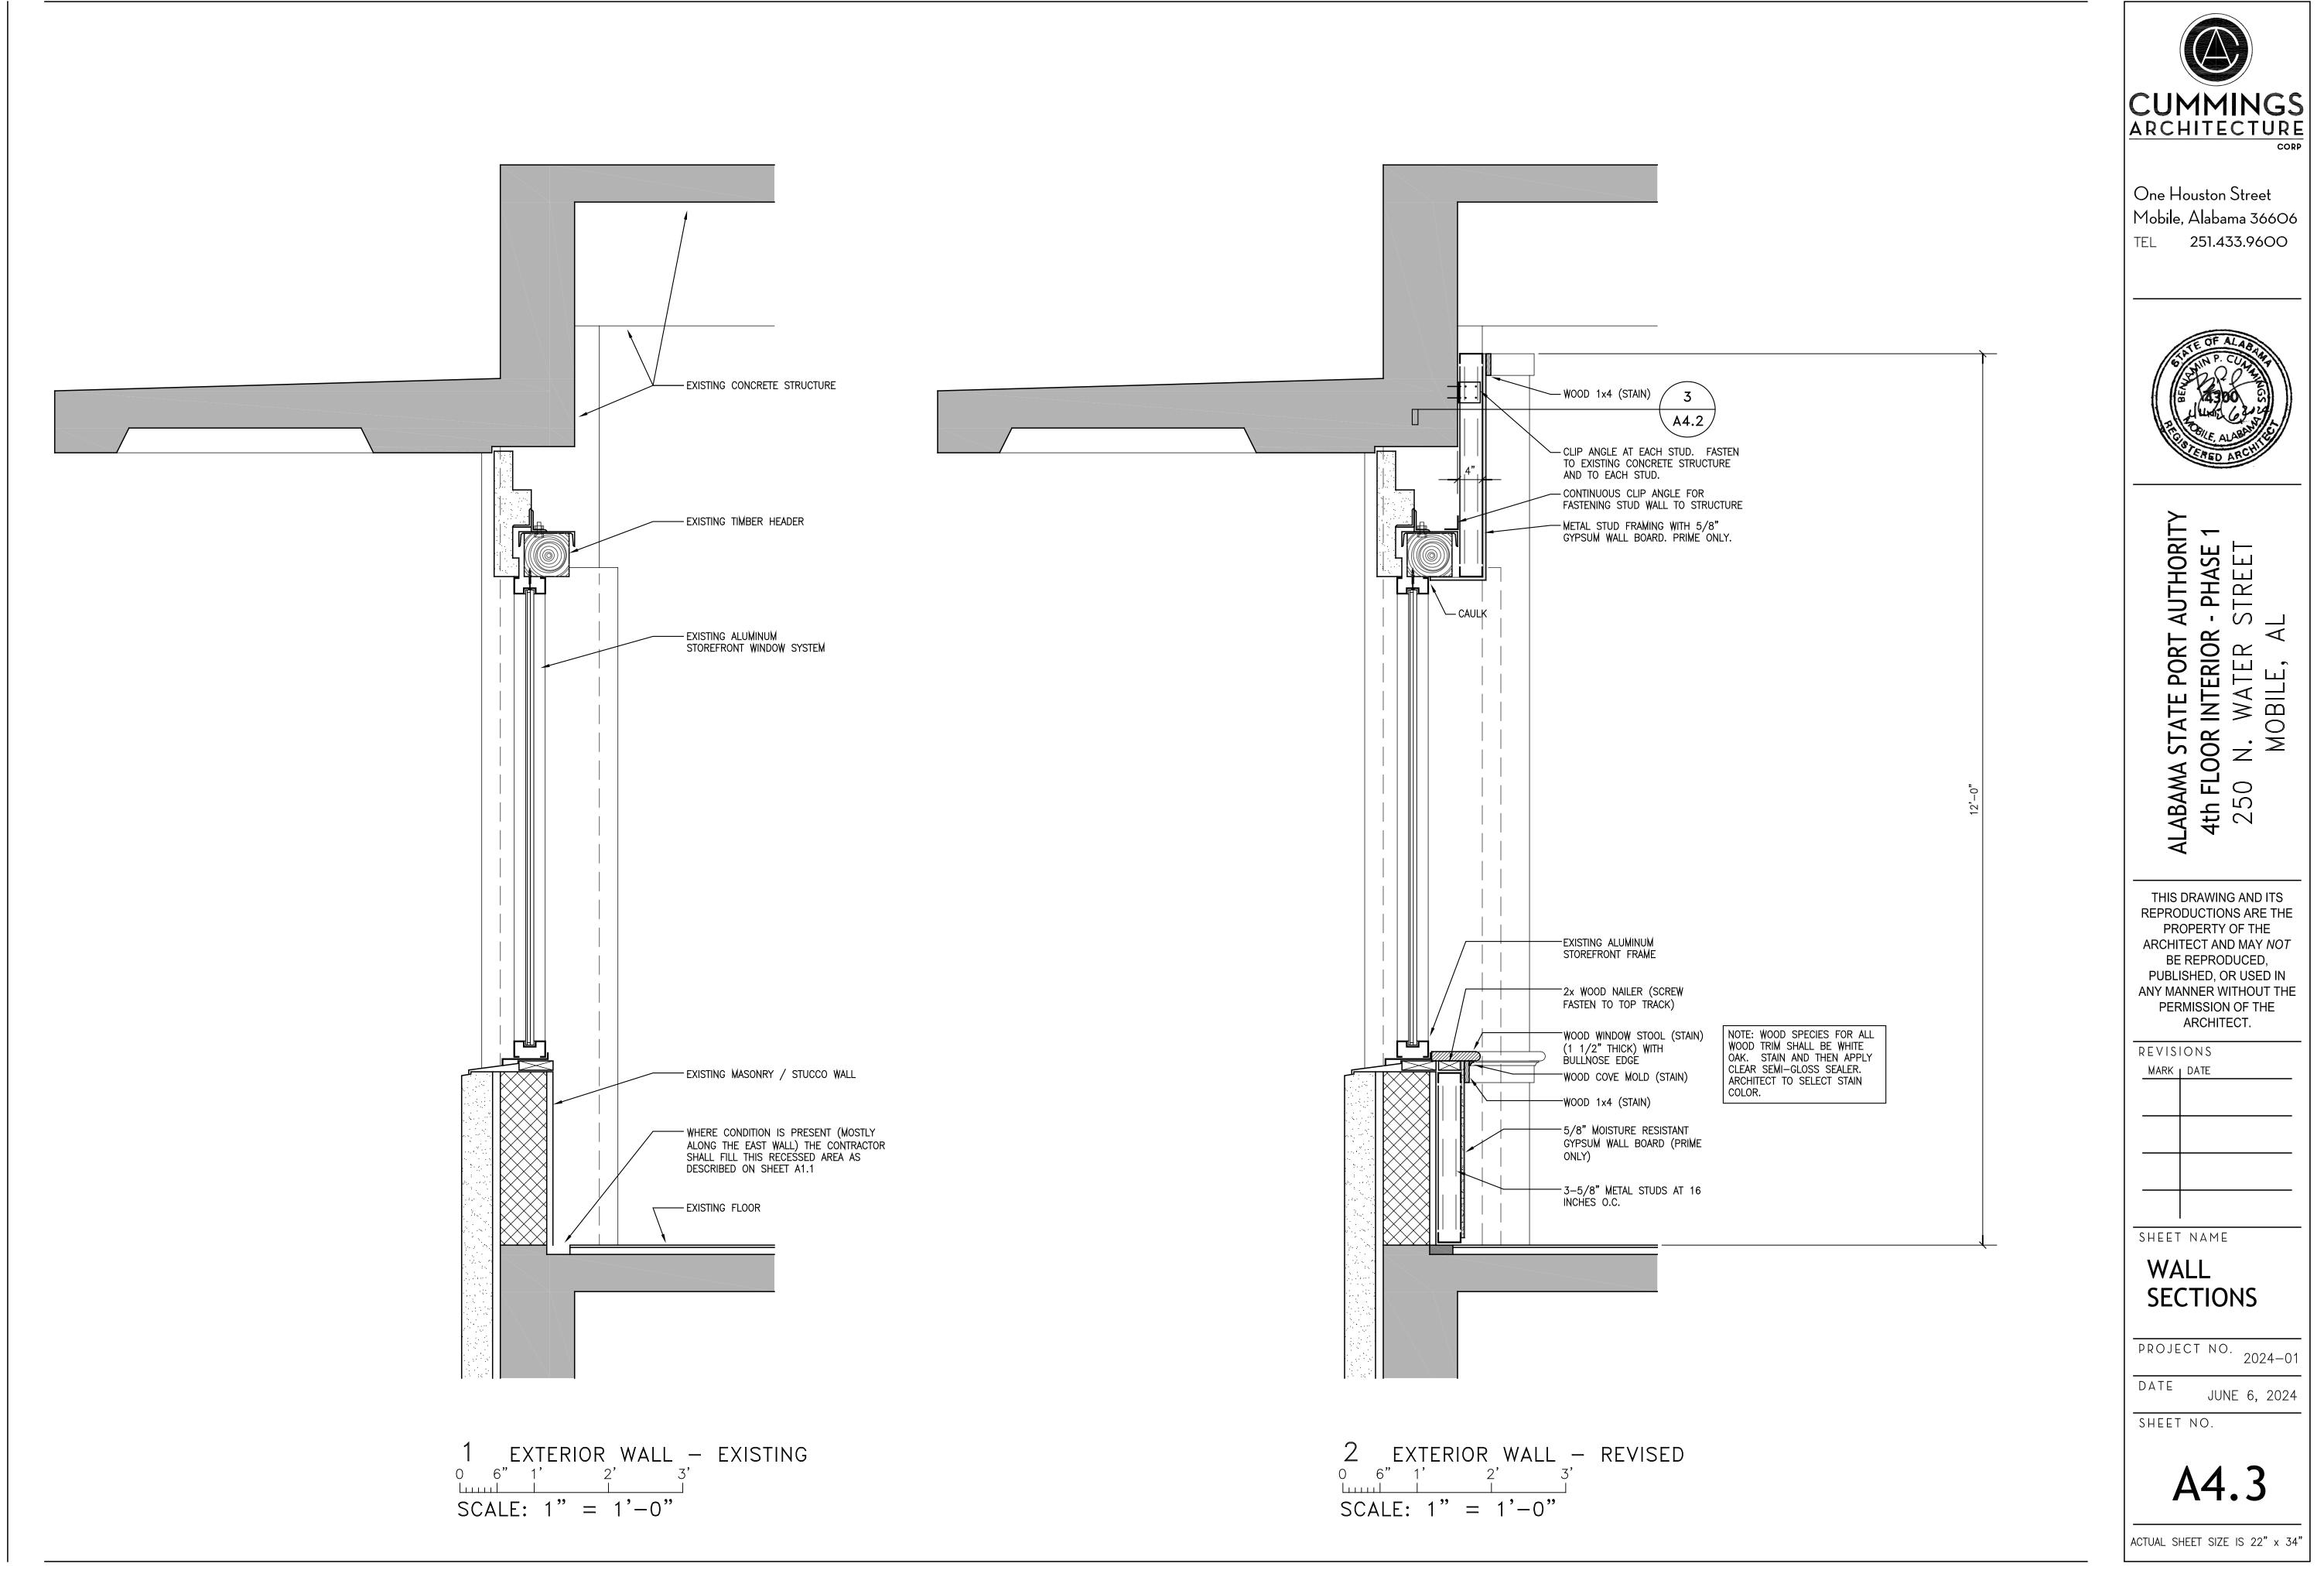

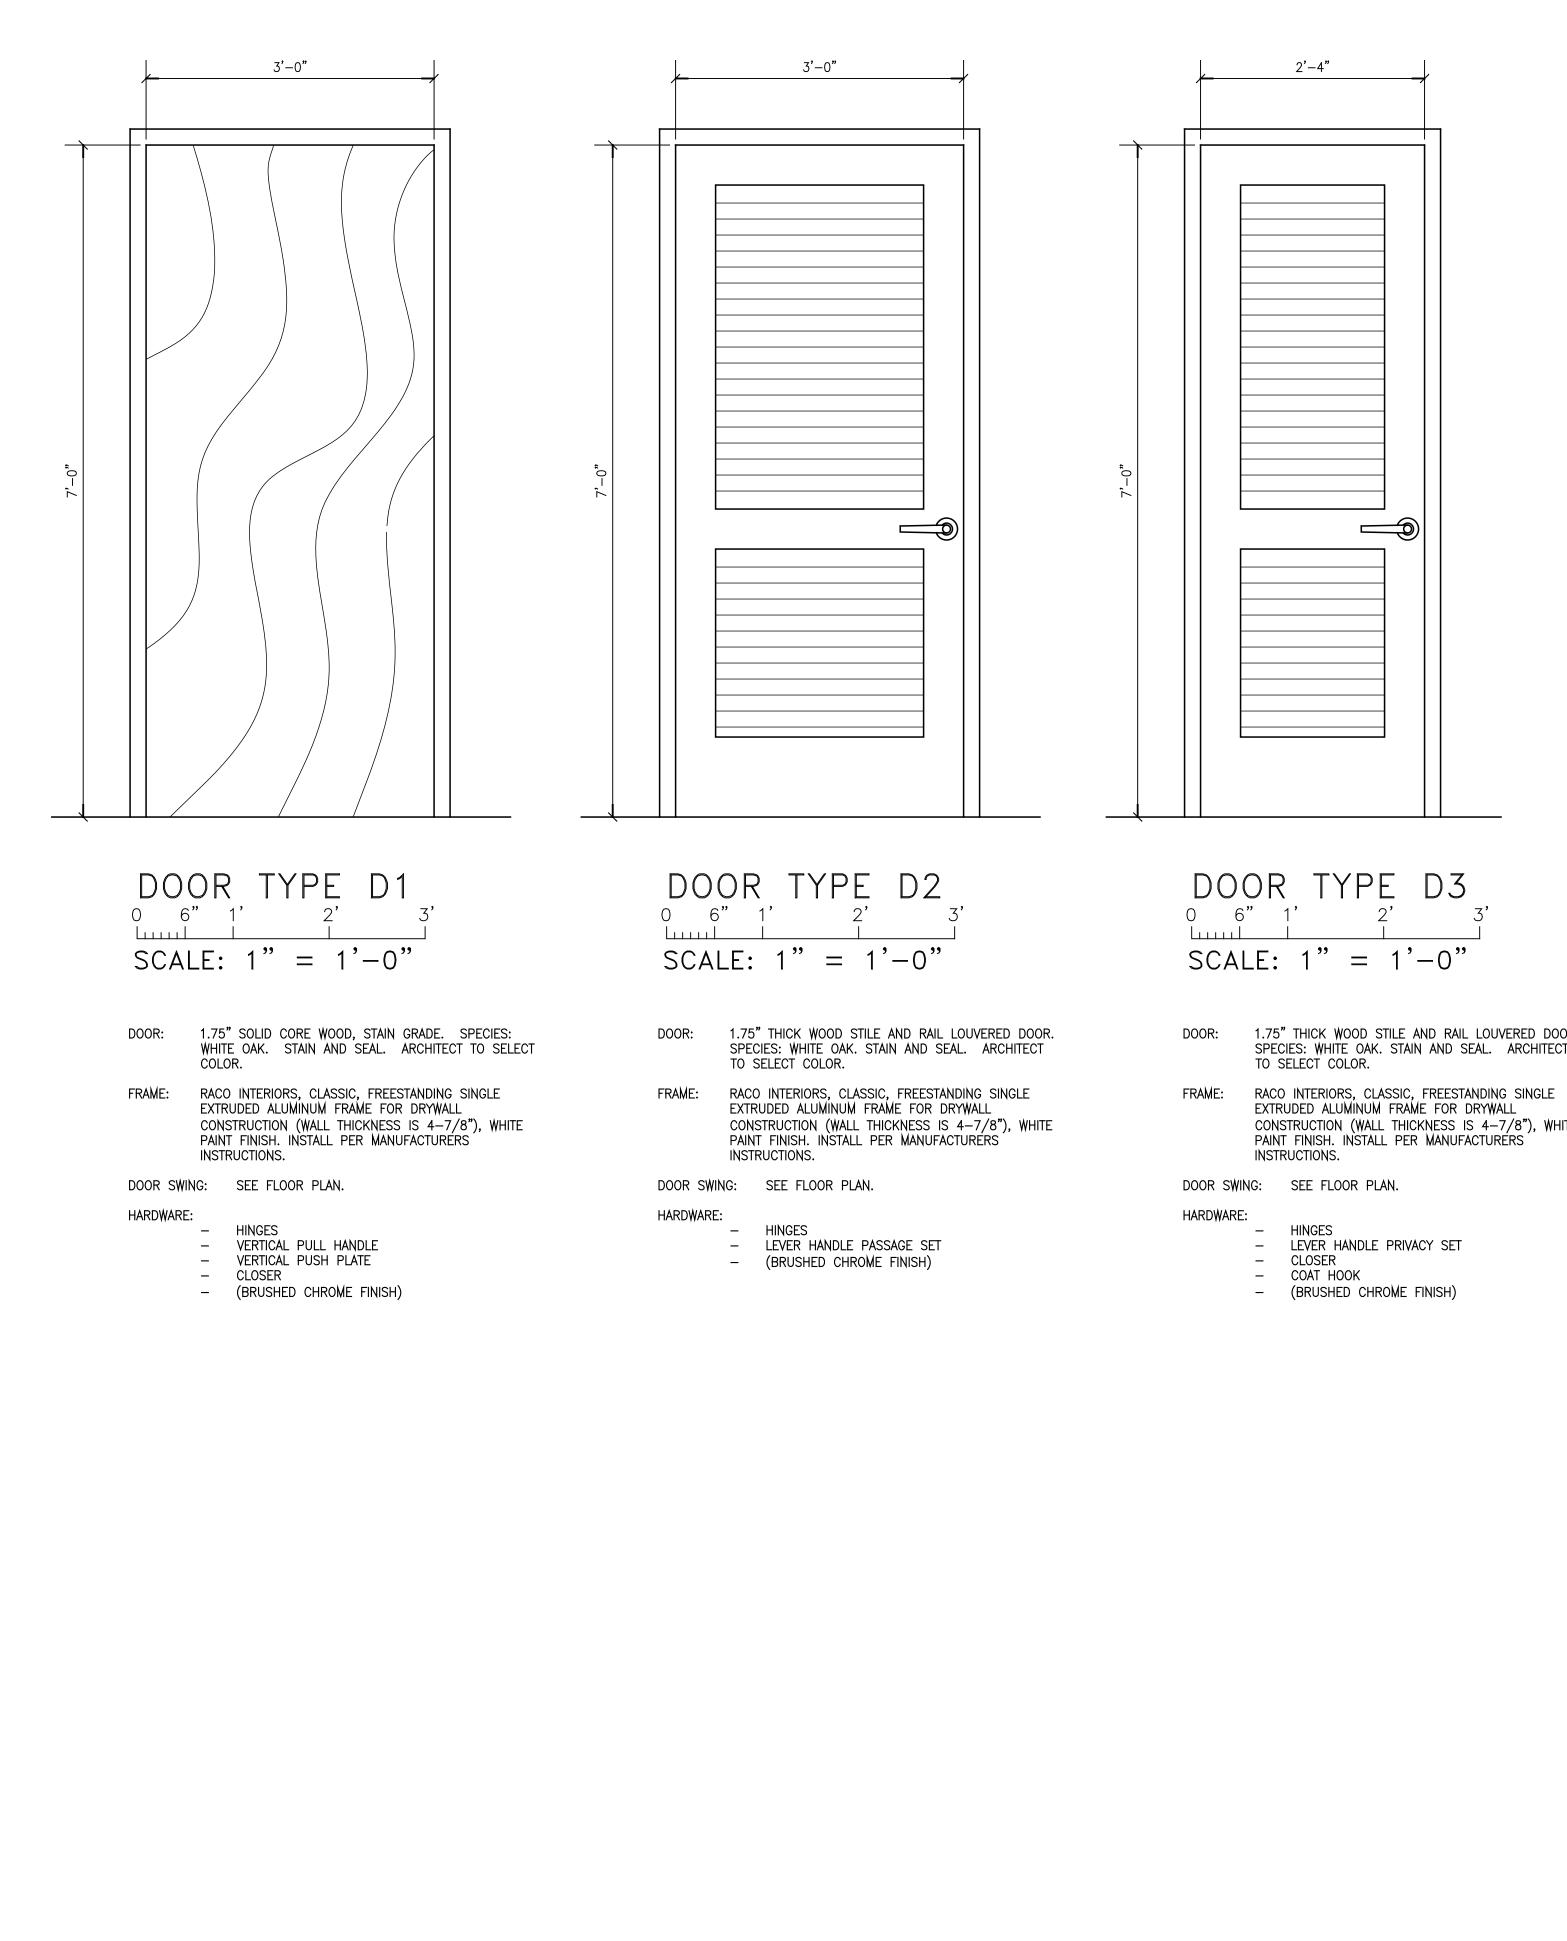

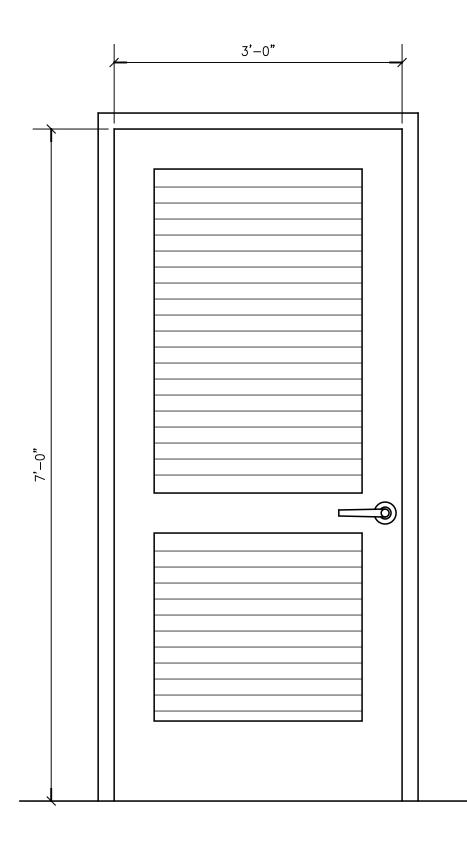

DOOR	TYPE	D3
6"1'	2'	3'
CALE: ´	1" = 1	'-0"

DOOR: 1.75" THICK WOOD STILE AND RAIL LOUVERED DOOR. SPECIES: WHITE OAK. STAIN AND SEAL. ARCHITECT

> EXTRUDED ALUMINUM FRAME FOR DRYWALL CONSTRUCTION (WALL THICKNESS IS 4-7/8"), WHITE PAINT FINISH. INSTALL PER MANUFACTURERS

DOOR TYPE D4 SCALE: 1'' = 1' - 0''


DOOR: 1.75" THICK WOOD STILE AND RAIL LOUVERED DOOR. SPECIES: WHITE OAK. STAIN AND SEAL. ARCHITECT TO SELECT COLOR.

FRAME: RACO INTERIORS, CLASSIC, FREESTANDING SINGLE EXTRUDED ALUMINUM FRAME FOR DRYWALL CONSTRUCTION (WALL THICKNESS IS 4-7/8"), WHITE PAINT FINISH. INSTALL PER MANUFACTURERS INSTRUCTIONS.

DOOR SWING: SEE FLOOR PLAN.

HARDWARE:

- HINGES – LEVER HANDLE PRIVACY SET
- CLOSER
- COAT HOOK
- (BRUSHED CHROME FINISH)

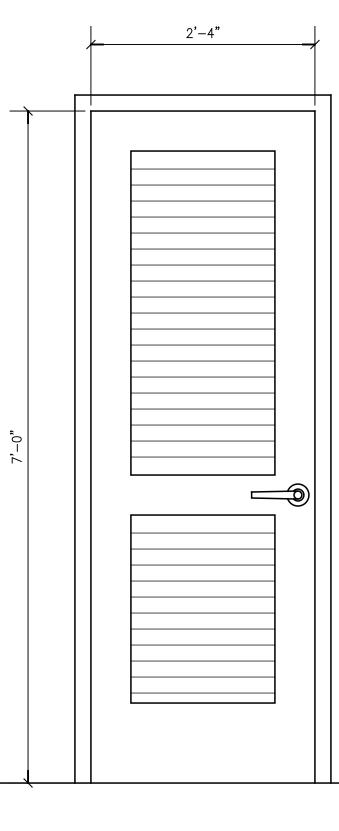

DOOR TYPE D5 0 6" 1' 2' 3' Luul SCALE: 1'' = 1' - 0''

- DOOR: 1.75" THICK WOOD STILE AND RAIL LOUVERED DOOR. SPECIES: WHITE OAK. STAIN AND SEAL. ARCHITECT TO SELECT COLOR.
- FRAME: RACO INTERIORS, CLASSIC, FREESTANDING SINGLE EXTRUDED ALUMINUM FRAME FOR DRYWALL CONSTRUCTION (WALL THICKNESS IS 4-7/8"), WHITE PAINT FINISH. INSTALL PER MANUFACTURERS INSTRUCTIONS.

DOOR SWING: SEE FLOOR PLAN.

HARDWARE:

– HINGES – LEVER HANDLE PASSAGE SET (BRUSHED CHROME FINISH)

CUMMINGS
One Houston Street Mobile, Alabama 36606 TEL 251.433.9600
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ALABAMA STATE PORT AUTHORITY 4th FLOOR INTERIOR - PHASE 1 250 N. WATER STREET MOBILE, AL
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MARK DATE
SHEET NAME
DOOR SCHEDULE
PROJECT NO. 2024-01
DATE JUNE 6, 2024
SHEET NO.
A5.1
ACTUAL SHEET SIZE IS 22" × 34"

				CONNE	ECTIONS			NOTES
MARK #	FIXTURE TYPE	MANUFACTURER AND MODEL	WASTE	VENT	CW	HW		
P-1	FLUSH VALVE WATER CLOSET	KOHLER K-96053 SLOAN ROYAL 111 SMOOTH	3"	2"	1"	-	VITREOUS CHINA, WHITE, 15" HIGH ELONGATED BOWL, FLOOR MOUNTED, TOP SPUD PROVIDE WITH WHITE OPEN FRONT SEAT WITHOUT COVER, AND SLOAN ROYAL BATTERY SENSOR FLUSH VALVE, 1.28 GALLONS PER FLUSH. PROVIDE FLUSH VALVE WITH CHROME PLATED TAIL PIECE EXTENDING FROM VALVE DOWN TO WATER CLOSET AND WALL BRACE. INSTALL PER SPECIFIC MANUFACTURER'S RECOMMENDATIONS.	3
P-1A	FLUSH VALVE WATER CLOSET (HC)	KOHLER K-25076-SS SLOAN ROYAL 111 SMOOTH	3"	2"	1"	-	VITREOUS CHINA, WHITE, 17" HIGH ELONGATED BOWL, FLOOR MOUNTED, TOP SPUD PROVIDE WITH WHITE OPEN FRONT SEAT WITHOUT COVER, AND SLOAN ROYAL BATTERY SENSOR FLUSH VALVE, 1.28 GALLONS PER FLUSH. PROVIDE FLUSH VALVE WITH CHROME PLATED TAIL PIECE EXTENDING FROM VALVE DOWN TO WATER CLOSET AND WALL BRACE. INSTALL PER SPECIFIC MANUFACTURER'S RECOMMENDATIONS. INSTALL PER ADA REQUIREMENTS.	13
P-2	URINAL	KOHLER K-4991-ET SLOAN ROYAL 186 SMOOTH	3"	2"	3/4"	-	VIT. CHINA, WHITE, WALL HUNG, BATTERY POWERED SENSOR FLUSH VALVE TYPE. FLUSH VALVE, 0.5 GALLONS PER FLUSH. PROVIDE SLOAN ROYAL BATTERY SENSOR FLUSH VALVE WITH CHROME PLATED TAIL PIECE EXTENDING DOWN FROM FLUSH VALVE TO TOP OF URINAL. PROVIDE WITH FLOOR MOUNTED CARRIER. INSTALL PER SPECIFIC MANUFACTURER'S RECOMMENDATIONS.	
P-2A	URINAL (HC)	KOHLER K-4991-ET SLOAN ROYAL 186 SMOOTH	3"	2"	3/4"	-	VIT. CHINA, WHITE, WALL HUNG, BATTERY POWERED SENSOR FLUSH VALVE TYPE. FLUSH VALVE, 0.5 GALLONS PER FLUSH. PROVIDE SLOAN ROYAL BATTERY SENSOR FLUSH VALVE WITH CHROME PLATED TAIL PIECE EXTENDING DOWN FROM FLUSH VALVE TO TOP OF URINAL. PROVIDE WITH FLOOR MOUNTED CARRIER. INSTALL PER SPECIFIC MANUFACTURER'S RECOMMENDATIONS. INSTALL PER ADA REQUIREMENTS.	13
P-3	LAVATORY (HC)	CORIAN ELEMENTS 8254 SLOAN SF-2150 - 0.5 GPM	2"	2"	1/2"	1/2"	SEE ARCHITECTURAL PLANS FOR COUNTER TYPE. PROVIDE UNDERMOUNT, ADA APPROVED LAVATORY EQUAL TO CORIAN ELEMENTS 8254. 19-1/2"x14-3/8" UNDERMOUNT LAVATORY WITH DRAIN LOCATED TOWARD THE BACK OF THE FIXTURE TO ALLOW FOR ADA INSTALLATION. SEE ARCHITECTURAL PLANS FOR ADDITIONAL LAVATORY INSTALLATION REQUIREMENTS. PROVIDE WITH SLOAN BATTERY SENSOR FAUCET WITH ASSE 1070 MIXING VALVE. PROVIDE WITH NEW OFFSET P-TRAP, FLEXIBLE SUPPLIES, AND STOPS. COORDINATE TRAP COVER INSTALLATION WITH GENERAL CONTRACTOR. INSTALL PER ADA REQUIREMENTS.	123
3" FD	FLOOR DRAIN	ZURN Z415B	3"	2"	-	-	CAST IRON FLOOR DRAIN WITH SQUARE POLISHED NICKEL BRONZE GRATE. PROVIDE FLOOR DRAIN WITH "GREEN DRAIN" TRAP SEAL.	

1 HANDICAPPED FIXTURES SHALL BE INSTALLED PER THE LATEST REQUIREMENTS OF ADA.

2 PROVIDE ALL LAVATORIES WITH ASSE 1070 TEMPERATURE LIMITING VALVE. SEE DETAIL FOR INSTALLATION REQUIREMENTS.

- 1. THE CONTRACTOR SHALL EXECUTE ALL WORK SO THAT IT PROCEEDS WITH A MINIMUM INTERFERENCE WITH OTHER TRADES.
- 2. VERIFY EXACT PLUMBING FIXTURE ROUGH-IN AND FINAL HVAC EQUIPMENT REQUIREMENTS IN THE FIELD.
- 3. DRAIN, WASTE, AND VENT PIPING AND FITTINGS SHALL BE STANDARD WEIGHT CAST IRON. CEILING IS A RETURN AIR PLENUM. NO PVC PRODUCTS ARE ALLOWED.
- 4. DOMESTIC WATER PIPING SHALL BE ASTM B 88, TYPE K, WITH ANSI B16.18 OR ANSI B16.22 SOLDER JOINT FITTINGS USING SILVER SOLDER AND FLUX CONTAINING NOT MORE THAN 0.2 PERCENT LEAD; OR WITH ANSI B16.26 FLARED JOINT FITTINGS. ASTM B 88, TYPE L MAY BE PROVIDED FOR ABOVEGROUND PIPING. SLEEVE SERVICE ENTRANCE AT SLAB. SEAL AROUND PIPING WATER PROOF.
- 5. THE CONTRACTOR SHALL BE RESPONSIBLE FOR ALL FINAL CONNECTIONS TO PLUMBING FIXTURES. THIS RESPONSIBILITY INCLUDES, BUT IS NOT LIMITED TO, FURNISHING AND INSTALLING ALL TRAPS, DRAINS, AND SUPPLIES WITH STOPS. FURNISH AND INSTALL PLUMBING FIXTURES INDICATED OR SPECIFIED, COMPLETE WITH ALL EQUIPMENT, FITTINGS, TRIM AND ACCESSORIES INDICATED OR SPECIFIED. EXPOSED WATER PIPING TO FIXTURES SHALL BE CHROME-PLATED BRASS, IPS. ADJUST WATER FLOW THROUGH ALL FIXTURES TO PROVIDE PROPER FLUSHING ACTION WITH THE LEAST AMOUNT OF WATER.
- 6. COORDINATE ROUTING OF WATER SUPPLY, WASTE, AND VENT PIPING WITH OTHER TRADES.
- 7. THE PLUMBING CONTRACTOR SHALL COORDINATE WITH THE GENERAL CONTRACTOR AND OTHER TRADES ALL REQUIRED OPENINGS AND EXCAVATIONS.
- 8. FLOOR CLEANOUTS SHALL BE ADJUSTABLE HEIGHT POLISHED BRONZE, NICKEL BRONZE WITH "CO" CAST IN THE FLOOR PLATE.
- 9. PROVIDE STOPS AND WATER HAMMER ARRESTORS IN ACCORDANCE WITH PDI AND ASSE 1010. AN ACCESS PANEL MUST BE INSTALLED IF WATER HAMMER ARRESTER IS LOCATED INSIDE A WALL OR ABOVE A HARD CEILING. COORDINATE OPENINGS WITH ARCHITECT.

(3) KOHLER, SLOAN, AND CORIAN ELEMENTS ARE THE FIXTURES BASIS OF DESIGN. SUBMIT ALL OTHER ALTERNATES FOR REVIEW AND PRIOR APPROVAL A MINIMUM OF 14 DAYS BEFORE BID DATE.

GENERAL PLUMBING NOTES


- 10. PROVIDE DIELECTRIC UNIONS AT ALL DISSIMILAR METAL CONNECTIONS.
- 11. INSULATE ALL WATER PIPING. DOMESTIC WATER PIPE NOT EXPOSED TO VIEW SHALL BE INSULATED WITH 1" THICK GLASS FIBER WITH FACTORY APPLIED UNIVERSAL JACKET. DENSITY SHALL BE 4 POUNDS PER CUBIC FOOT. FITTINGS SHALL BE INSULATED ACCORDING TO MANUFACTURER'S RECOMMENDATIONS. INSULATION VAPOR BARRIER SHALL BE LAPPED AND CEMENTED IN ACCORDANCE WITH MANUFACTURER'S RECOMMENDATIONS. DOMESTIC WATER PIPE EXPOSED TO VIEW SHALL BE INSULATED SAME AS WHERE NOT EXPOSED TO VIEW, EXCEPT IT SHALL BE FINISHED WITH A SIZED UNIVERSAL JACKET SUITABLE FOR PAINTING. FITTING SHALL BE MADE OF "QUICKSET" CEMENT MOLDED TO FIT AND COVERED WITH 8 OZ. CANVAS AND FINISHED WITH WHITE VAPOR BARRIER CEMENT, AND HAVE PLASTIC MOLDED FITTING COVERS. INSULATE DOMESTIC WATER AND WASTE PIPING UNDER HANDICAP LAVATORIES AND SINKS USING "LAVGUARD2 E-Z SERIES" MOLDED VINYL PIPING COVERS. COVER ALL PIPING, FITTING, VALVES, AND TRAPS EXPOSED TO VIEW.
- 12. ROUTE ALL PIPING AS TO CAUSE MINIMAL INTERFERENCE FOR MAINTENANCE OF ALL EQUIPMENT. UNLESS OTHERWISE NOTED, ALL DOMESTIC WATER PIPING SHALL BE ROUTED WITHIN CHASE SPACE. PIPING BELOW SLAB SHALL BE WITHOUT JOINTS AND TEES. PIPING PASSING THRU WALLS EXTENDING TO BOTTOM OF STRUCTURE SHALL BE SLEEVED AND SEALED. ALL DOMESTIC WATER PIPING ROUTED EXPOSED BELOW 6'-8" ABOVE FINISH FLOOR SHALL BE PROVIDED WITH A PVC JACKET TO PREVENT DAMAGE TO THE PIPE.
- 13. PROVIDE SHUTOFF VALVE TO EACH SILLCOCK WITH VALVE IDENTIFICATION AS REQUIRED BY CODE.
- 14. BEFORE FINAL ACCEPTANCE OF THE WORK, TEST EACH SYSTEM AS IN SERVICE TO DEMONSTRATE COMPLIANCE WITH 2021 INTERNATIONAL PLUMBING CODE AND LOCAL CODE REQUIREMENTS. ONCE TEST ARE IN COMPLIANCE WITH CONTRACT REQUIREMENTS DISINFECT WATER SYSTEM IN ACCORDANCE WITH AWWA C651.


15. CONTRACTOR TO VERIFY ALL LOCATIONS OF ROOF PENETRATIONS WITH ARCHITECTURAL DRAWINGS.


- 16. PIPE HANGERS AND SUPPORTS SHALL BE MSS SP-58 AND M TYPE, EXCEPT AS INDICATED OTHERWISE. ATTACHMENTS 21, 28, 29, OR 30 CLAMPS. ATTACHMENTS TO STEEL ANGLES BE WITH TYPE 20 CLAMP WITH A BEAM CLAMP CHANNEL AD (WITH WEB HORIZONTAL) SHALL BE WITH DRILLED HOLE ON ATTACHMENTS TO CONCRETE SHALL BE WITH TYPE 18 INSI ANCHOR. HANGER RODS AND ATTACHMENTS SHALL BE FUI PROVIDE TYPE 40 INSULATION PROTECTION SHIELDS FOR RODS. PROVIDE NONMETALLIC, HAIR FELT, OR PLASTIC PIP AND THE HANGERS.
- 17. LABEL ALL WATER SERVICE VALVES IN ACCORDANCE WITH
- 18. COORDINATE EXACT FLOOR DRAIN LOCATIONS ARCHITECT DRAINS.
- 19. ALL TRAP PRIMER VALVES NOT LOCATED IN NORMALLY UNC THE CEILING AND PROVIDED WITH A LABEL ON THE CEILING LOCATION. NO TRAP PRIMERS SHALL BE INSTALLED EXPOSI
- 20. ALL WORK INSTALLED SHALL MEET THE REQUIREMENTS OF JURISDICTION, THE 2021 INTERNATIONAL PLUMBING CODE, CONSERVATION CODE.


Since the second seco	Correct Cone Houston Street Mobile, Alabama 36606 TEL 251.433.9600
	NO. 24744 PROFESSIONAL + NG. 24744 PROFESSIONAL + NG. NEL NG. S. N. N. S. S. N. S.
	ALABAMA STATE PORT AUTHORITY ALABAMA STATE PORT AUTHORITY 4th FLOOR INTERIOR - PHASE 1 250 N. WATER STREET DOBLE, AL MOBLE, AL
ASS SP-69, TYPE 1 OR 6, OF THE ADJUSTABLE TO STEEL W OR S BEAMS SHALL BE WITH TYPE S AND CHANNELS (WITH WEB VERTICAL) SHALL DAPTER. ATTACHMENTS TO STEEL CHANNEL N CENTERLINE AND DOUBLE NUT AND WASHER. ERT OR A DRILLED HOLE WITH EXPANSION LL SIZE OF THE HANGER-THREADED DIAMETER. INSULATED PIPING. PROVIDE STEEL SUPPORT ING ISOLATORS BETWEEN COPPER TUBING	REPRODUCTIONS ARE THE PROPERTY OF THE ARCHITECT AND MAY NOT BE REPRODUCED, PUBLISHED, OR USED IN ANY MANNER WITHOUT THE PERMISSION OF THE ARCHITECT. REVISIONS MARK DATE
APPLICABLE CODES URAL DRAWINGS. SLOPE ENTIRE ROOM TO OCCUPIED SPACES SHALL BE MOUNTED ABOVE 3 GRID TO INDICATE THE TRAP PRIMER SED IN NORMALLY OCCUPIED SPACES. F THE LOCAL AUTHORITY HAVING AND THE 2015 INTERNATIONAL ENERGY	SHEET NAME PLUMBING SCHEDULES & NOTES PROJECT NO. 2024-01 DATE JUNE 6, 2024 SHEET NO.
	P1.0

ACTUAL SHEET SIZE IS 22" x 34'

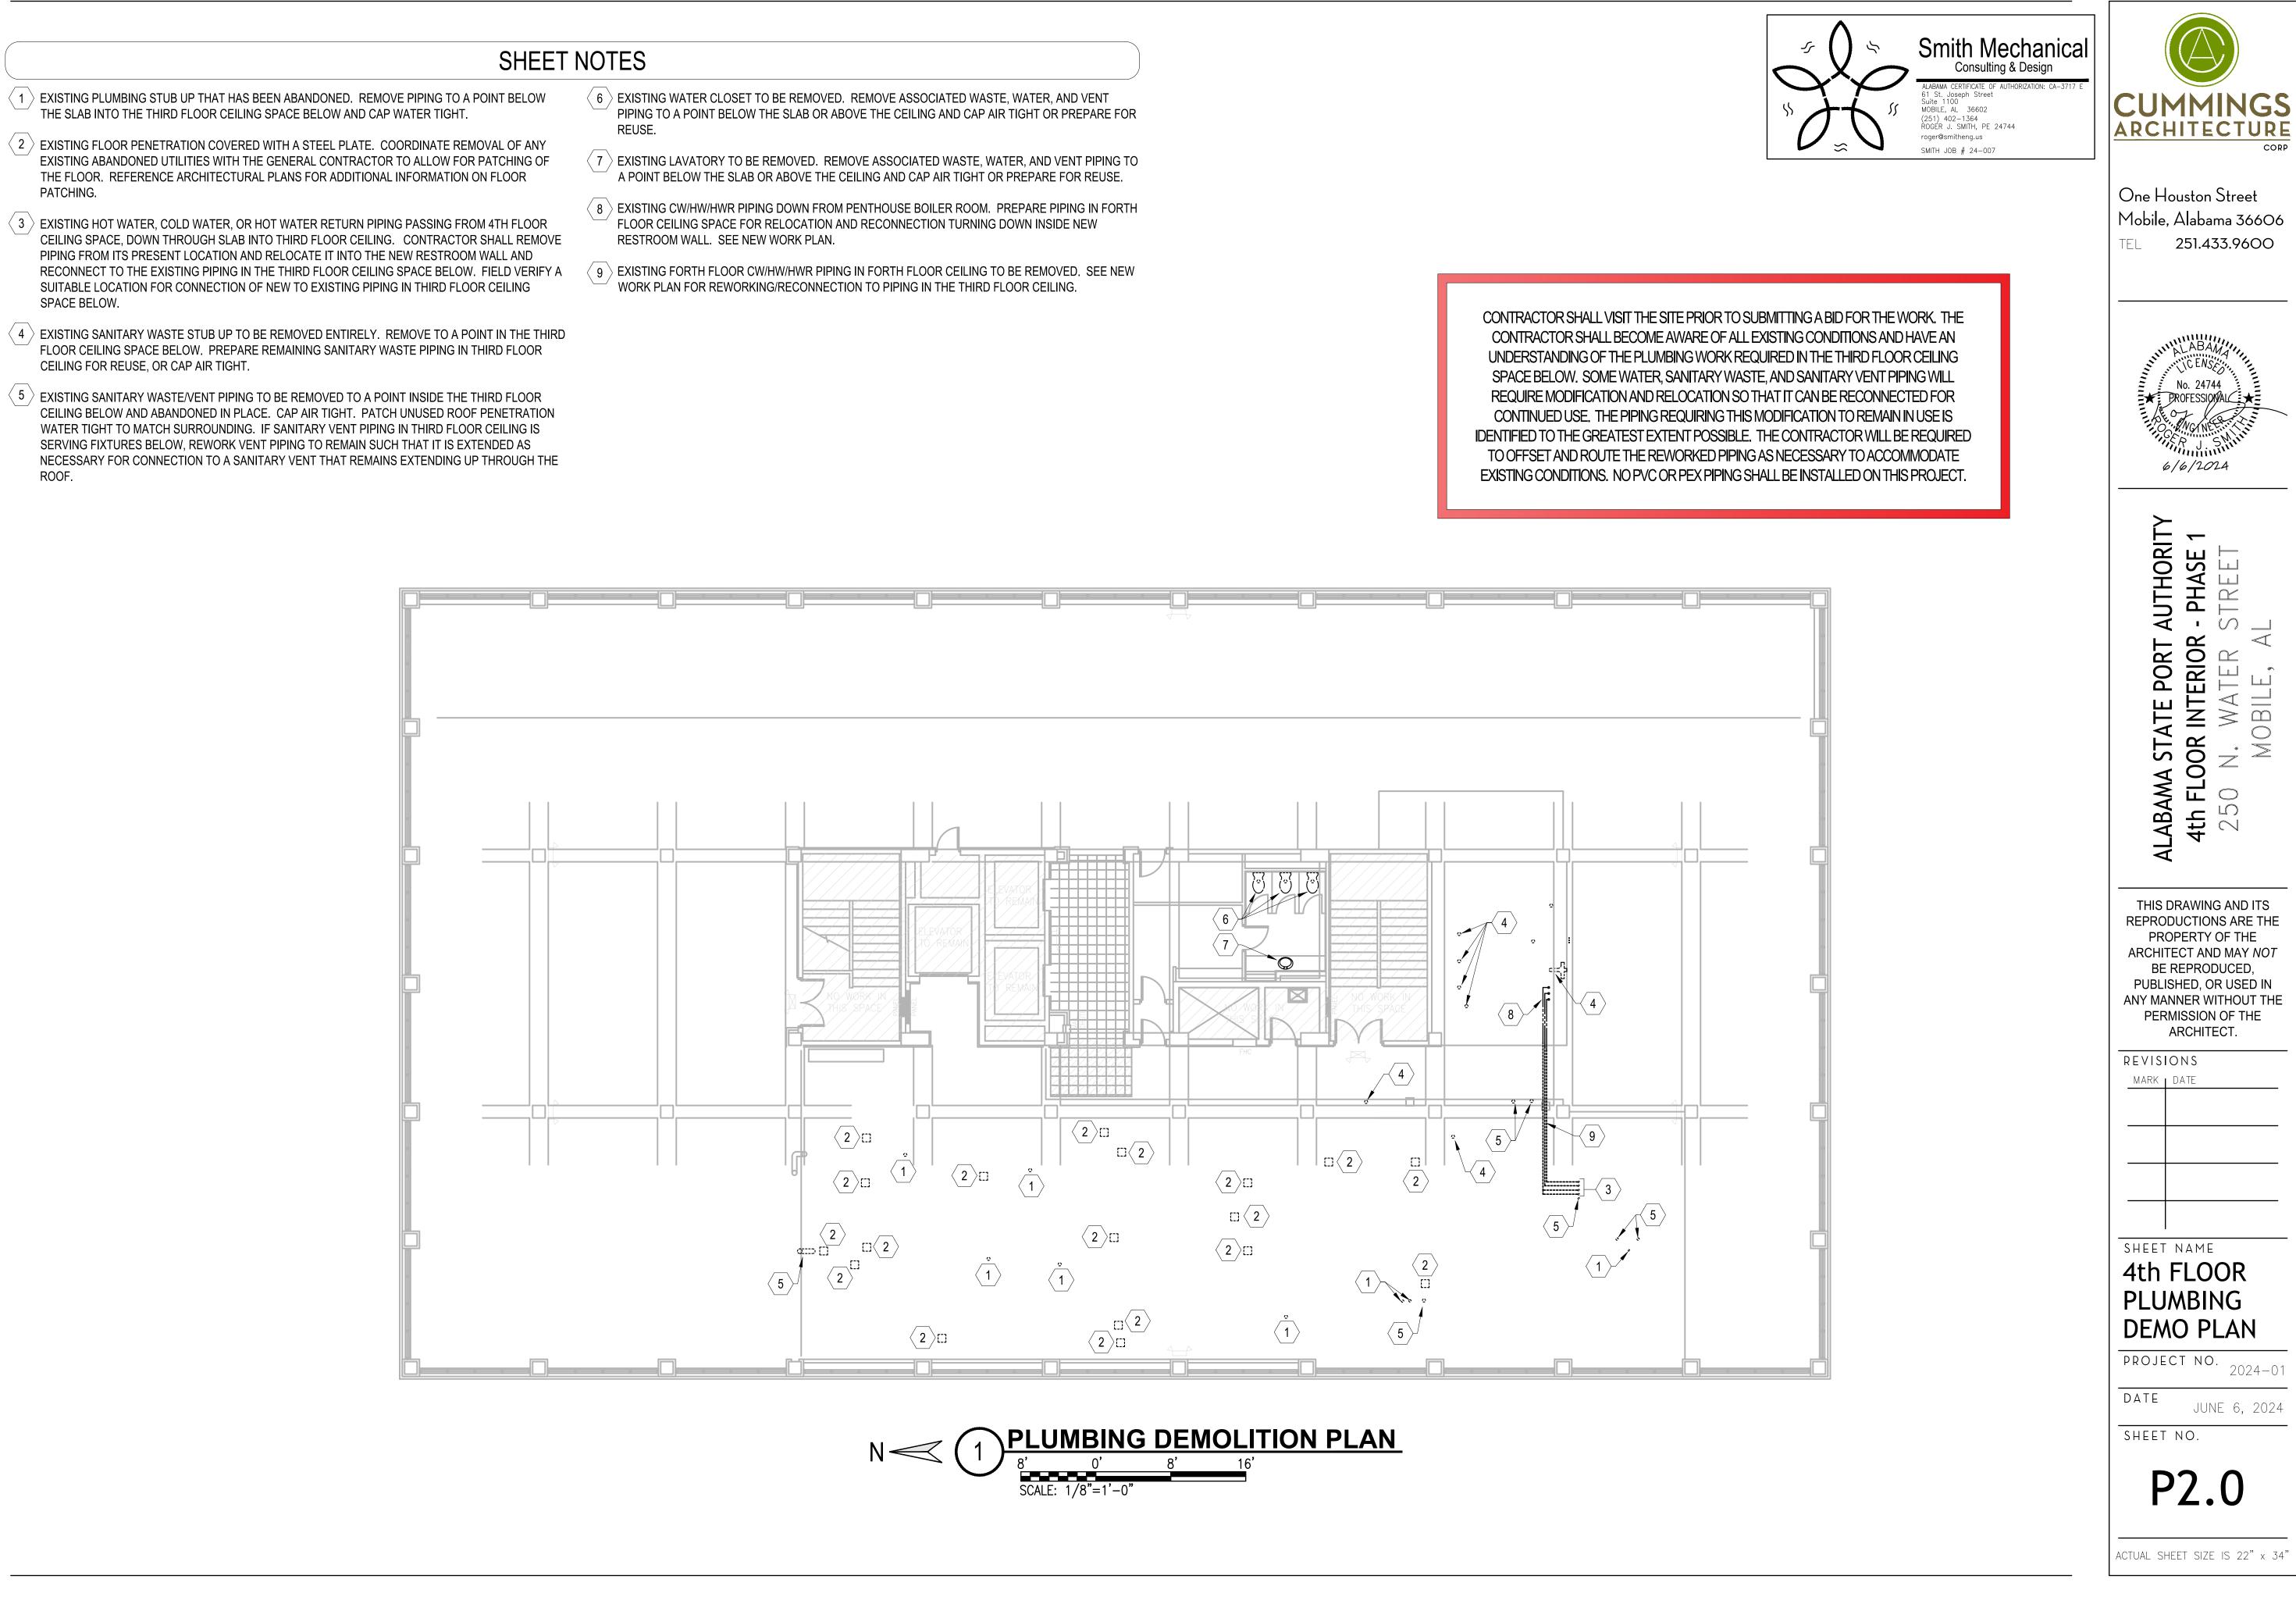

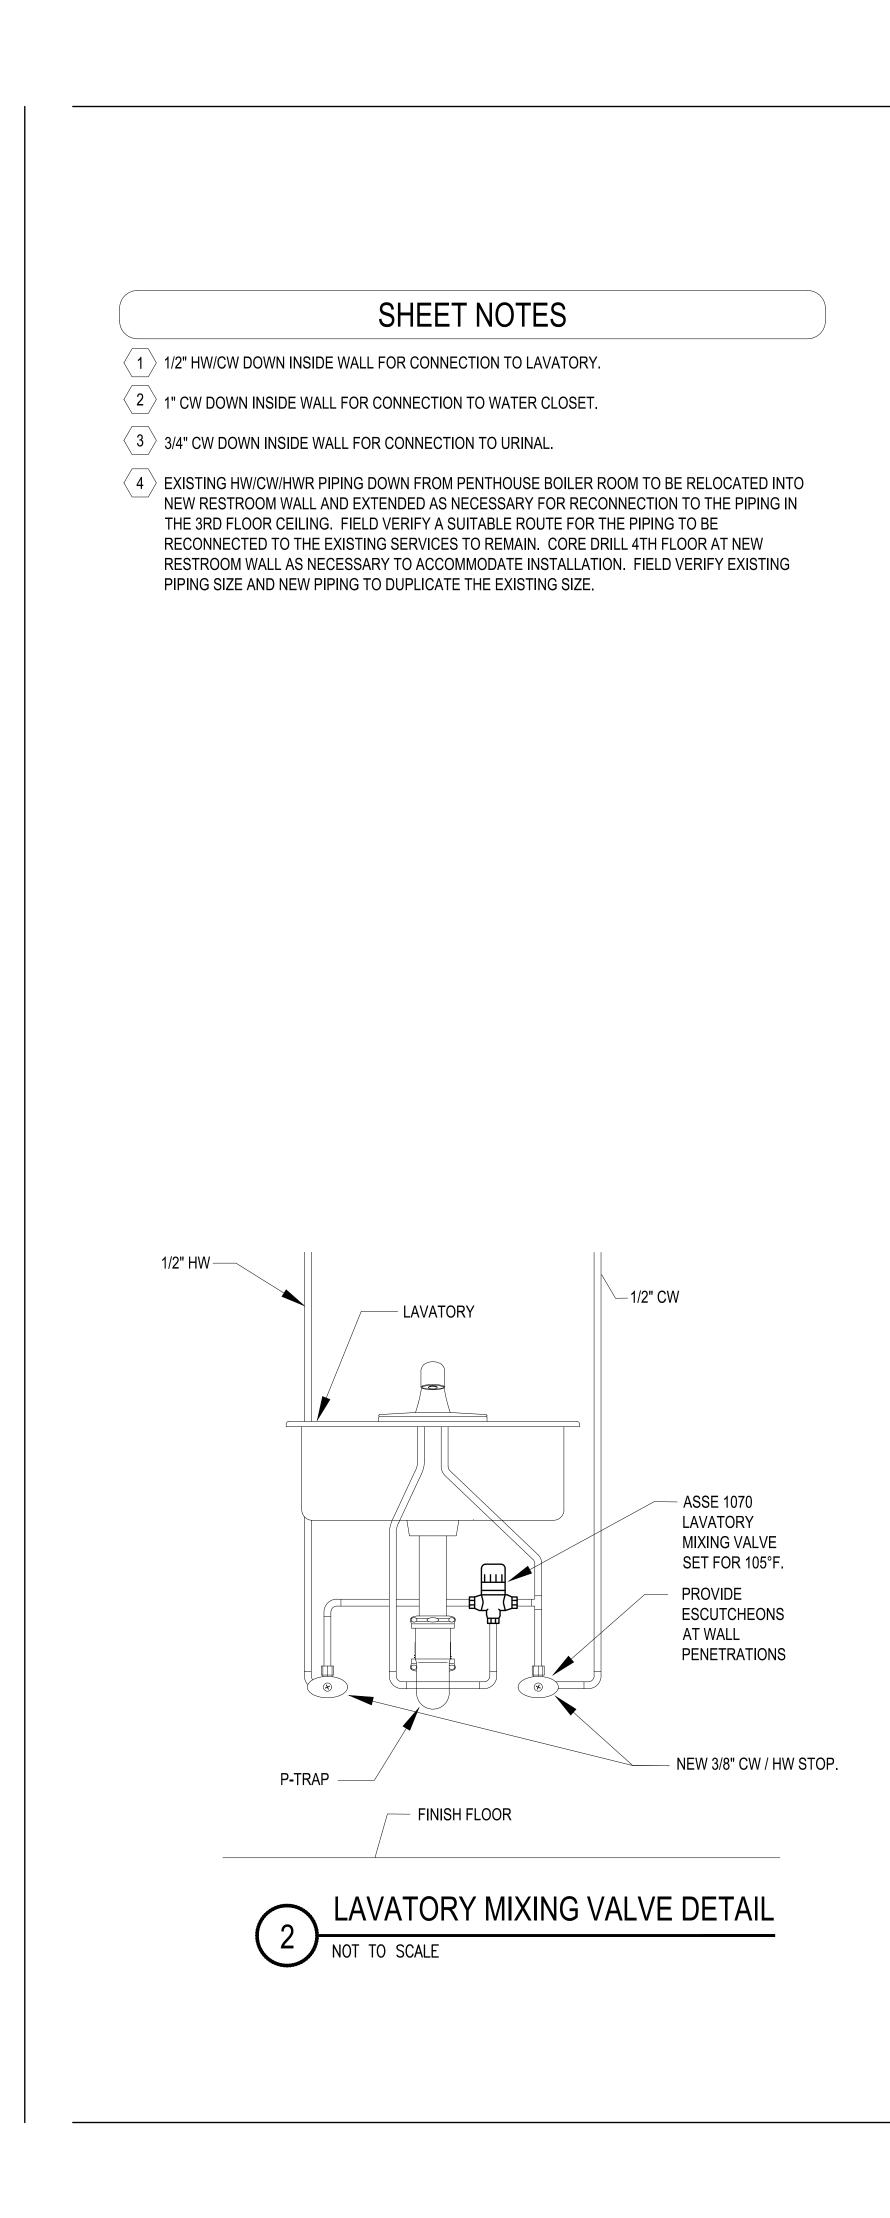

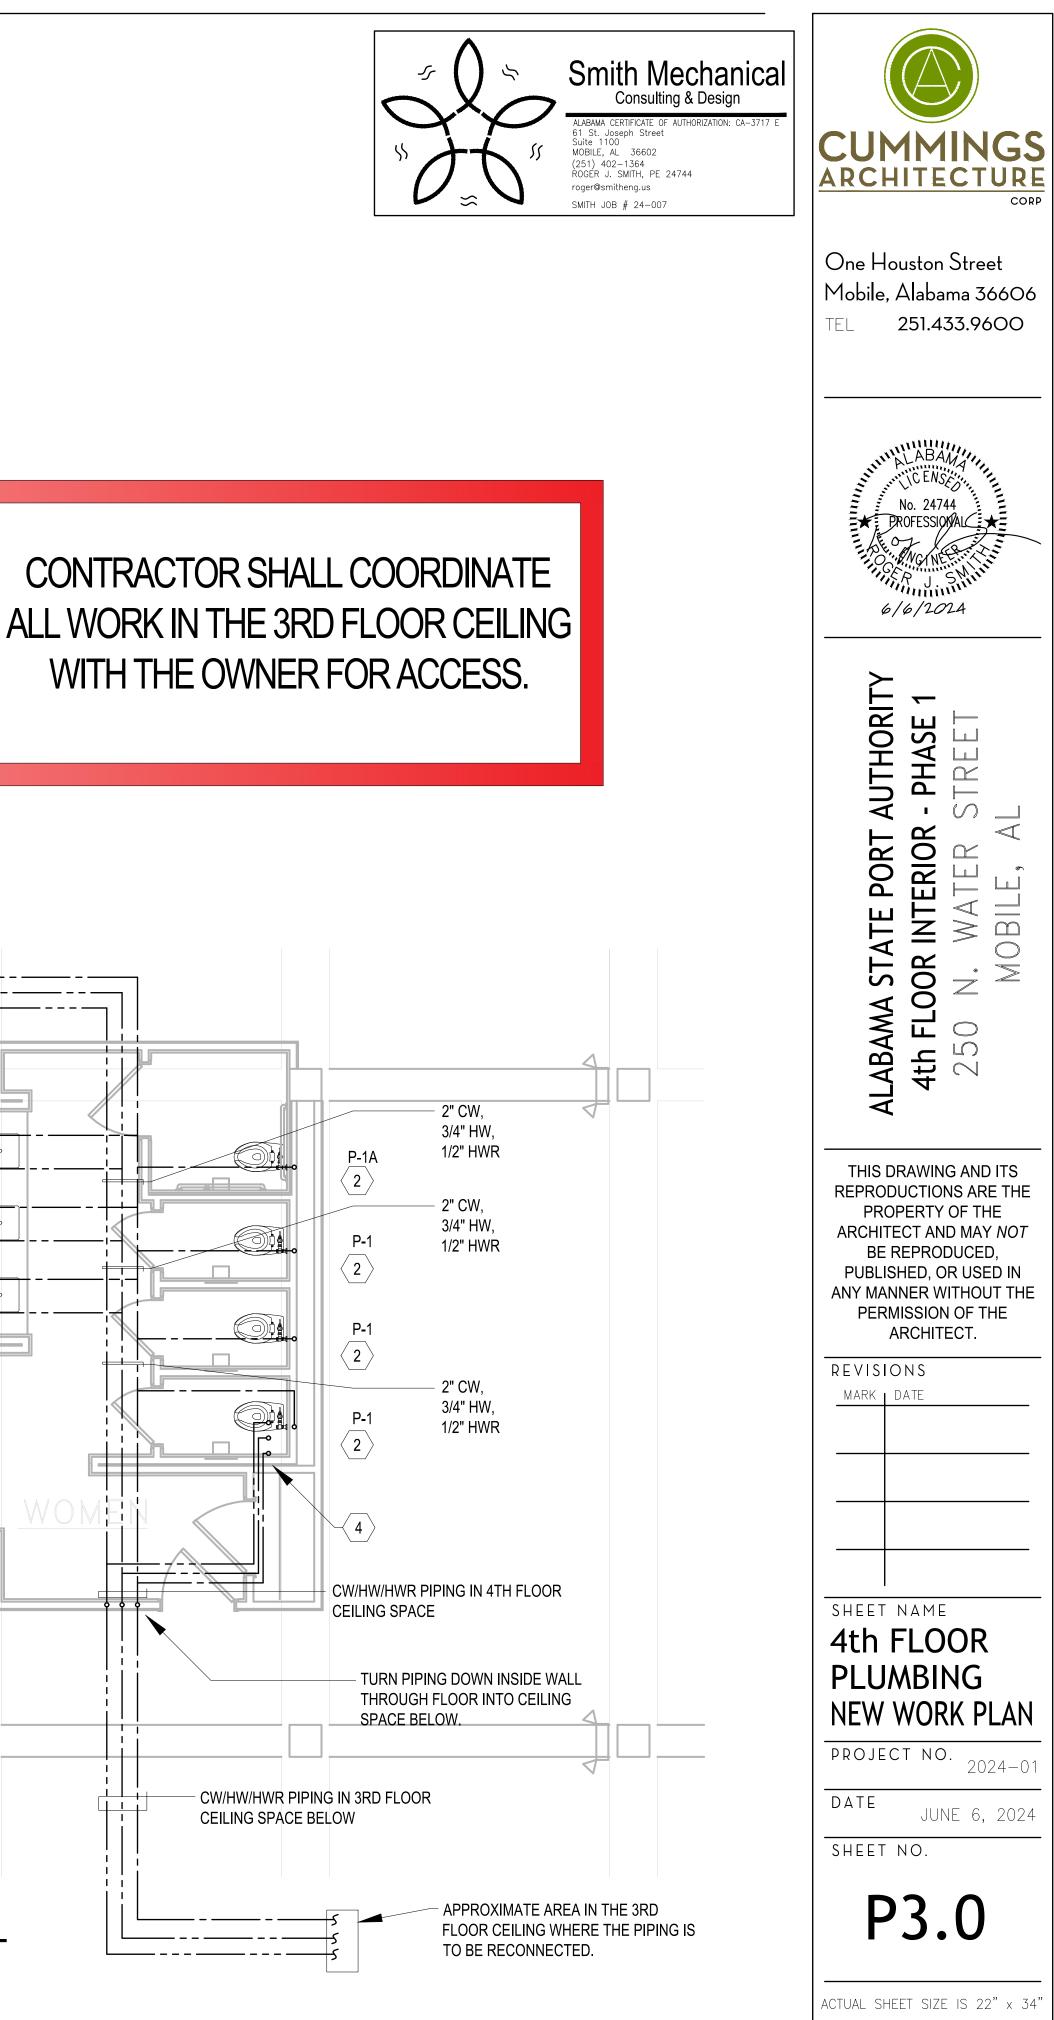


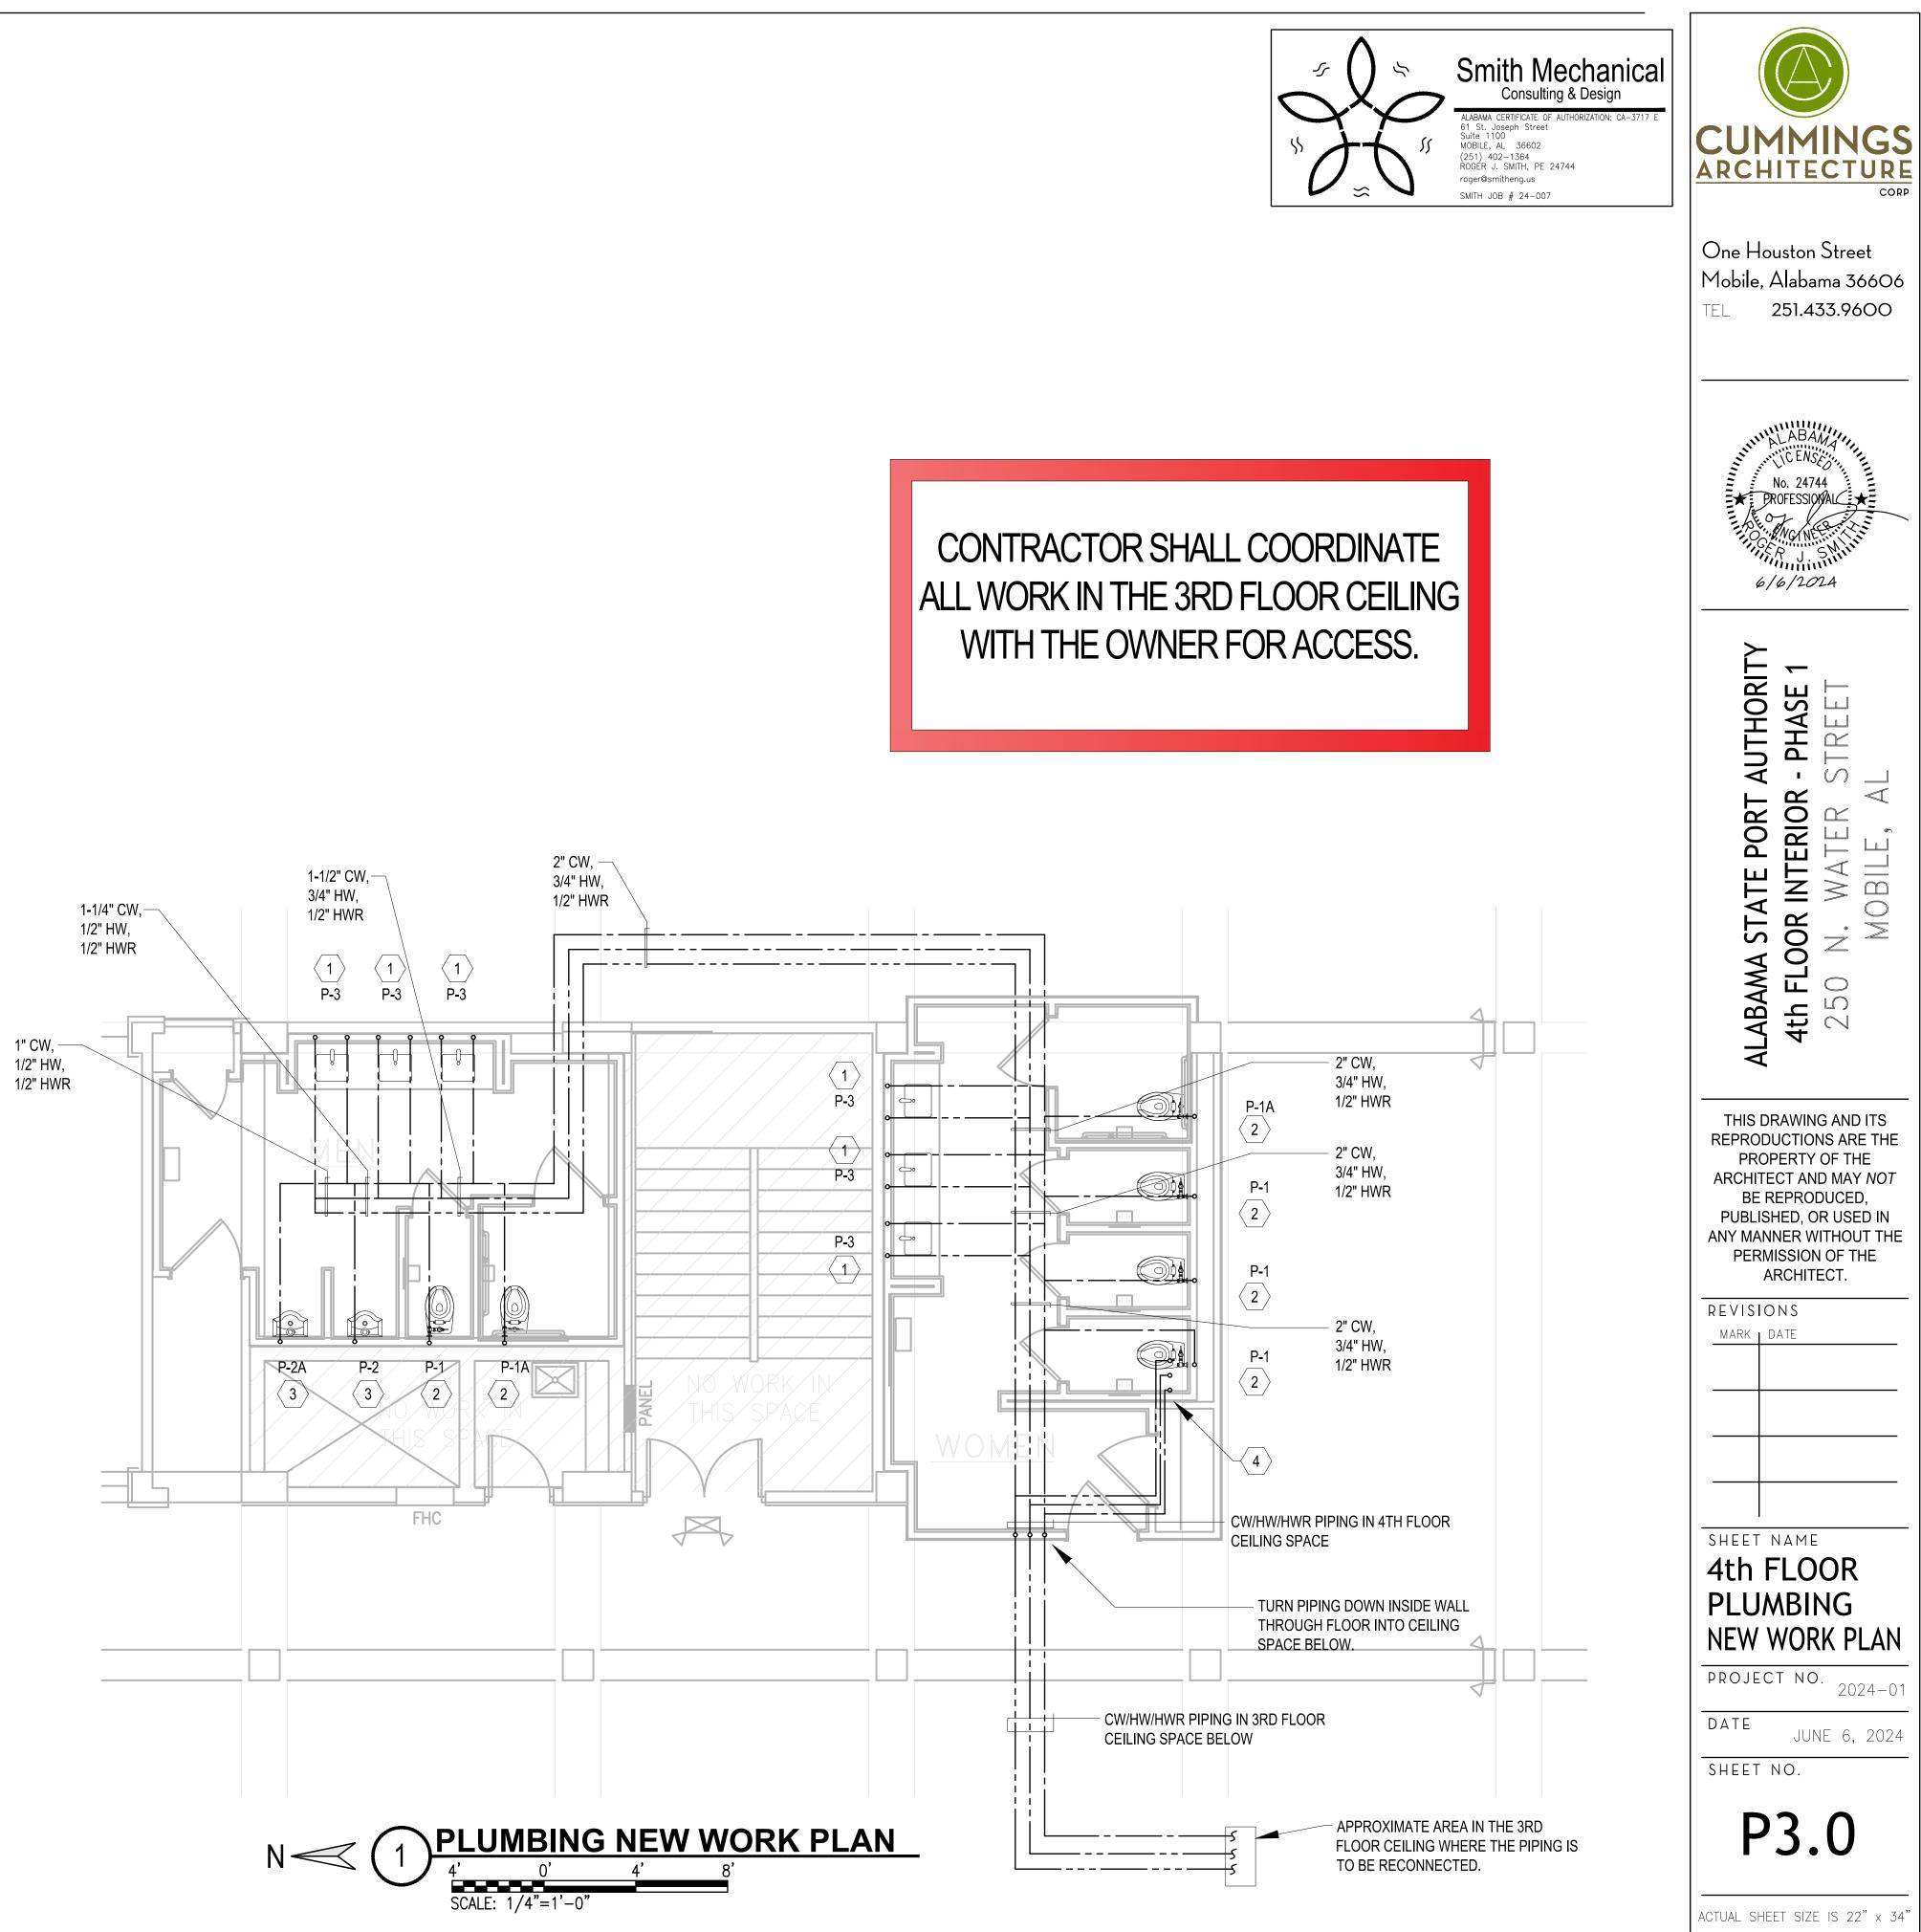


SHEET NOTES

- EXTEND SANITARY VENT PIPING AS NECESSARY FOR CONNECTION TO EXISTING SANITARY VENT THROUGH THE ROOF. FIELD VERIFY A SUITABLE LOCATION FOR CONNECTION TO EXISTING VENT PIPING OR LOCATION OF EXISTING VENT THROUGH THE ROOF.
- \langle 2 \rangle Extend Sanitary Waste Piping in Third Floor Ceiling as Necessary for Connection to EXISTING SANITARY WASTE PIPING. FIELD VERIFY A SUITABLE LOCATION FOR CONNECTION OF NEW TO EXISTING.

CONTRACTOR SHALL COORDINATE ALL WORK IN THE 3RD FLOOR CEILING WITH THE OWNER FOR ACCESS.

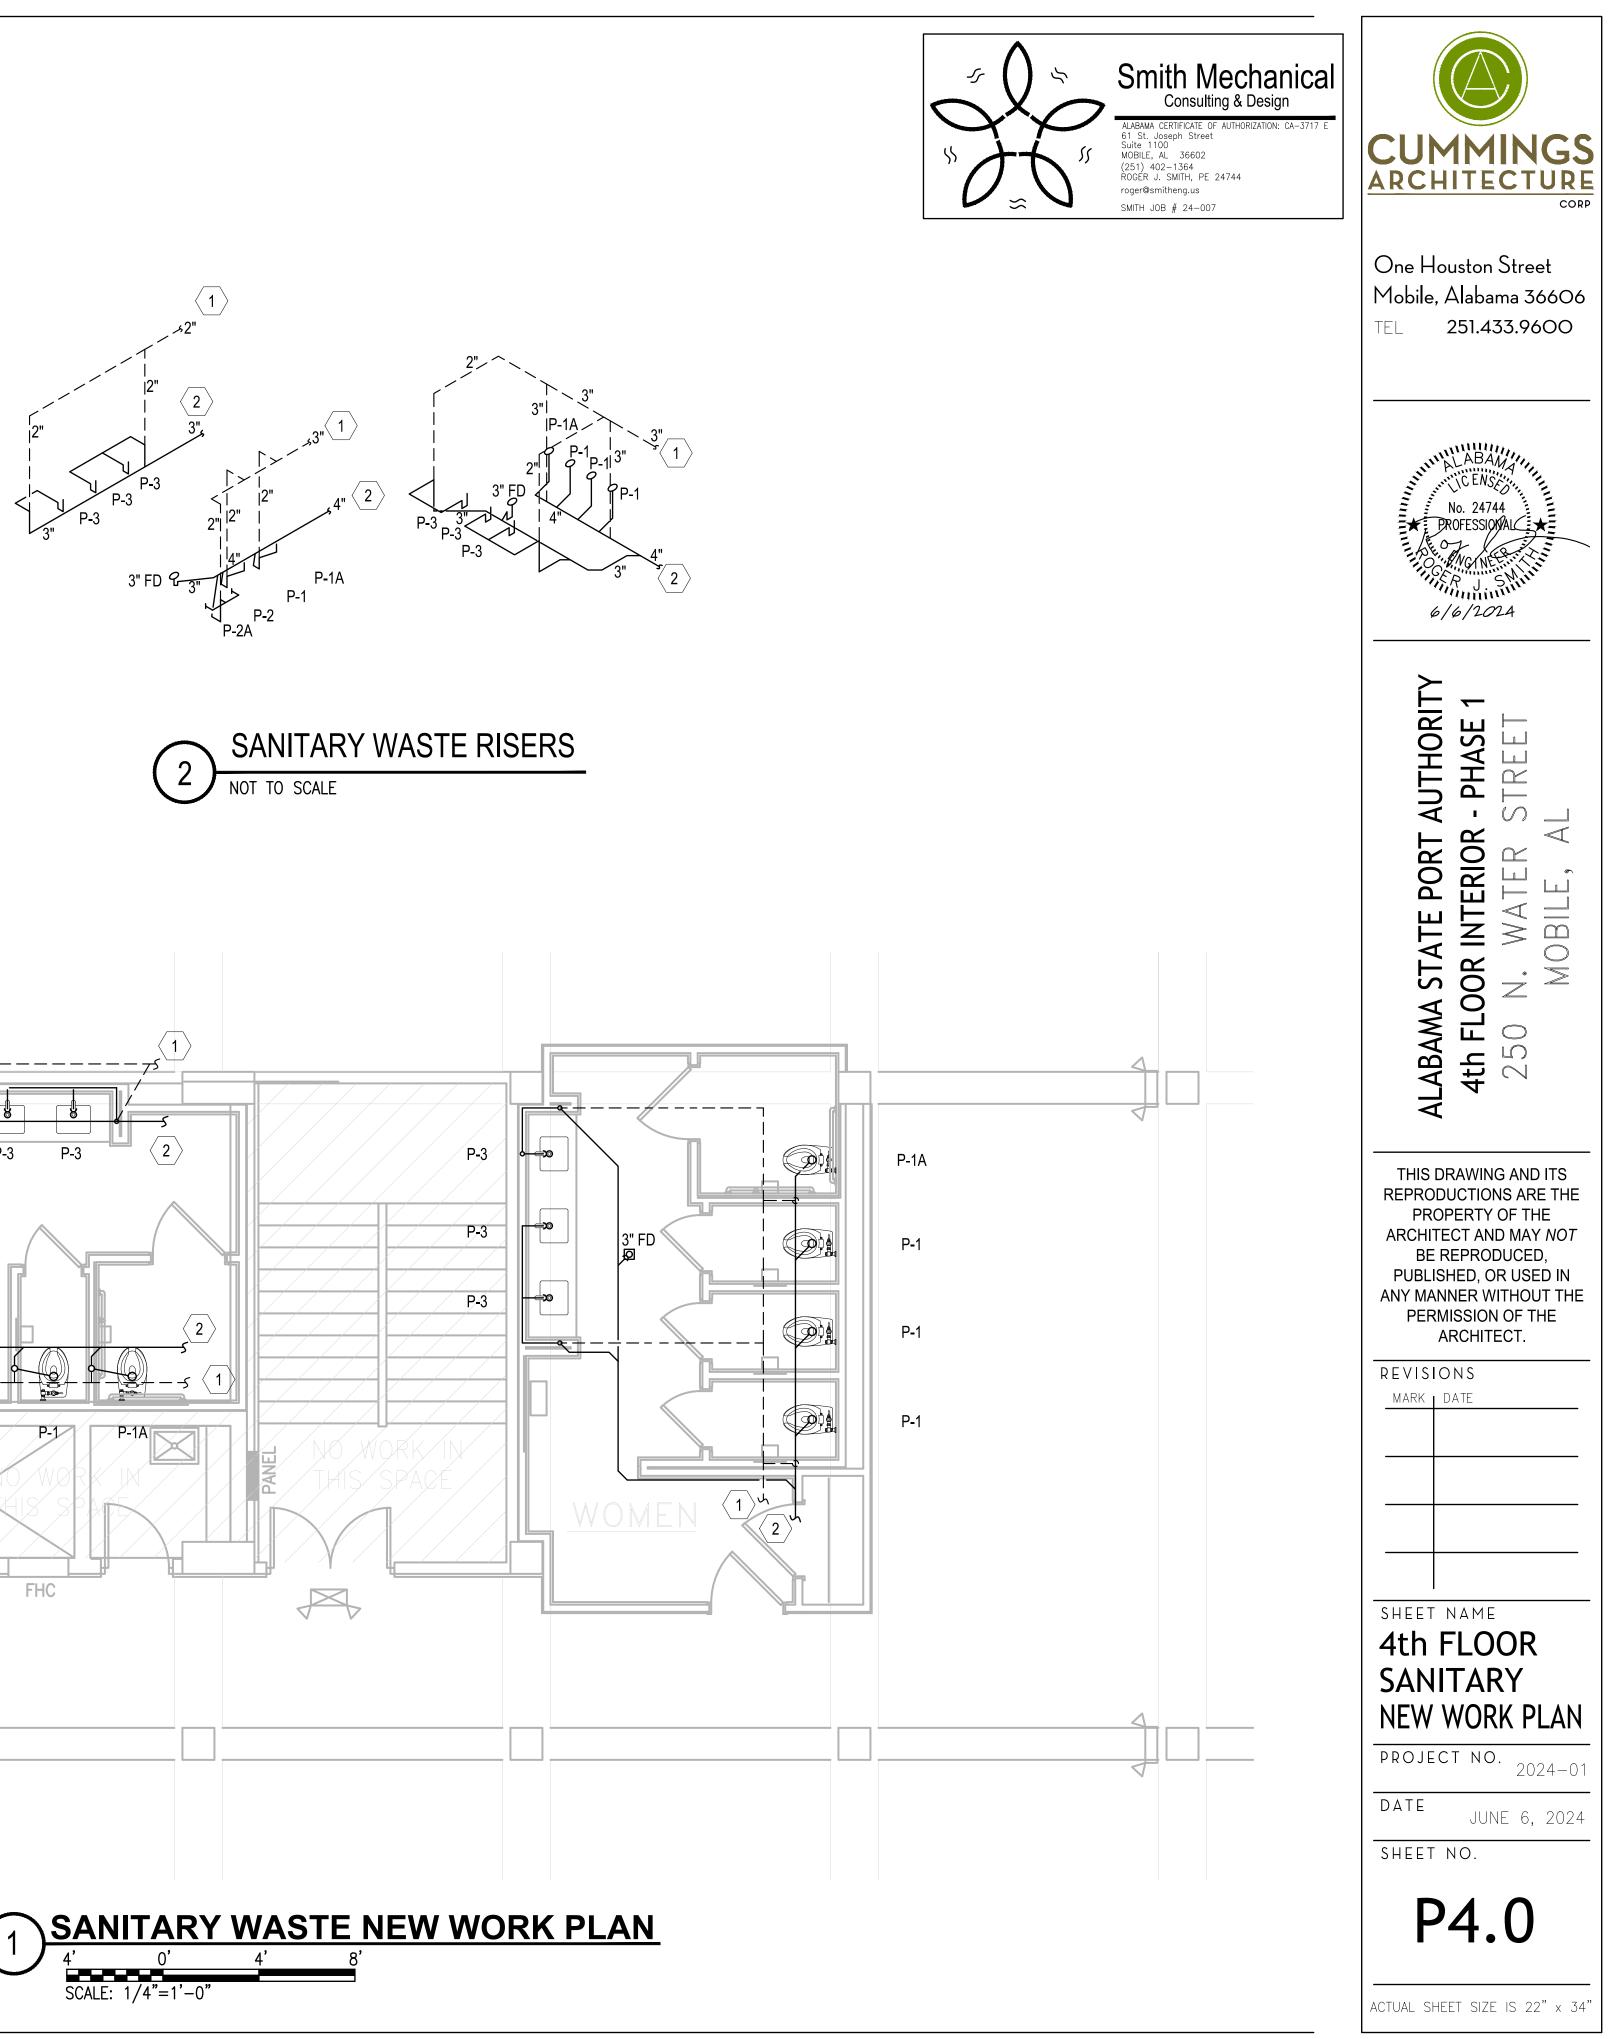



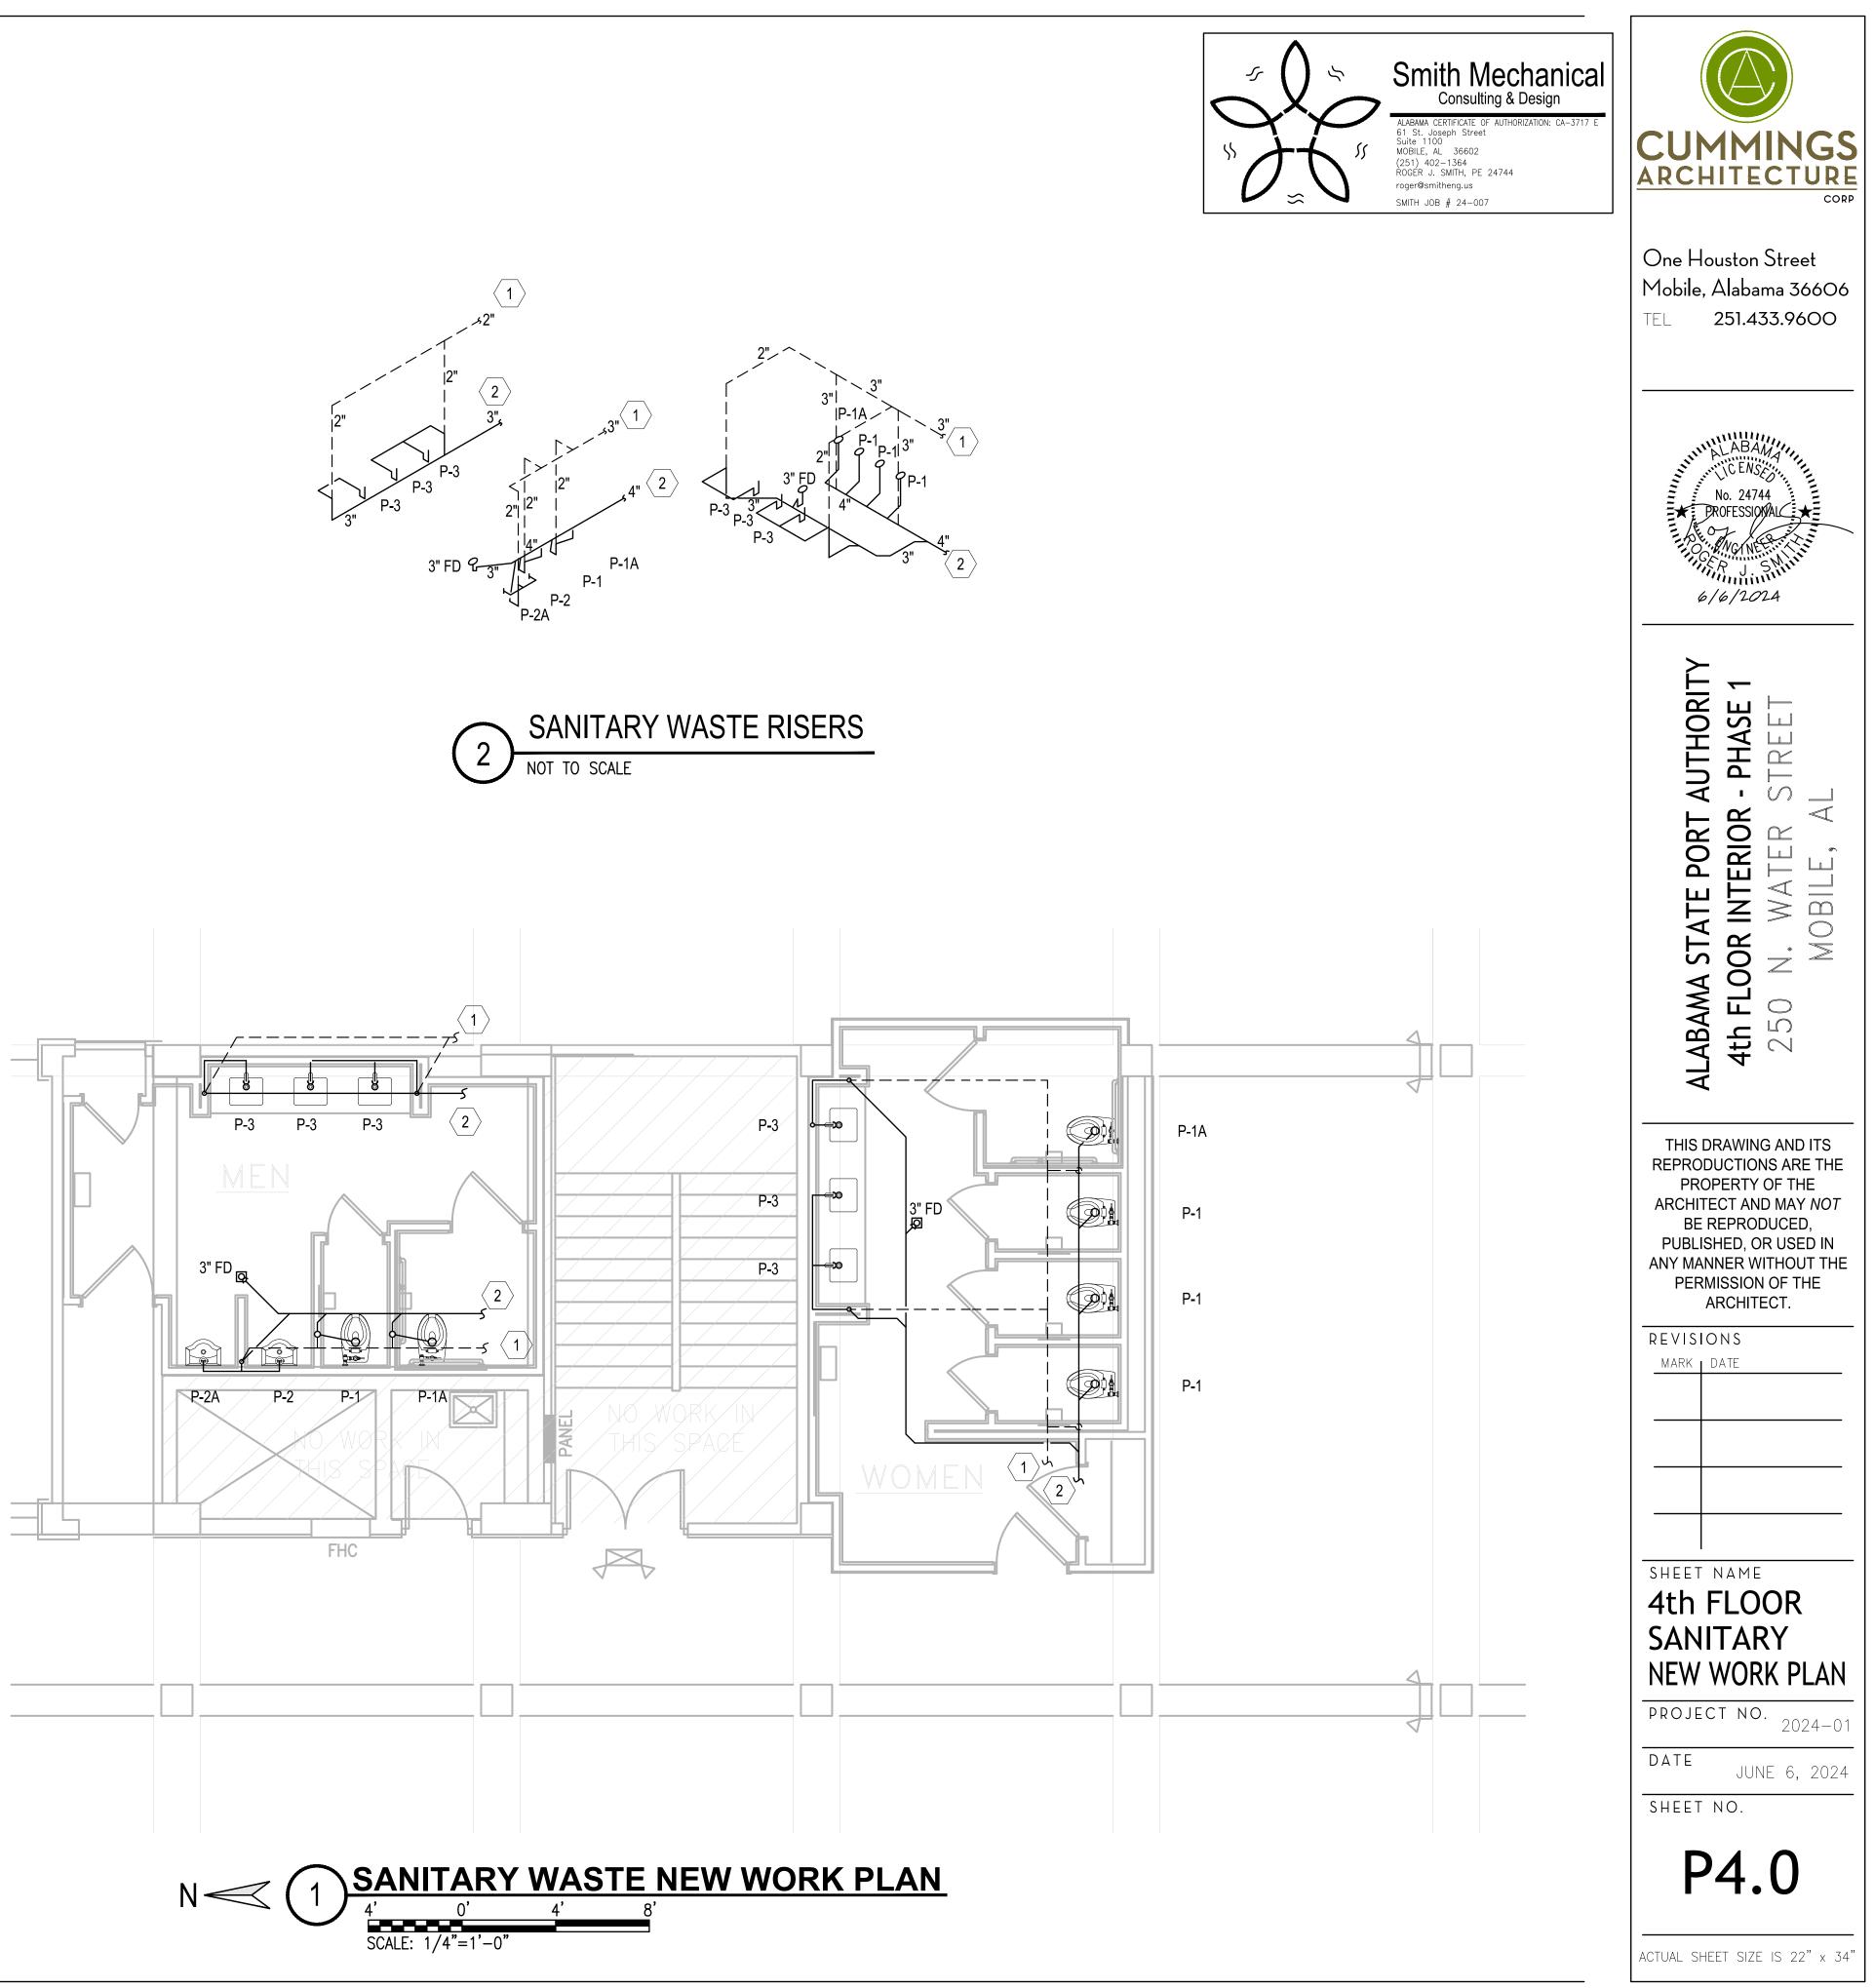

GENERAL PIPING NOTES


- A. ALL BALL VALVES, INCLUDING THOSE USED FOR DRAIN/BLOWDOWN VALVES, GAGE, AIR VENT, COLD WATER MAKE-UP, CHEMICAL TREATMENT AND EXPANSION TANK SERVICE SHALL BE BRONZE BODY, THREADED ENDS, ALL STAINLESS STEEL TRIM AND STAINLESS STEEL LATCH-LOCK HANDLE, MILWAUKEE 20BSOR-02-LL, OR EQUAL BY KITZ OR HAMMOND.
- B. ALL TAPS FOR P/T PORTS, GAGES, DIFFERENTIAL PRESSURE SWITCHES, DRAIN VALVES ETC. SHALL BE MAKE WITH FORGED STEEL THREDOLETS OR WELDED REDUCING TEE IN PIPING SIZE 2 1/2" AND LARGER, GALVANIZED MALLEABLE IRON SCREWED REDUCING TEE IN STEEL PIPING SIZE 2" AND SMALLER, AND SOLDERED TEES IN COPPER PIPING, MOUNT P/T, PORTS IN VERTICAL POSITION.
- C. ALL GAGE (INTERIOR), AIR VENT, DRAIN VALVE, STRAINER BLOWDOWN AND DIFFERENTIAL PRESSURE CONNECTION PIPING SHALL BE SCREWED BRASS PIPE. AIR VENT DISCHARGE PIPING MAY BE HEAVY WALL SOFT COPPER TUBING IF RUN STRAIGHT AND PERPENDICULAR TO BUILDING LINES AND PROPERLY SUPPORTED AT REGULAR INTERVALS.
- PRESSURE/TEMPERATURE TEST PORTS SHALL BE BRASS BODY 1/4" MPT WITH DUAL NORDEL SEALS AND BRASS CAP W/RETAINER STRAP, FLOW DESIGN INC. SUPERSEAL. PROVIDE 2-3/4" LENGTH FOR INSULATED PIPING AND 1-1/4" LENGTH FOR NON-INSULATED PIPING. MOUNT P/T PORTS IN VERTICAL POSITION ACCESSIBLE FOR EASY INSERTION OF TEMPERATURE AND PRESSURE MEASURING DEVICES.
- E. THE USE OF BUSHINGS AND CLOSE NIPPLES FOR THREADED CONNECTIONS OF ANY KIND IS NOT ALLOWABLE.
- F. PROVIDE AUTOMATIC AIR VENTS AT ALL HIGH POINTS IN PIPING AND ELSEWHERE AS INDICATED, SEE TYPICAL DETAILS.
- G. SUPPORT PIPING FROM GROUND WITH GALVANIZED STEEL SCHEDULE 40 PIPE STANDS PRIOR TO FINAL CONNECTION TO PUMPS SUCH THAT NO PIPING WEIGHT IS CARRIED BY PUMP CONNECTIONS.
- H. MECHANICAL CONTRACTOR SHALL INSTALL THRED-O-LETS FOR DDC TEMPERATURE WELLS WHERE REQUIRED BY ENGINEER AND/OR DDC CONTRACTOR.
- I. ALL NEW HOT WATER PIPING SHALL BE INSULATED WITH 1-1/2" THICK SECTIONAL FIBERGLASS WITH AN ASJ JACKET. ALL FITTINGS AND VALVES TO BE PROVIDED WITH PREMOLDED INSULATION SECTIONS.
- J. ALL NEW HYDRONIC PIPING SHALL MATCH EXISTING PIPING MATERIALS.
- K. CONTRACTOR SHALL DRAIN AND REFILL EXISTING HOT WATER SYSTEM AS NECESSARY TO PERFORM THE NEW BRANCH CONNECTION WORK AND PROVIDE NEW CHEMICAL TREATMENT FOR REFILL.
- THE MECHANICAL CONTRACTOR PERFORMING WORK ON THIS PROJECT WILL BE RESPONSIBLE FOR ALL ASSOCIATED ELECTRICAL AND CONTROLS WORK REQUIRED TO SUPPORT THE INSTALLATION OF THE TWO NEW VAV BOXES AND THE INDEPENDENT ELECTRIC THERMOSTATS TO CONTROL THE NEW VAV BOXES. IN A FUTURE CONTROLS UPGRADE. THE BUILDINGS THERMOSTATS WILL BE MODIFIED OR REPLACED WITH A SINGLE SYSTEM. THE TWO NEW BOXES ON THE FOURTH FLOOR WILL OPERATE INDEPENDENT OF THE EXISTING BUILDING HVAC CONTROLS SYSTEM FOR NOW.


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									VAV	BOX S								
	MARK				MIN. INLET STATIC					ŀ	HEATING COIL	-			INLET SIZE	MANUFACTURER	MODEL	
MARK	USE WITH	TOTAL CFM	COOL CFM MIN.	HEATING CFM MIN.	PRESS.	EAT		MBH	EWT	LWT	GPM	MAX. UNIT APD			(IN.)		NUMBER	
	VVIIII				(IN.)	(°F)	(°F)	(MIN.)	(°F)	(*⊦)		(IN.)	(FT.)	TYPE AND SIZE	,			
VAV 4-19	AHU-2	230	130	130	0.5"	55.0	95.0	5,600	180.0	140.0	0.56	0.35	2.0	2-WAY / 1/2"	5"Ø	TITUS	DESV	1, 2
VAV 4-20	AHU-2	200	130	130	0.5"	55.0	95.0	5,600	180.0	140.0	0.56	0.35	2.0	2-WAY / 1/2"	5"Ø	TITUS	DESV	1, 2

NOTES: 1. COORDINATE ALL ELECTRICAL REQUIREMENTS WITH THE ELECTRICAL CONTRACTOR. CONTROL VALVES SHALL BE PROVIDED WITH A TRANSFORMER. ON THE 4TH FLOOR, PROVIDE A 120V/1Ø TRANSFORMER. 2. BASIS OF DESIGN TITUS SDEV WITH HOT WATER COIL REHEAT.

3. VAV BOX TO BE CONTROLLED WITH A TWO WAY WAY CONTROL VALVE CONNECTED TO A LOCAL THERMOSTAT.


- **GENERAL NOTES**
- THE MECHANICAL CONTRACTOR IS REQUIRED TO HAVE A GENERAL CONTRACTORS LICENSE AND SHALL COORDINATE WITH ASPA PROJECT MANAGER AND OTHER TRADES AS NECESSARY FOR REQUIRED OPENINGS IN WALLS, FOUNDATIONS, FLOORS, AND ROOFS.
- THE MECHANICAL CONTRACTOR TO VERIFY MECHANICAL EQUIPMENT LOCATIONS AND BE RESPONSIBLE FOR ALL RELATED CLEARANCES IN THE FIELD. PROVIDE ADEQUATE MAINTENANCE CLEARANCE AROUND EACH PIECE OF EQUIPMENT PER THE MANUFACTURER'S RECOMMENDATIONS. PROVIDE CLEARANCE IN FRONT OF ELECTRICAL PANELS AND OTHER ELECTRICAL EQUIPMENT PER THE NATIONAL ELECTRICAL CODE REQUIREMENTS. COORDINATE WITH THE CONTROLS CONTRACTOR AND ELECTRICAL CONTRACTORS IN THE FIELD.
- PIPING SHOWN IN THESE DRAWINGS ARE DIAGRAMMATIC. ARRANGE IN A NEAT AND ORDERLY MANNER.
- 4. PENETRATIONS THROUGH FIRE RATED FLOORS AND WALLS ARE TO BE FIRE SEALED SO AS TO MAINTAIN FLOOR OR WALL INTEGRITY IN THE EVENT OF A FIRE.
- VERIFY COLLAR SIZES ON ALL EQUIPMENT INLETS AND OUTLETS. TRANSITION DUCTWORK AS NECESSARY. EXTERNALLY INSULATE ALL TRANSITIONS AT EQUIPMENT CONNECTIONS.
- INSTALL EQUIPMENT AND DUCTWORK TO MANUFACTURERS RECOMMENDED CLEARANCES.
- 7. PENETRATIONS OF FIREWALLS, CEILINGS, FLOORS, ETC. FOR PIPING TO BE UL LISTED FIRESTOPS AND SHALL BE INSTALLED AS PER MANUFACTURER'S RECOMMENDATION. CONTRACTOR TO OBTAIN MANUFACTURER SHOP DRAWINGS AT JOBSITE FOR PENETRATIONS.
- 8. PROVIDE FLEXIBLE DUCT, PIPE CONNECTIONS, AND VIBRATION ISOLATORS FOR INTERNALLY ISOLATED UNITS.
- DO NOT MOUNT DISCONNECT SWITCHES ON HVAC EQUIPMENT.
- 10. ALL ROUND FLEXIBLE DUCT TO BE FACTORY PRE-INSULATED. MAXIMUM LENGTH OF ANY FLEXIBLE DUCT RUNOUT TO BE 6 FT. WHERE LENGTH REQUIRED EXCEEDS 6 FT, INSTALL EXTERNALLY INSULATED ROUND SNAPLOCK DUCT FOR BALANCE OF DISTANCE TO SPIN-IN TAP AT MAIN DUCT TRUNK.
- 11. SUPPLY AIR DUCTWORK TO BE SINGLE WALL LOW PRESSURE RECTANGULAR, SMACNA STATIC PRESSURE CLASS 250 Pa (1" W.G.), SEAL CLASS A, EXTERNALLY INSULATED WITH 2" THICK R-8 FIBERGLASS DUCT WRAP. DUCT SIZES INDICATED ARE INSIDE CLEAR DIMENSIONS.
- 12. RETURN AIR DUCTWORK TO BE SINGLE WALL LOW PRESSURE RECTANGULAR, SMACNA STATIC PRESSURE CLASS 250 Pa (1" W.G.), SEAL CLASS A. DUCT SIZES INDICATED ARE INSIDE CLEAR DIMENSIONS. PROVIDE 2" THICK R-8 EXTERNAL FIBERGLASS DUCT WRAP.
- 13. EXHAUST AIR DUCTWORK TO BE LOW PRESSURE SINGLE WALL RECTANGULAR, SMACNA STATIC PRESSURE CLASS 250 Pa (1" W.G.), SEAL CLASS A. EXHAUST DUCT IS NOT REQUIRED TO BE INSULATED.
- 14. AVOID ROUTING DUCTWORK OVER LIGHTS WHEREVER POSSIBLE. MAINTAIN MINIMUM 6" CLEARANCE BETWEEN DUCT INSULATION TO TOP OF LIGHTS.
- 15. WORK SHALL COMPLY WITH THE FOLLOWING AGENCIES -2021 INTERNATIONAL BUILDING CODE -2021 INTERNATIONAL MECHANICAL CODE -2015 INTERNATIONAL ENERGY CONSERVATION CODE -NATIONAL FIRE PROTECTION AGENCY (NFPA) -AMERICAN SOCIETY OF HEATING AND REFRIGERATION ENGINEERS (ASHRAE) -NATIONAL ELECTRIC CODE NFPA 70
- 16. ALL WORK AND EQUIPMENT SHALL BE PROVIDED WITH A TWO YEAR WARRANTY STARTING FROM THE TIME OF SUBSTANTIAL COMPLETION OF THE PROJECT AS DETERMINED BY THE ASPA PROJECT MANAGER.

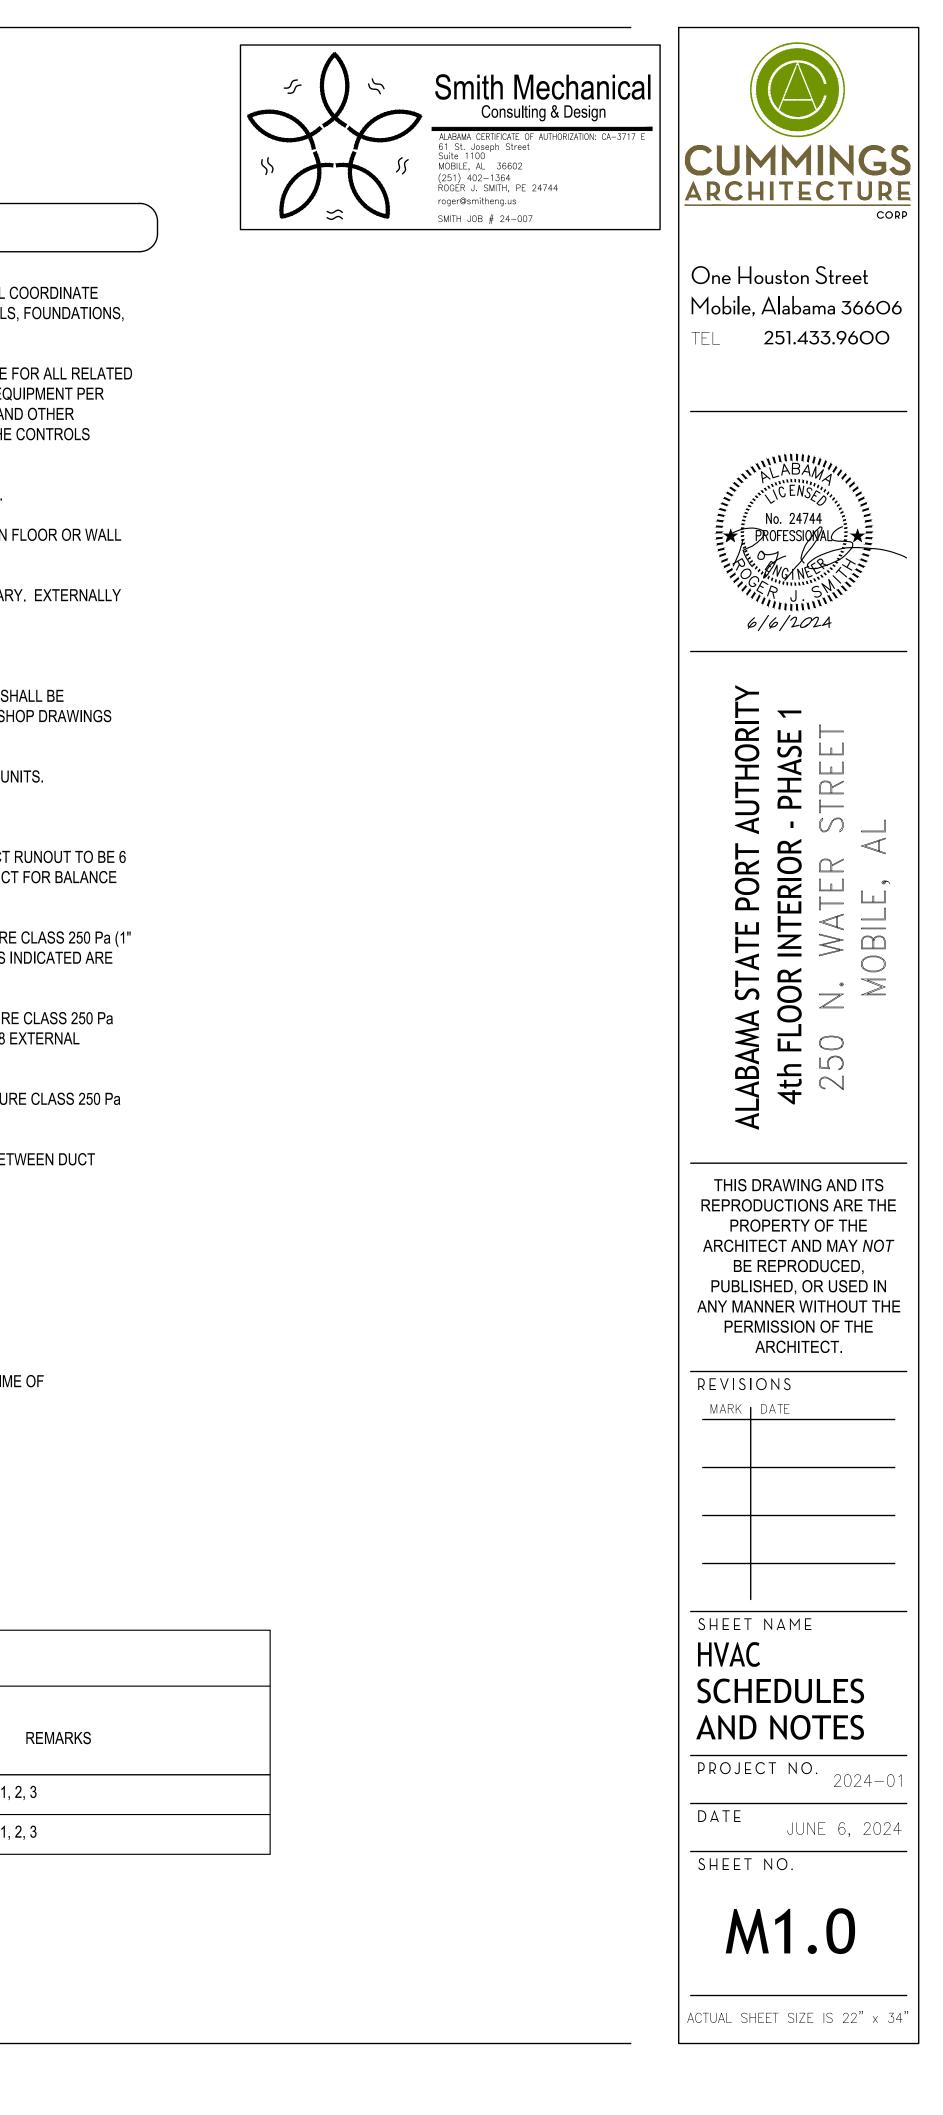


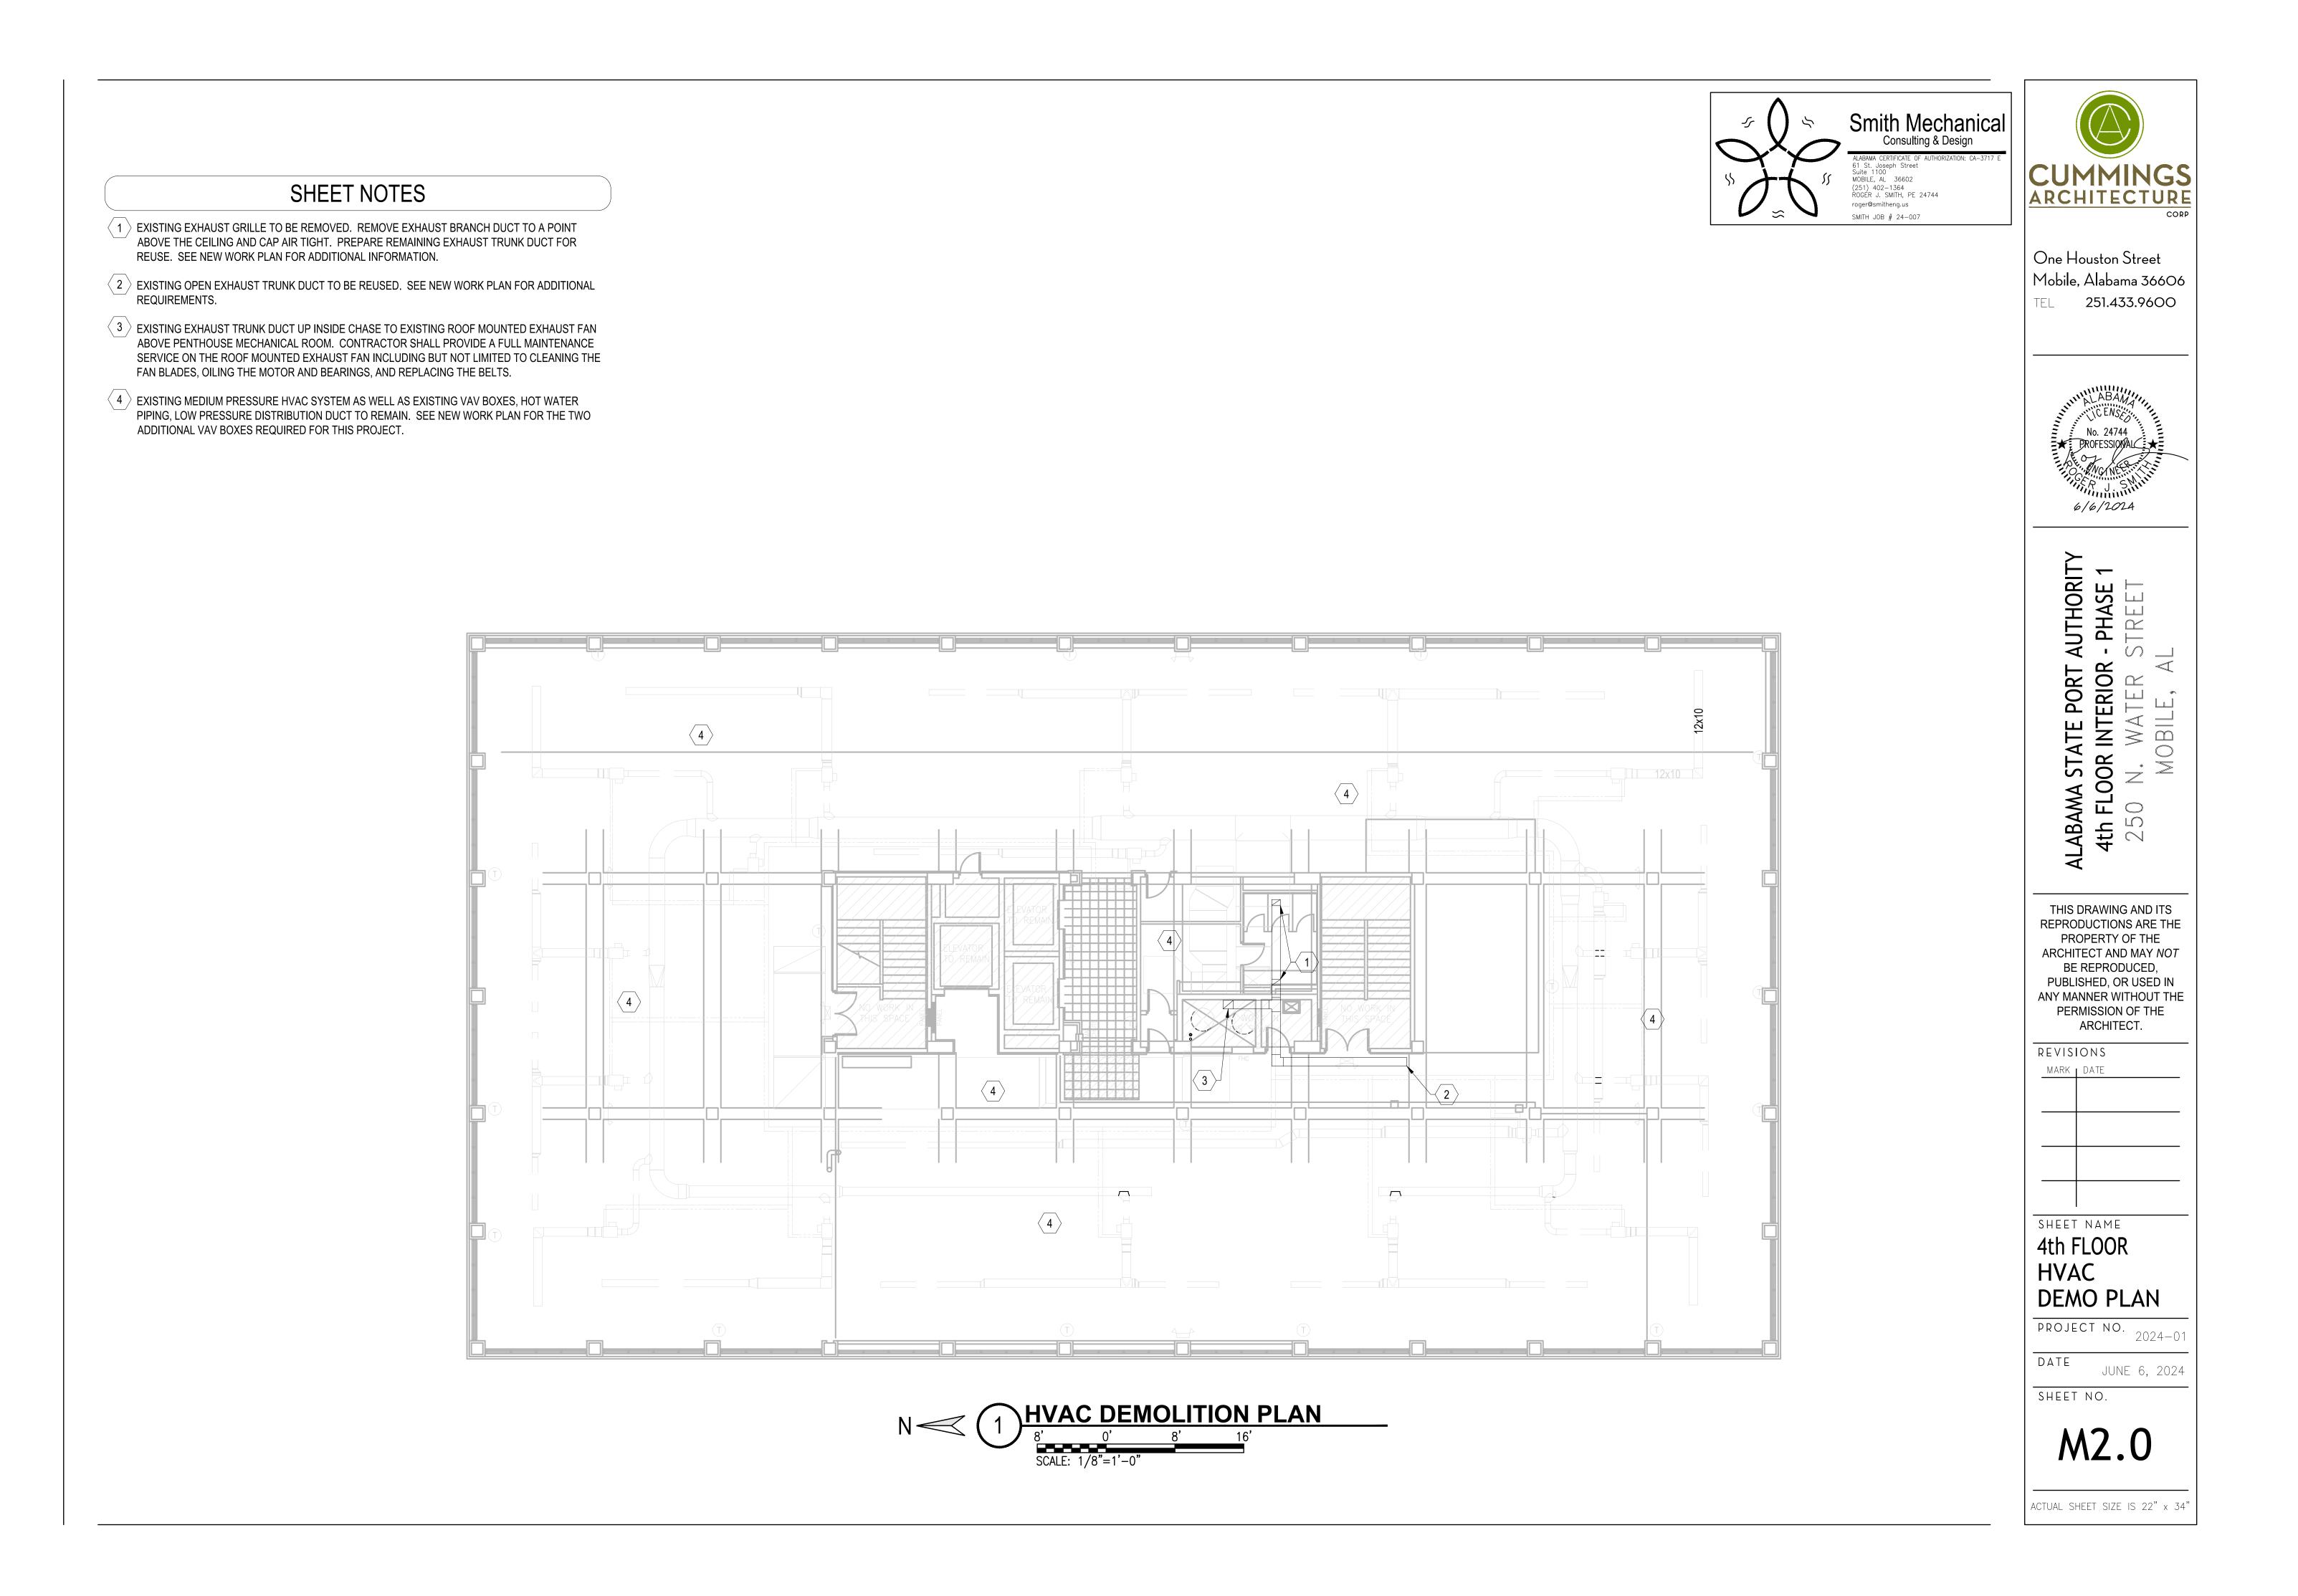

	SHEET N	OTES
1 9"x9" TITUS TDC-AA CEILING GRILLE WITH 7"Ø CONNE CEILING TILE. GRILLE SHALL NOT BE PROVIDED WITH ANGLE BRACING BEHIND GRILLE TO PREVENT SAGG FOR 40 CFM.	H LAY-IN PANEL. PROVIDE SUPPLEMENTAL	9 NE CO LA ME
2 9"X9" TITUS TDC-AA CEILING GRILLE WITH 7"Ø CONNE BALANCE AIR DEVICE FOR 150 CFM.	ECTION WITH 24"X24" LAY-IN PANEL.	FO
9"X9" TITUS TDC-AA CEILING GRILLE WITH 7"Ø CONNE BALANCE AIR DEVICE FOR 40 CFM.	ECTION WITH 24"X24" LAY-IN PANEL.	
6"x6" TITUS 350 FL EXHAUST GRILLE WITH BALANCING CEILING TILE. GRILLE SHALL NOT BE PROVIDED WITH ANGLE BRACING BEHIND GRILLE TO PREVENT SAGG FOR 50 CFM.	H LAY-IN PANEL. PROVIDE SUPPLEMENTAL	
5 CONNECT NEW 10x8 EXHAUST DUCT TO EXISTING EX DUCT AS NECESSARY FOR CONNECTION TO EXISTIN		
PROVIDE NEW 10x4 BRANCH EXHAUST DUCT TO NEW	/ EXHAUST GRILLE.	
7 $>$ PROVIDE NEW 10x8 BRANCH EXHAUST DUCT TO NEW	/ EXHAUST GRILLES.	
8 NEW 1/2" HOT WATER SUPPLY AND RETURN PIPING T MAINS. FIELD VERIFY A SUITABLE LOCATION FOR CO		
		0

EW VAV BOX. INSTALL IN A LOCATION WHERE ACCESS THROUGH CEILING TILE IS AVAILABLE. YOUT. EXTEND NEW MEDIUM PRESSURE BRANCH DUCT WITH NEW TAP FROM EXISTING EDIUM PRESSURE DUCT GENERALLY WHERE SHOWN. FIELD VERIFY A SUITABLE LOCATION OR CONNECTION OF THE NEW BRANCH TAP.

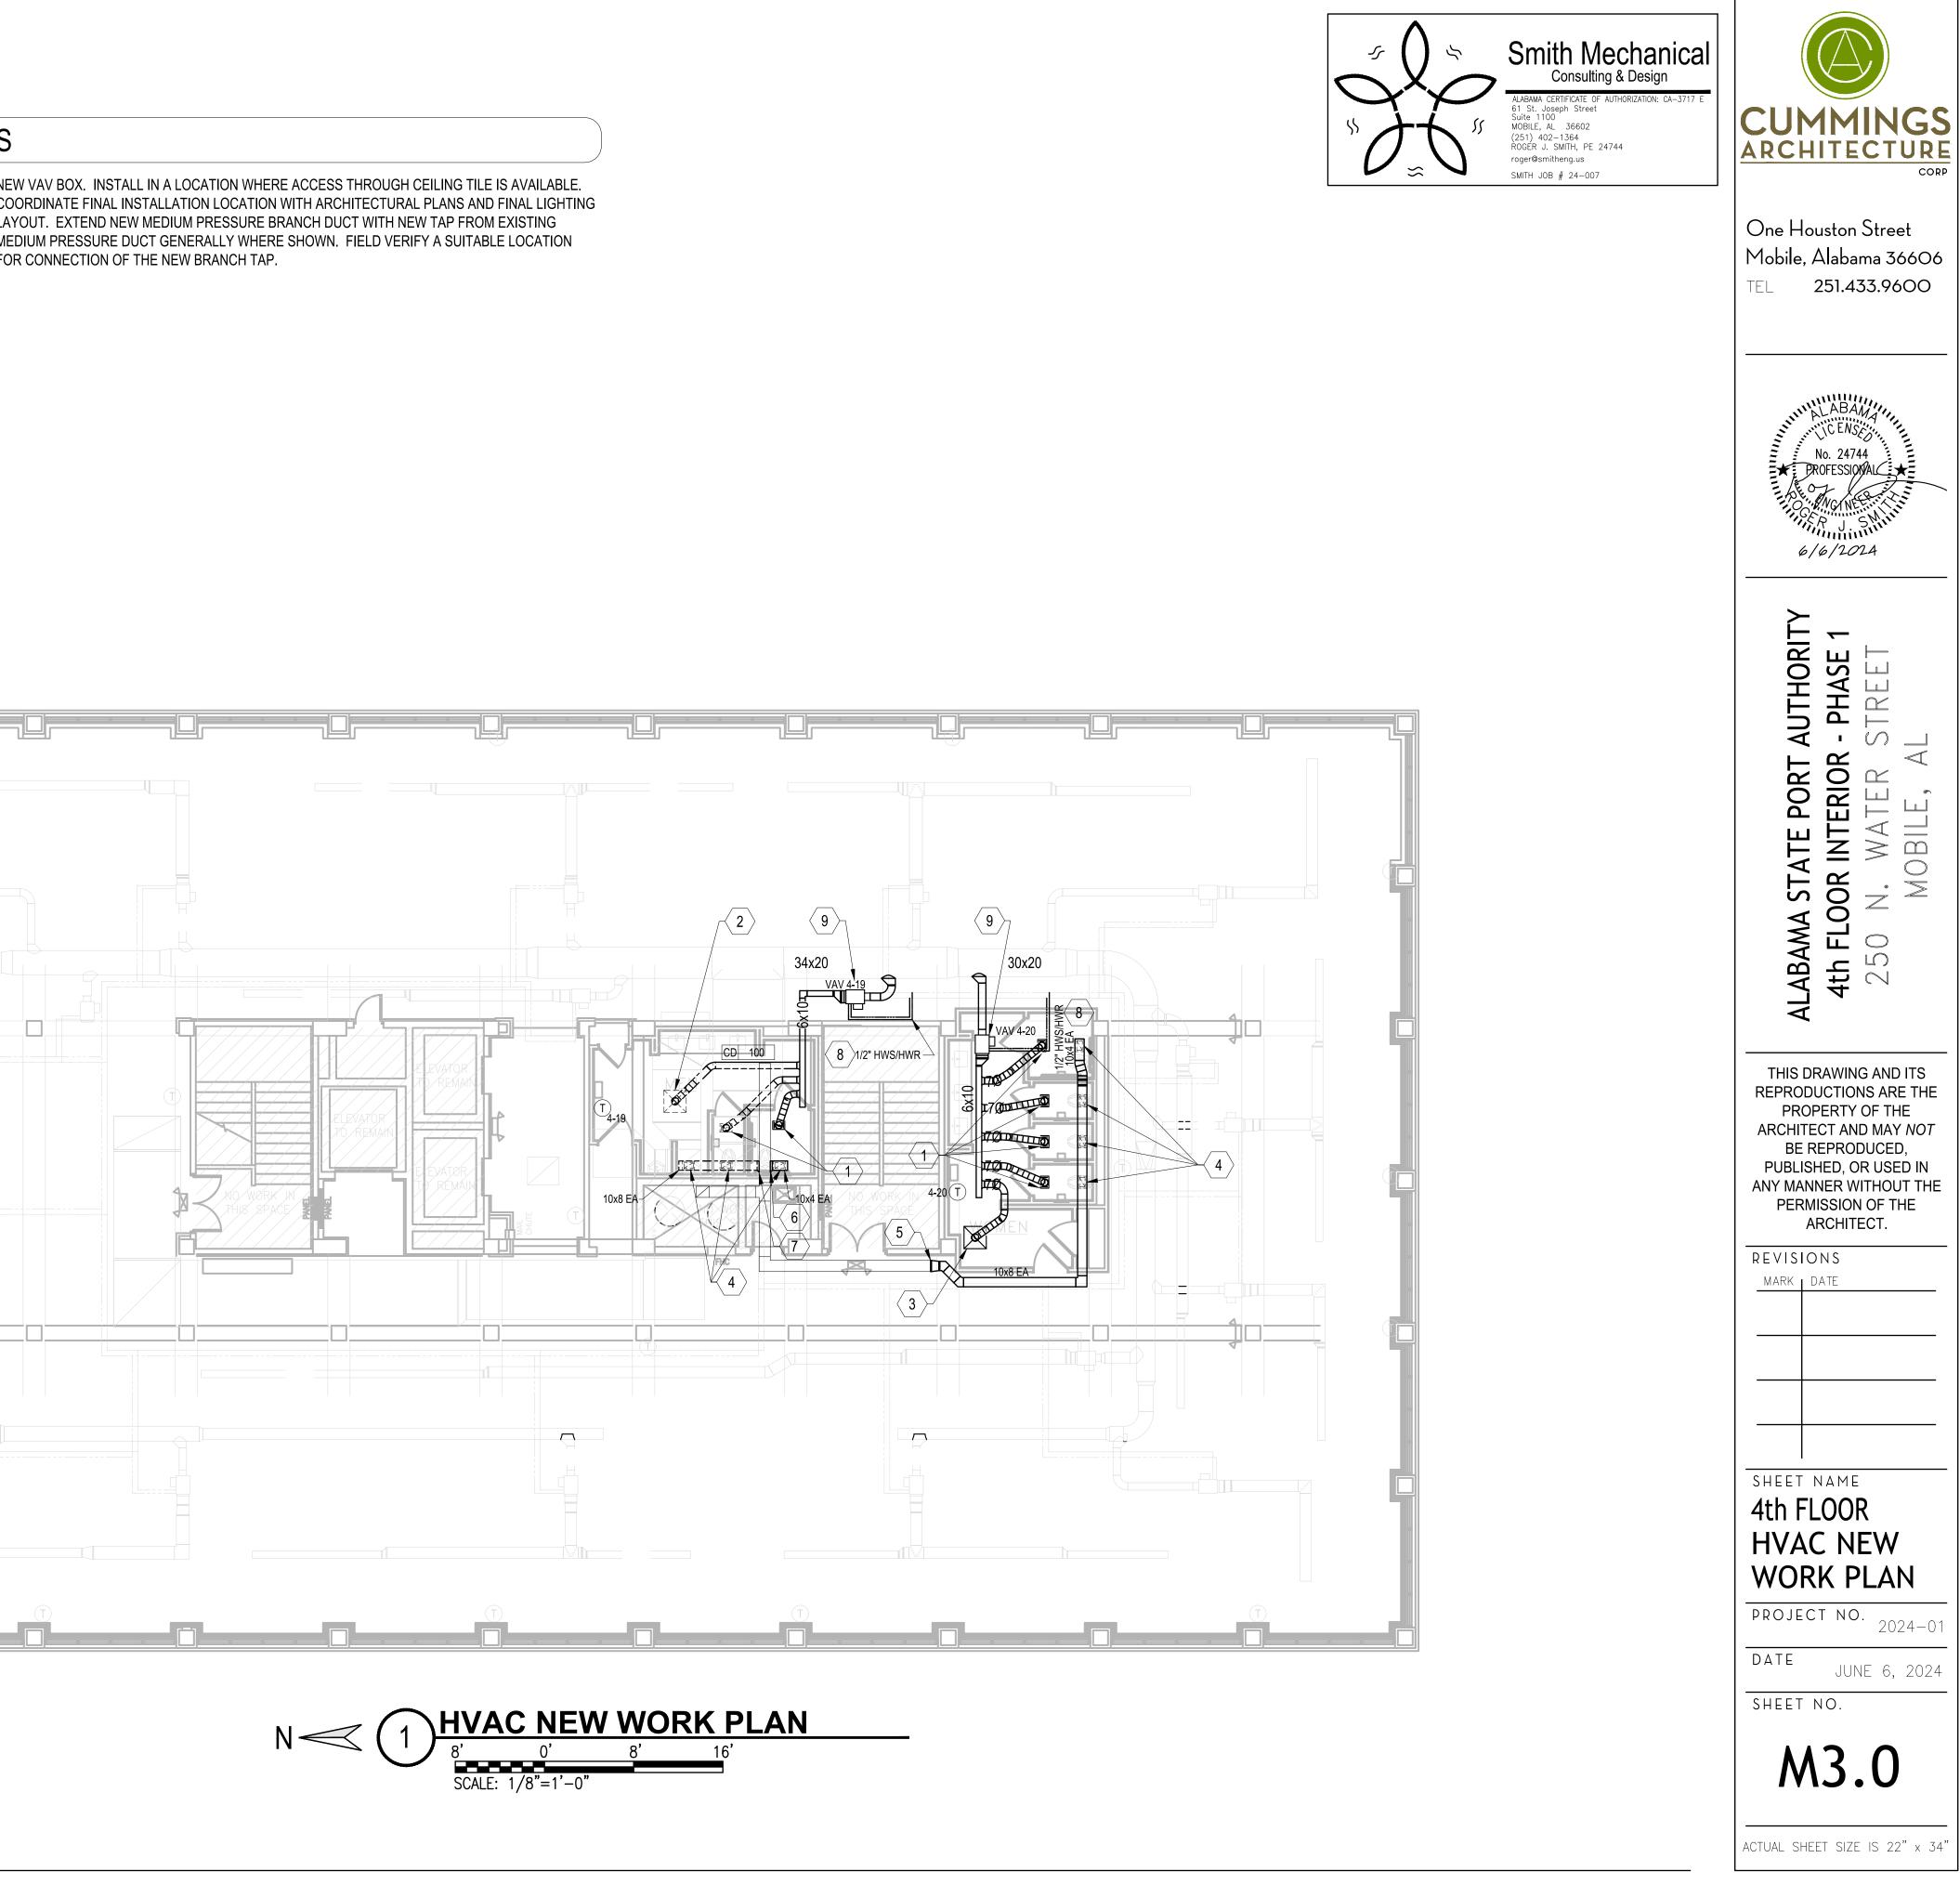

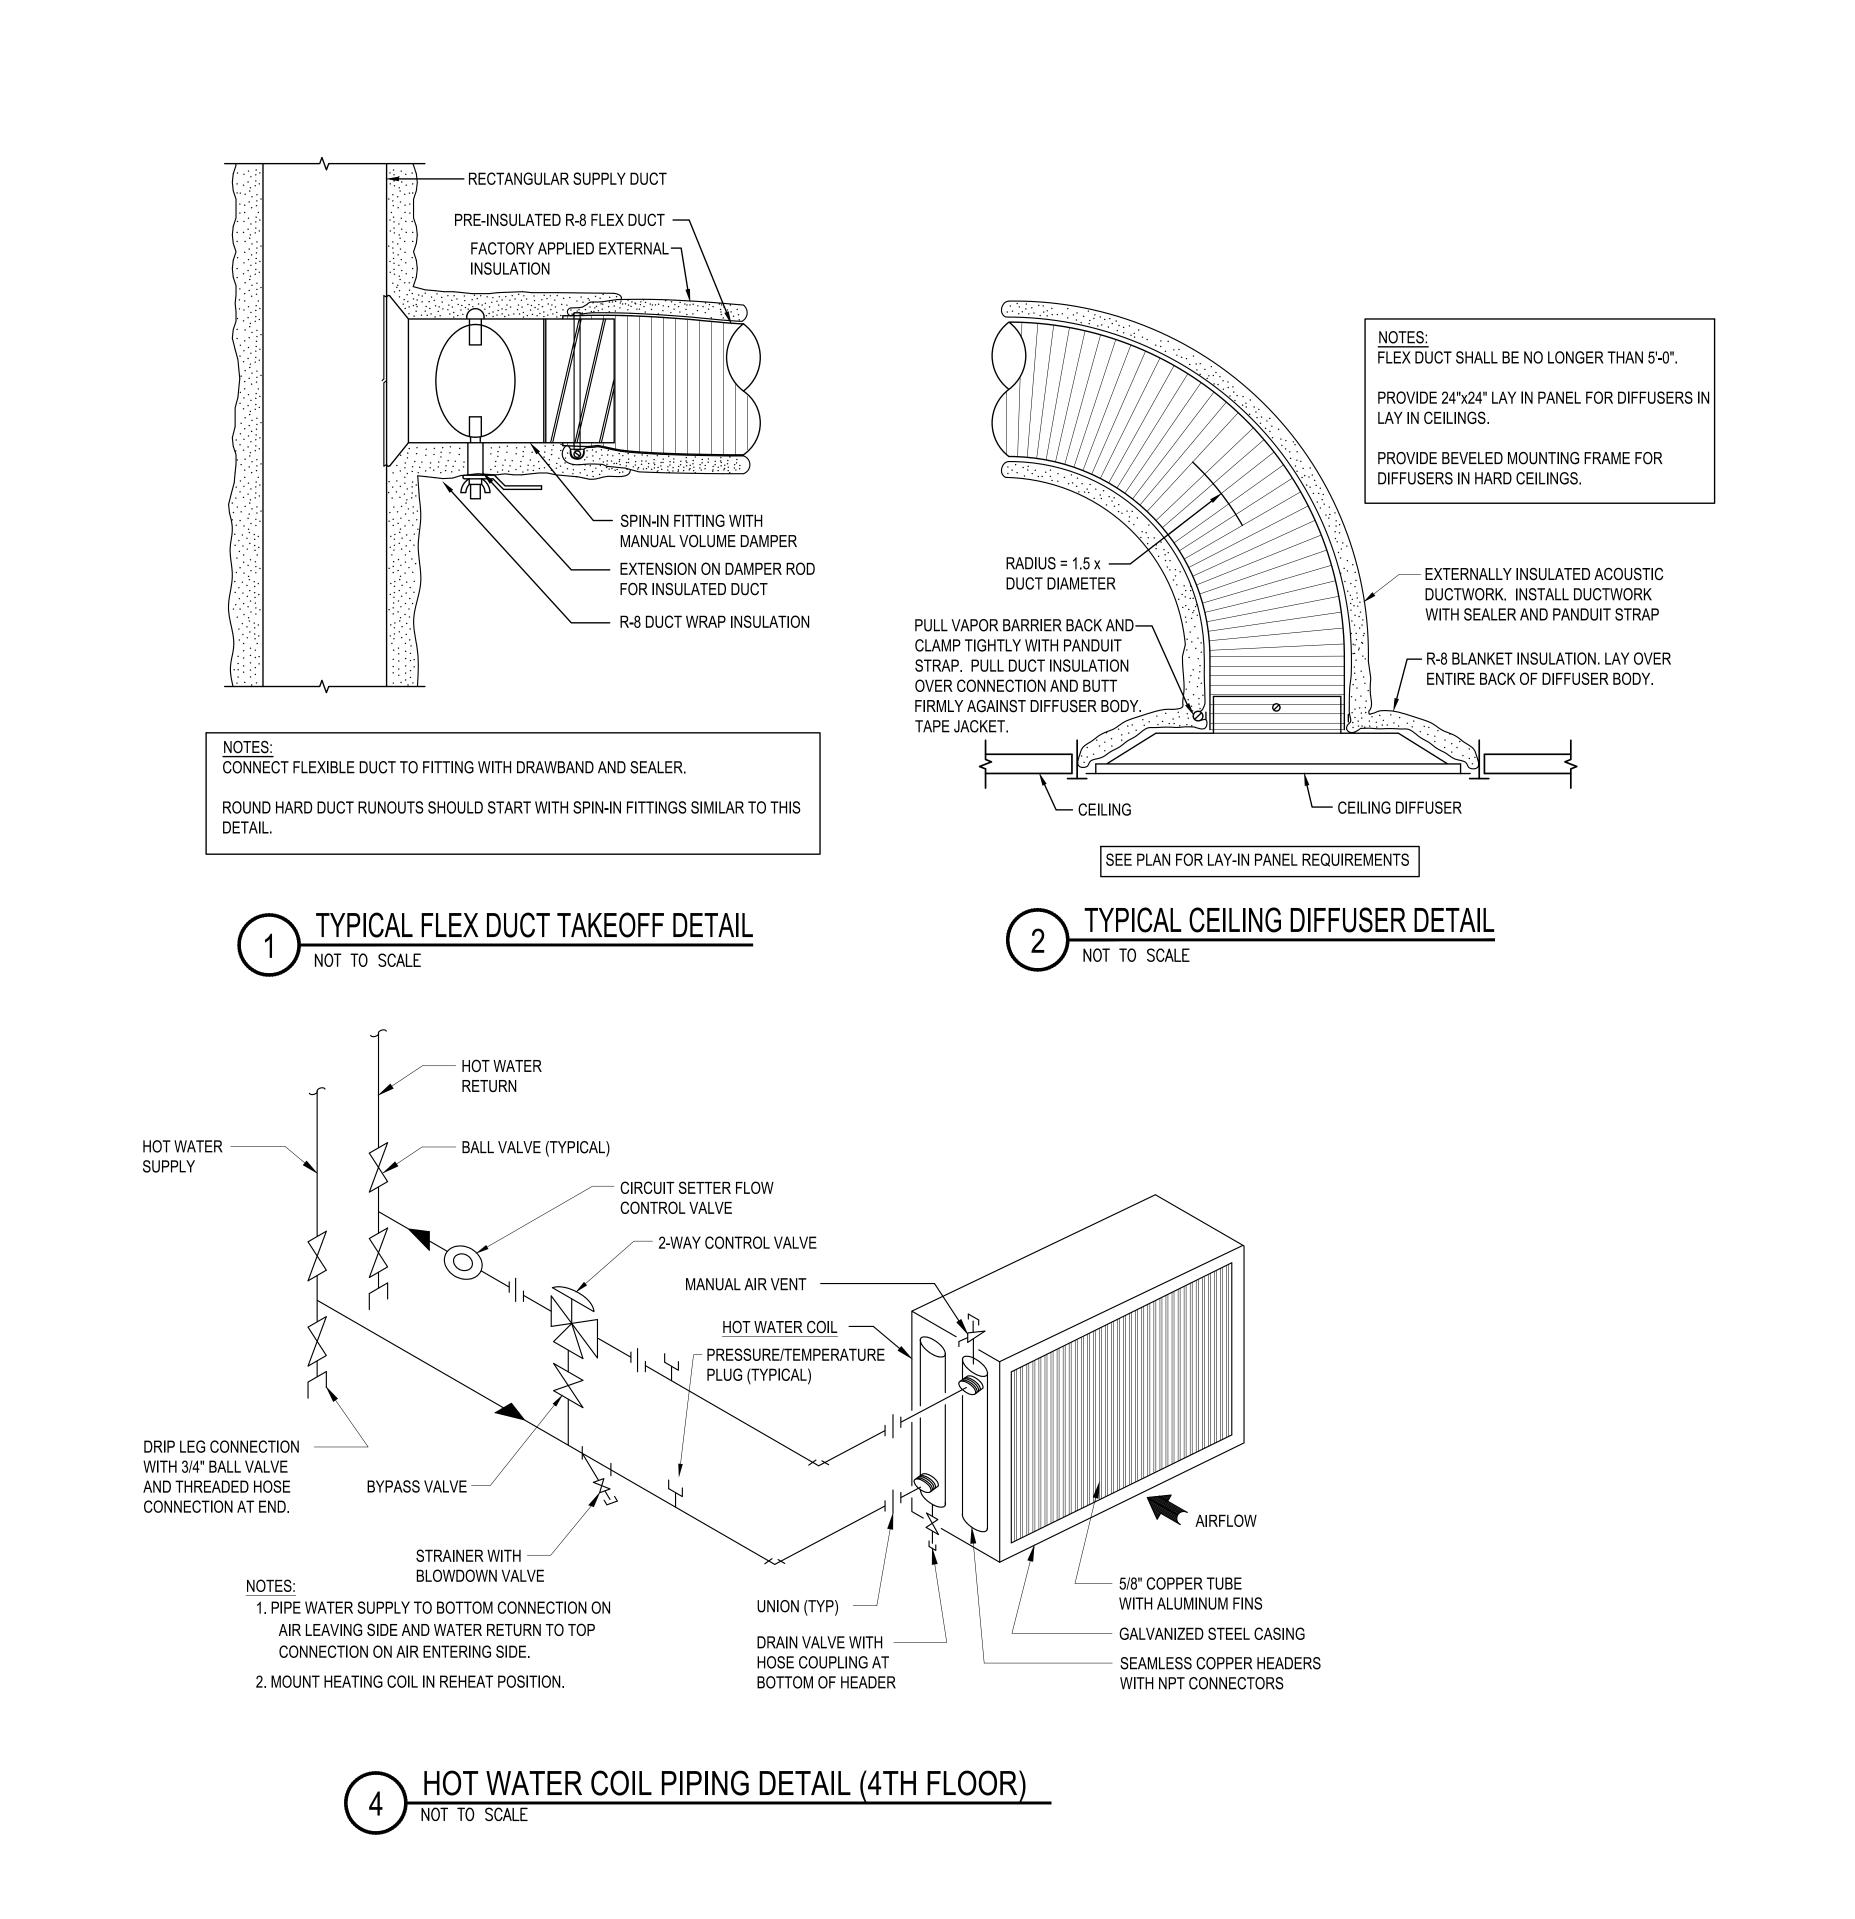

Sinth Mechanical Consulting & Design ALABAMA CERTIFICATE OF AUTHORIZATION: CA-3717 E Gi St. Joseph Street Suite 1100 MOBILE, AL 36602 (251) 402–1364 ROGER J. SMITH, PE 24744 roger@smitheng.us SMITH JOB # 24–007	CUMMINGS ARCHITECTURE CORP
HANGER STRAP OR ANGLE STOCK TREADED ROD	One Houston Street Mobile, Alabama 36606 TEL 251.433.9600
Image: Strap Hanger Image: Hanger	No. 24744 PROFESSIONAL NO. 24744 BROFESSIONAL ALABAN NO. 24744 BROFESSIONAL ALABAN NO. 24744 BROFESSIONAL ALABAN NO. 24744 BROFESSIONAL ALABAN NO. 24744 BROFESSIONAL ALABAN ALABAN NO. 24744 BROFESSIONAL ALABAN
UCT 0 < 24" CLAMP RING LOAD RATED FASTENER, TYP UCT 0 < 24" CLAMP RING LOW PRESSURE DUCT, TYP DUCT 0 < 24"	ALABAMA STATE PORT AUTHORITY 4th FLOOR INTERIOR - PHASE 1 250 N. WATER STREET MOBILE, AL
	THIS DRAWING AND ITS REPRODUCTIONS ARE THE PROPERTY OF THE ARCHITECT AND MAY <i>NOT</i> BE REPRODUCED, PUBLISHED, OR USED IN ANY MANNER WITHOUT THE PERMISSION OF THE ARCHITECT.
	sheet name HVAC DETAILS PROJECT NO. 2024–01 Date june 6, 2024 Sheet no. MAA.O

ELECTRICAL SPECIFICATIONS

(ELECTRICAL S	JECIFICATIONS	
 CELECTRICAL: THE CONTRACTOR SHALL FURNISH ALL LABOR, MATERIALS AND EQUIPMENT NECESSARY FOR THE INSTALLATION OF A COMPLETE ELECTRICAL SYSTEM AS INDICATED WITHIN THESE DRAWINGS. ALL WORK SHALL BE INSTALLED IN STRICT ACCORDANCE WITH ALL APPLICABLE CODES AND ORDINANCES AND WITH MANUFACTURERS RECOMMENDATIONS THE CONTRACTOR SHALL CAREFULLY EXAMINE THE ARCHITECTURAL, STRUCTURAL ELECTRICAL AND MECHANICAL DRAWINGS PRORT OS USIMITING IN BUD THE CONTRACTOR WILL BE REQUIRED TO FURNISH, INSTALL AND CONNECT ALL THEM AS INDICATED ON THE DRAWINGS. THE ARCHITECTS THALL BE NOTFIED OF ANY CONFLICTS, OR INTERFERENCES THAT OCCUR BETWEEN INDIVIDUAL DRAWINGS. ALL MATERIALS AND EQUIPMENT SHALL BE INSTALLED IN A NEAT, FIRST CLASS, WORKANALIKE MANNER, TO THE APPROVAL OF THE ARCHITECTENGINEER AND GOVERNING AUTHORITIES. IN ADDITON TO THE WANTACTURERS STANDARD QURRANTEES. THEN CONTRACTOR SHALL QUARANTEE ALL MATERIALS. EQUIPMENT AND WORKANASHP AGAINST DEFECTS FOR ONE YEAR FROM THE DATE OF FIAL ACCEPTANCE. AND SHALL CORRECT ANY DEFECTS AT NO ADDITIONAL COST TO THE OWNER, ALL DRAWNER, TO THE APPROVAL OF THE ARCHITECTENGINEER AND GOVERNING AUTHORITIES. IN ADDITON TO THE WANTACTURERS STANDARD QUARANTEES, THE CONTRACTOR SHALL QUARANTEE ALL MATERIALS. EQUIPMENT AND WORKANASHP AGAINST DEFECTS FOR ONE YEAR FROM THE DATE OF FIAL ACCEPTANCE. AND SHALL CORRECT ANY DEFECTS AT NO ADDITIONAL CORRECT SHALL QUARANTEE ALL MATERIALS. EQUIPMENT AND WORKANASHP AGAINST DEFECTS FOR ONE YEAR FROM THE DATE OF FIAL ACCEPTANCE. AND SHALL CORRECT AND PLANCES WANDERVATE VALUE ON CODE REQUIREMENTS. WHICHEVER IS MORE STRINGENT ALLOWARD TO REMAIN SHALL WORK DEFENSION THAN THE DELEXANT CONTRACTOR SHALL VERTER AND PROVEL WILL BE CONTRACTOR. THE MINIMUM CIRCUT REQUIREMENTS SHALL BE BASED ON THE APPLANCE WAMEPLATE VALUE ON CODE REQUIREMENTS. WHICHEVER IS MORE STRINGENT ALLOWARD THE RANDES CAN PURCH AND AND PROVE MENTAND AD AND ATERNALS SHALL COMPLY WITH THE LATEST ADOPTED EDITION OF TH	 PECUFICATIONS 4.6.1. FINAL CONDUIT CONNECTIONS TO HEAT PUMPS, AIR HANDLERS, EXHAUST FANS, AND WATER HEATERS SHALL BE LIFK WHETHER INTERIOR OR EXTERIOR. 4.7. CONULT FITTINGS SHALL BE AS FOLLOWS: 4.1.1. ENT -42' USE STEEL SET SCREW WITH INSULATED THROATS FOR INTERIOR: USE COMPRESSION FITTINGS WITH INSULATED THROATS FOR EXTERIOR. >2' USE SET-SCREW STEEL WITH INSULATED THROATS. 4.2.2. RGS. THREADED GALVANIZED STEEL. 4.3.3. PVC - PVC APPROVED FOR THE USE. 4.4.4. FINC - ZINCPLATED STEEL OR CADMUNEPLATE MALLEABLE IRON SCREW TYPE WITH INSULATED THROAT. 4.5. LIFK- CANDUNAPLATED MALLEABLE IRON OR STEEL COMPRESSION TYPE WITH INSULATED THROAT. 4.6. ALL OUTLET BOXES SHALL BE 4X''''''''LIZ' DEEP MINIMUM. 4.9. ELECTRICAL CONTRACTOR SHALL WORK CLOSELY WITH THE MANDRY CONTRACTOR ON THE INSTALLATION OF ALL ELECTRICAL BOXES. CABINETS RINOS, ETC. IM MASONRY WALLS THE BOXES SHALL BE INSTALLED AT THE UNFORM HEIGHTS CALLED FOR ON THE DRAWING AND SECREFUNDS. PROVDE APPROPRIATE DEPTH MASONRY RINGS FOR ALL OUTLETS IN MASONRY WALLS TO INSURE PROPER CUTTING AND FITTING. INTERNAL MAY CABINET, OLIVET SOL, ETC. NOT INEETING AND FUEL FORMWER SHALL BE REAVED AND REINSTALLED AT NO ADDITIONAL COST TO THE GOWER AND FUEL OF THE SHALL BE REAVED AND REINSTALLED AT NO ADDITIONAL COST TO THE CONTRACTOR ON UNDER HEAD APPROPRIATE DEPTH MASONRY RINGS FOR ALL OUTLETS IN MASONRY WALLS TO INSURE PROPER CUTTING AND FITTING IN THE FACE OF THE CABINETS INDUCES IN THE ADOVER REQUIREMENT SHALL BE REAVED AND REINSTALLED AT NO ADDITIONAL COST TO THE CONTREX. 5.1. PROVIDE AN INSULATED EDUCALE DEUR NUEL TO EXCILTES INTO ADDITIONS PEODONE CONTRES SANDING: 5.2. ALL CABLES SHALL BE COPPER ALL BOLTED CONNECTIONS SHALL BE RONZE. 5.3. WHERE RAVILABLE, BOUT TO BOULD BUILDING STRUCTURAL STEEL, BUILDING FOR THE FOLLOWING SYSTEMS AS FOLLOWS: 6.1. PROVIDAE IN SYSTEMES COUPLINGS AND BOX COVERS ABOVE	A AMPS AC ABOVE COUNTER AF AMP FRAME AFF ABOVE FINISHED FLOOR AFG ABOVE FINISHED GRADE AHU AIR HANDLING UNIT AL ALUMINUM ARCH ARCHITECT OR ARCHITECTURAL AT AMP TRIP ATS AUTOMATIC TRANSFER SWITCH AT AMP TRIP ATS AUTOMATIC TRANSFER SWITCH ATU AIR TERMINAL UNIT AWG AMERICAN WIRE GAUGE BAS BULDING AUTOMATION SYSTEM BFG BELOW FINISHED GRADE BJ BONDING JUMPER BKR CIRCUIT BREAKER CC CONDUIT C/B CRUTI BREAKER CL CURENT LIMITING C/L CENTERLINE CLG CELUIT CT CURRENT TRANSFORMER CU COPPER DDC DIRECT DIGITAL CONTROL DEMO DEMOLISH EC ELECTRICAL CONTRACTOR EGC EQUIPMENT GROUNDING CONDUCTOR ELECTRICAL
4.3. CONDUIT ROUTINGS AND DEVICE / EQUIPMENT LOCATIONS SHOWN ARE DIAGRAMMATIC ONLY,		IGISOLATED GROUNDIMCINTERMEDIATE METAL CONDUITJBJUNCTION BOXkKILOkAICKILO-AMPERE INTERRUPTING CAPABILITYkCMILTHOUSAND CIRCULAR MILSLCPLIGHTING CONTROL PANELLTGLIGHTINGLFMCLIQUID TIGHT FLEXIBLE METAL CONDUITLVLOW VOLTAGEMAXMAXIMUMMCAMINIMUM CIRCUIT AMPACITYMCCMOTOR CONTROL CENTER
MISCELLANEOUS EQUIPMENT:	OTHER: CIRCUIT RUN CONCEALED ABOVE CEILING OR IN WALL	MCE MAIN COMMUNICATIONS EQUIPMENT ROOM <u>GENERAL ELECTRICAL DEVICES:</u> SINGLE POLE LIGHTING SWITCH. MOUNT 48" TO TOP OF BOX AFF
 FIRE ALARM SYSTEM VISUAL ONLY APPLIANCE. MOUNT 80" AFF TO BOTTOM OF LENS OR 6" FROM THE CEILING, WHICHEVER IS LOWER. ALL STROBES SHALL BE SYNCHRONIZED. FIRE ALARM SYSTEM ADDRESSABLE PHOTOELECTRIC SMOKE DETECTOR. CEILING MOUNT. LIGHTING FIXTURES: 	 CIRCUIT RUN CONCEALED ABOVE CEILING OR IN WALL. CIRCUIT RUN CONCEALED IN OR BELOW FLOOR SLAB OR UNDERGROUND. HOMERUN TO PANELBOARD. ANY CIRCUIT WITHOUT FURTHER DESIGNATION SHALL BE 2#12,#12G,3/4"C. TICK MARKS INDICATE # OF CONDUCTORS (EGC NOT SHOWN). MINIMUM SIZE ON 120V HOMERUNS GREATER THAN 50 FEET SHALL BE #10 AWG. MINIMUM SIZE ON 120V HOMERUNS GREATER THAN 100 FEET SHALL BE #8 AWG. MINIMUM SIZE ON 120V HOMERUNS GREATER THAN 160 FEET SHALL BE #6 AWG. MINIMUM SIZE ON 277V HOMERUNS GREATER THAN 100 FEET SHALL BE #10 AWG. INCREASE CONDUIT SIZE AS REQUIRED PER NEC. UNDERLINED TEXT INDICATES CIRCUIT DESIGNATION. LOW VOLTAGE CABLE AS SPECIFIED BY THE MANUFACTURER. OCCUPANCY SENSORS: WALL MOUNTED LINE VOLTAGE DUAL TECHNOLOGY SWITCH WITH SINGLE RELAY. MOUNT 48" AFF UNLESS NOTED OTHERWISE. SWITCH SHALL BE PROGRAMMED TO BE MANUAL ON. CEILING MOUNTED LOW VOLTAGE 360° DUAL TECHNOLOGY (PASSIVE INFRARED & ULTRASONIC) OCCUPANCY SENSOR. 	 SINGLE POLE LIGHTING SWITCH. MOUNT 48 TO TOP OF BOX AFF INDICATES AS FOLLOWS: M - 30 AMP TWO POLE MOTOR RATED SWITCH MOUNTED AT TH DUPLEX RECEPTACLE NEMA 5-20R. MOUNT 18" AFF UNLESS NOTH REQUIREMENTS WITH ARCHITECTURAL DRAWINGS PRIOR TO RO FOLLOWS: G - GROUND FAULT CIRCUIT INTERRUPTER TYPE. 84" - MOUNTING HEIGHT OF DEVICE AFF. 21 - # INDICATES PANELBOARD CKT NUMBER ROUGH-IN FOR COMMUNICATIONS OUTLET (CO). MOUNT ON WAL SUBSCRIPTED OTHERWISE. INCLUDE 1" EMT FROM ROUGH-IN BC CEILING. TERMINATE WITH BUSHING (ON BOTH ENDS) AND PROV DISTRIBUTION & POWER EQUIPMENT: PANELBOARD. MOUNT AS INDICATED. SEE PANELBOARD SCH
SEE LIGHTING FIXTURE SCHEDULE FOR SYMBOLS AND DESCRIPTIONS. THE FIXTURE MARK IN AN ENCLOSED SPACE WITH SIMILAR FIXTURES WILL APPLY TO ALL FIXTURES IN THE SPACE.	PP DIMMING POWER PACK. PROVIDE WITH NEMA 1 ENCLOSURE.	

SPACE WITH SIMILAR FIXTURES WILL APPLY TO ALL FIXTURES IN THE SPACE.

ABBREVIATIONS

[PP] DIMMING POWER PACK. PROVIDE WITH NEMA 1 ENCLOSURE.

- F.
- UMBER
- _ET (CO). MOUNT ON WALL AT 18" AFF UNLESS EMT FROM ROUGH-IN BOX STUBBED ABOVE N BOTH ENDS) AND PROVIDE PULL STRING.


D. SEE PANELBOARD SCHEDULES.


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S	CONSULTING
МСМ	THOUSAND CIRCULAR MILS CHRISTINA MARIE P.E. PE 50660 - ECA 50377
MEM	MANHOLE C: (251) 455-9189
MIN	MANINEL JaguarEngineers@Yahoo.Com
MISC	MISCELLANEOUS
MLO	MAIN LUGS ONLY
MNT	MOUNTING HEIGHT
MTG	MOUNTING
MTS	MANUAL TRANSFER SWITCH
MV	
N1 N3R	NEMA 1 NEMA 3R
NJR N/A	NOT APPLICABLE
NA	NOT APPLICABLE
NEC	NATIONAL ELECTRICAL CODE
NESC	NATIONAL ELECTRICAL SAFETY CODE
NEU	NEUTRAL
OCPD	OVERCURRENT PROTECTION DEVICE
OFOI	OWNER FURNISHED OWNER INSTALLED
OFCI	OWNER FURNISHED CONTRACTOR INSTALLED
OH	
OHP OHS	OVERHEAD PRIMARY OVERHEAD SECONDARY
PBD	PANELBOARD
PED	PANELBOARD POWER FACTOR
PNL	PANELBOARD
PT	POTENTIAL TRANSFORMER
PWR	POWER
REC	RECEPTACLE
REQD	REQUIRED
RM	ROOM
RGS	RIGID GALVANIZED STEEL CONDUIT
RNC RVSS	RIGID NON-METALLIC CONDUIT REDUCED VOLTAGE SOLID STATE
SA	SURGE ARRESTER
SCA	SHORT CIRCUIT AMPS
SF	SUPPLY FAN
SPEC	SPECIFICATION
SWBD	SWITCHBOARD
SWGR	SWITCHGEAR
TBB	TELECOMMUNICATIONS BONDING BACKBONE
TR	TELECOMMUNICATIONS ROOM
TGB	TELECOMMUNICATIONS GROUNDING BUSBAR
TMGB	TELECOMMUNICATIONS MAIN GROUNDING BUSBAR
TVSS TYP	TRANSIENT VOLTAGE SURGE SUPPRESSION TYPICAL
UFR	UNDERFLOOR RACEWAY
UG	UNDERGROUND
UGE	UNDERGROUND ELECTRIC
UGP	UNDERGROUND PRIMARY
UGS	UNDERGROUND SECONDARY
UL	UNDERWRITERS' LABORATORIES
UNO	UNLESS NOTED OTHERWISE
UPS	UNINTERRUPTIBLE POWER SUPPLY
V	
VA VAR	VOLT-AMPERES VOLT-AMPERES REACTIVE
VAR VAV	VOLT-AMPERES REACTIVE VARIABLE AIR VOLUME UNIT
W	WATTS
WAO	WORK AREA OUTLET
WP	WEATHERPROOF
WSR	WITHSTAND RATING
XFMR	TRANSFORMER
XP	EXPLOSION PROOF
φ	PHASE
72°	DEGREES
Δ	
Ω	OHMS

T 48" TO TOP OF BOX AFF UNLESS NOTED OTHERWISE. SUBSCRIPT

SWITCH MOUNTED AT THE EQUIPMENT. PROVIDE PHENOLIC LABEL.

UNT 18" AFF UNLESS NOTED OTHERWISE. VERIFY DUPLEX MOUNTING DRAWINGS PRIOR TO ROUGH-IN. SUBSCRIPT INDICATES AS

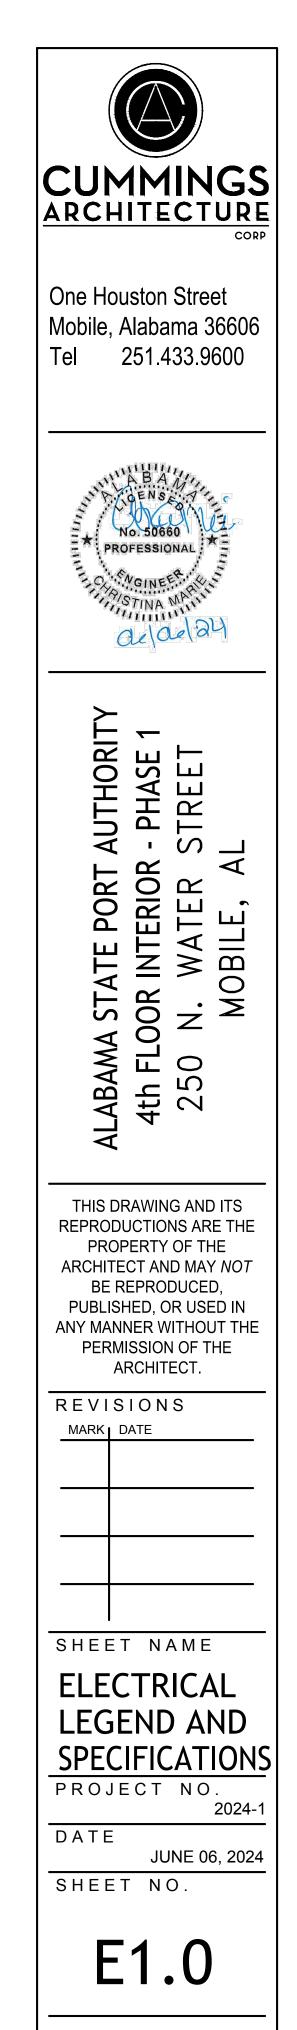

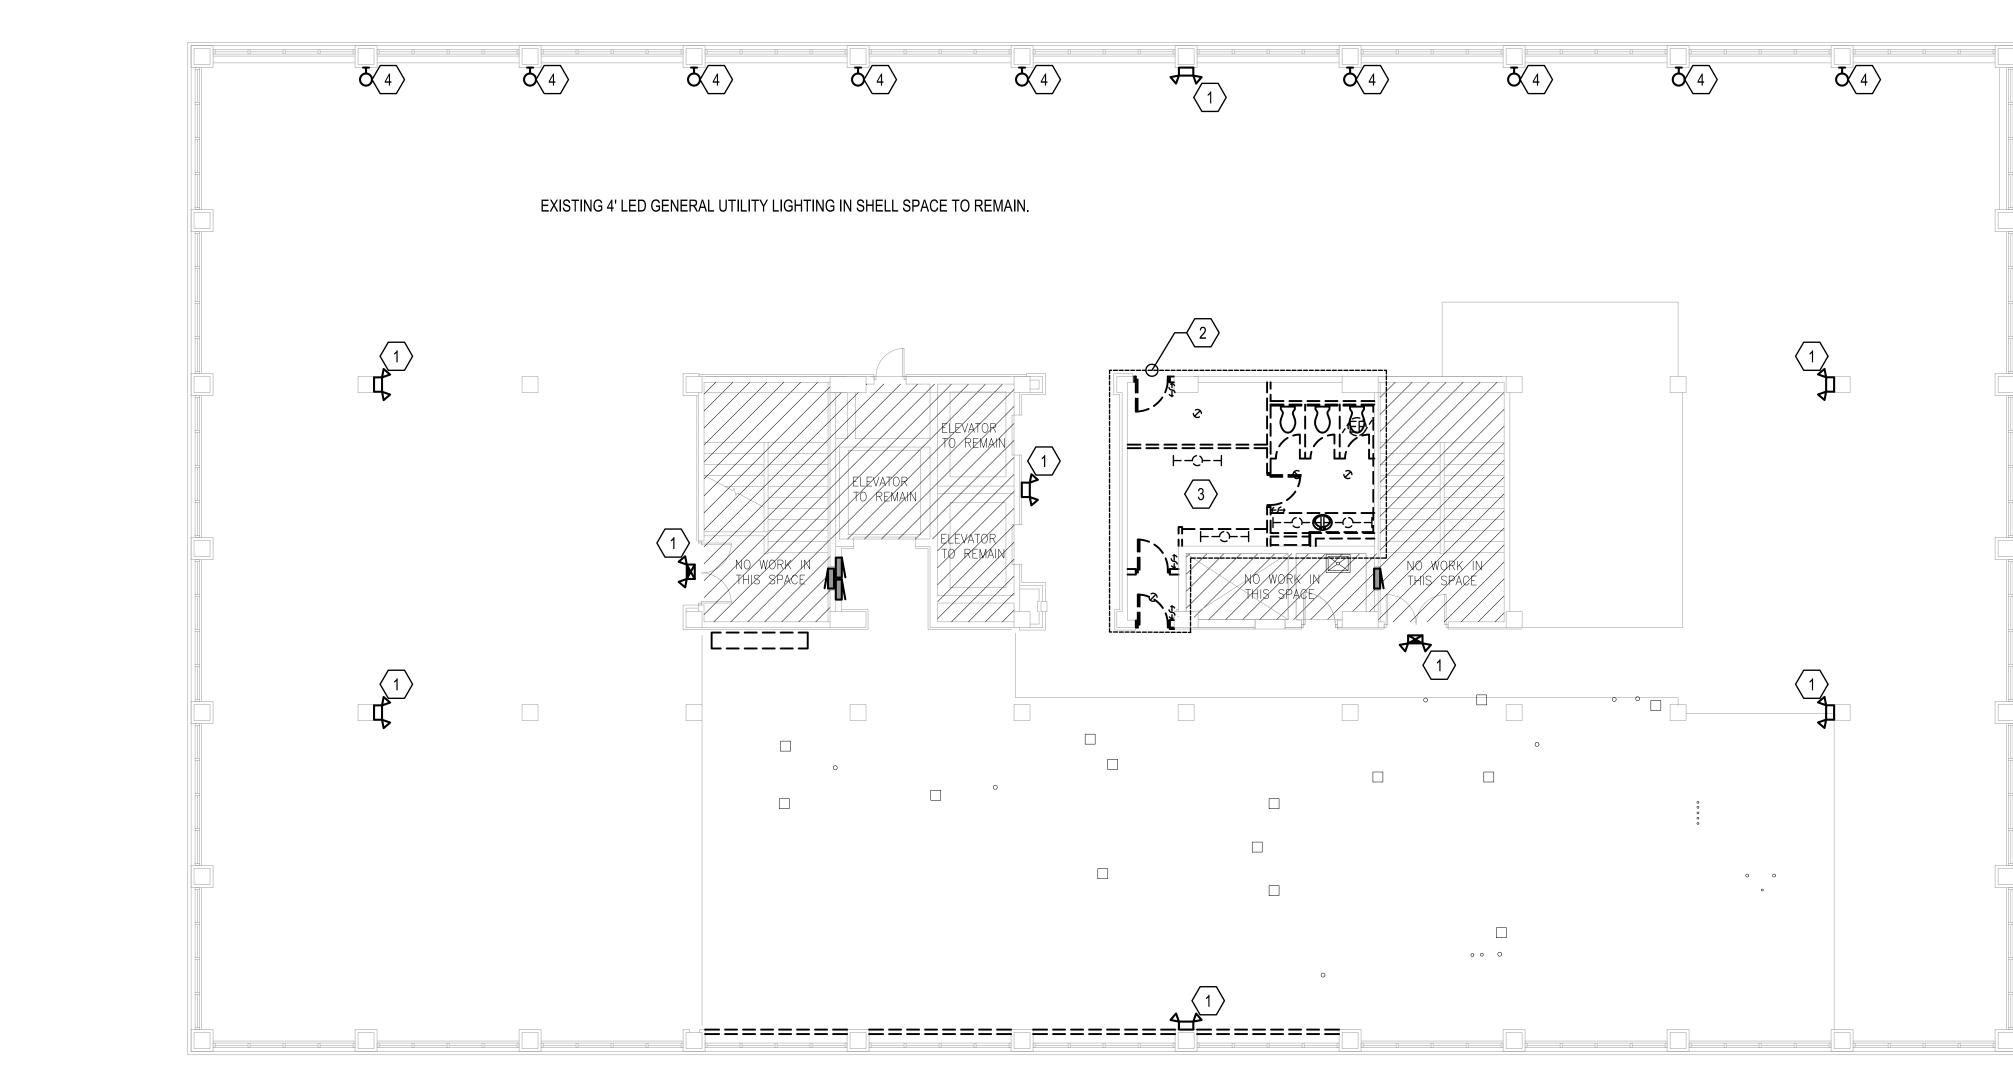

EXISTING WORK GENERAL NOTES

- 1. THE CONTRACTOR SHALL VISIT THE SITE TO FAMILIARIZE THEMSELVES WITH THE SCOPE OF WORK PRIOR TO SUBMITTING A BID. IT IS THE RESPONSIBILITY OF THE CONTRACTOR TO UNDERSTAND AND PROVIDE AND INSTALL ALL NECESSARY COMPONENTS TO FULFILL THE INTENT OF THE CONTRACT DOCUMENTS (INCLUDING BUT NOT LIMITED TO SUPPORTS, BRACING, PATCHING, ETC.).
- 2. THE ELECTRICAL CONTRACTOR SHALL VERIFY ALL WALLS TO BE DEMOLISHED AND TO REMAIN WITH ARCHITECTURAL PLANS PRIOR TO BEGINNING ANY WORK.

EXISTING WORK SHEET NOTES


 $\langle 1 \rangle$ EXISTING EMERGENCY EGRESS FIXTURE TO REMAIN. THE CONTRACTOR SHALL ENSURE THE OPERABILITY OF THE FIXTURE AND REPLACE TO MATCH EXISTING IF NOT OPERABLE. FIXTURES LOCATED ON WALLS BEING REFINISHED SHALL BE REMOVED AND PROTECTED DURING THE DEMOLITION PHASE AND REINSTALLED DURING THE NEW WORK PHASE.

 $\langle 2 \rangle$ THIS RESTROOM AND ADJACENT STORAGE SPACE IS TO BE COMPLETELY RENOVATED AS A PART OF THIS PROJECT. THE ELECTRICAL CONTRACTOR SHALL COMPLETELY REMOVE ALL LIGHTING FIXTURES AND WIRING DEVICES. THE ELECTRICAL CONTRACTOR SHALL REMOVE ALL ASSOCIATED CONDUIT AND CONDUCTORS BACK TO NEAREST JUNCTION BOX TO REMAIN. PROVIDE NEW FIXTURES AND WIRING DEVICES PER NEW WORK PLANS.

 $\langle 3 \rangle$ SECURE AND PREPARE EXISTING LIGHTING CIRCUIT FOR CONNECTION TO NEW FIXTURES AND CONTROLS DURING THE NEW WORK PHASE.

 $\langle 4 \rangle$ EXISTING WALL MOUNTED FIXTURE TO BE COMPLETELY REMOVED. REMOVE EXISTING CONDUCTORS BACK TO NEAREST JUNCTION BOX TO REMAIN. PATCH WALL OR PROVIDE BLANK PLATE FOR EXISTING BOX AS DIRECTED BY THE ARCHITECT.




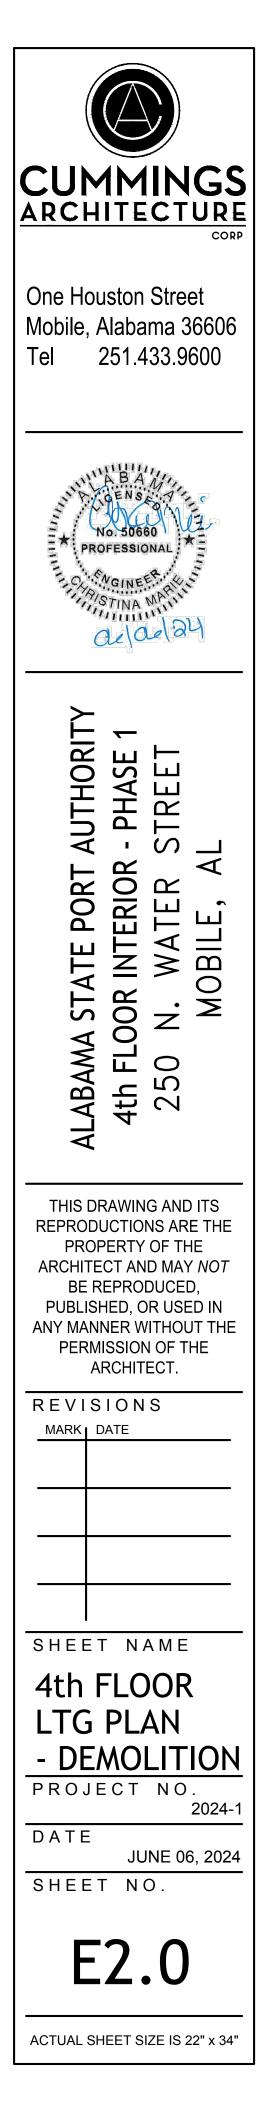

UCONSULTING CHRISTINA MARIE P.E. PE 50660 - ECA 50377 C: (251) 455-9189 JaguarEngineers@Yahoo.Com

ING	LIGH	TING	PLAN	

SCALE: 1/8"=1'-0"

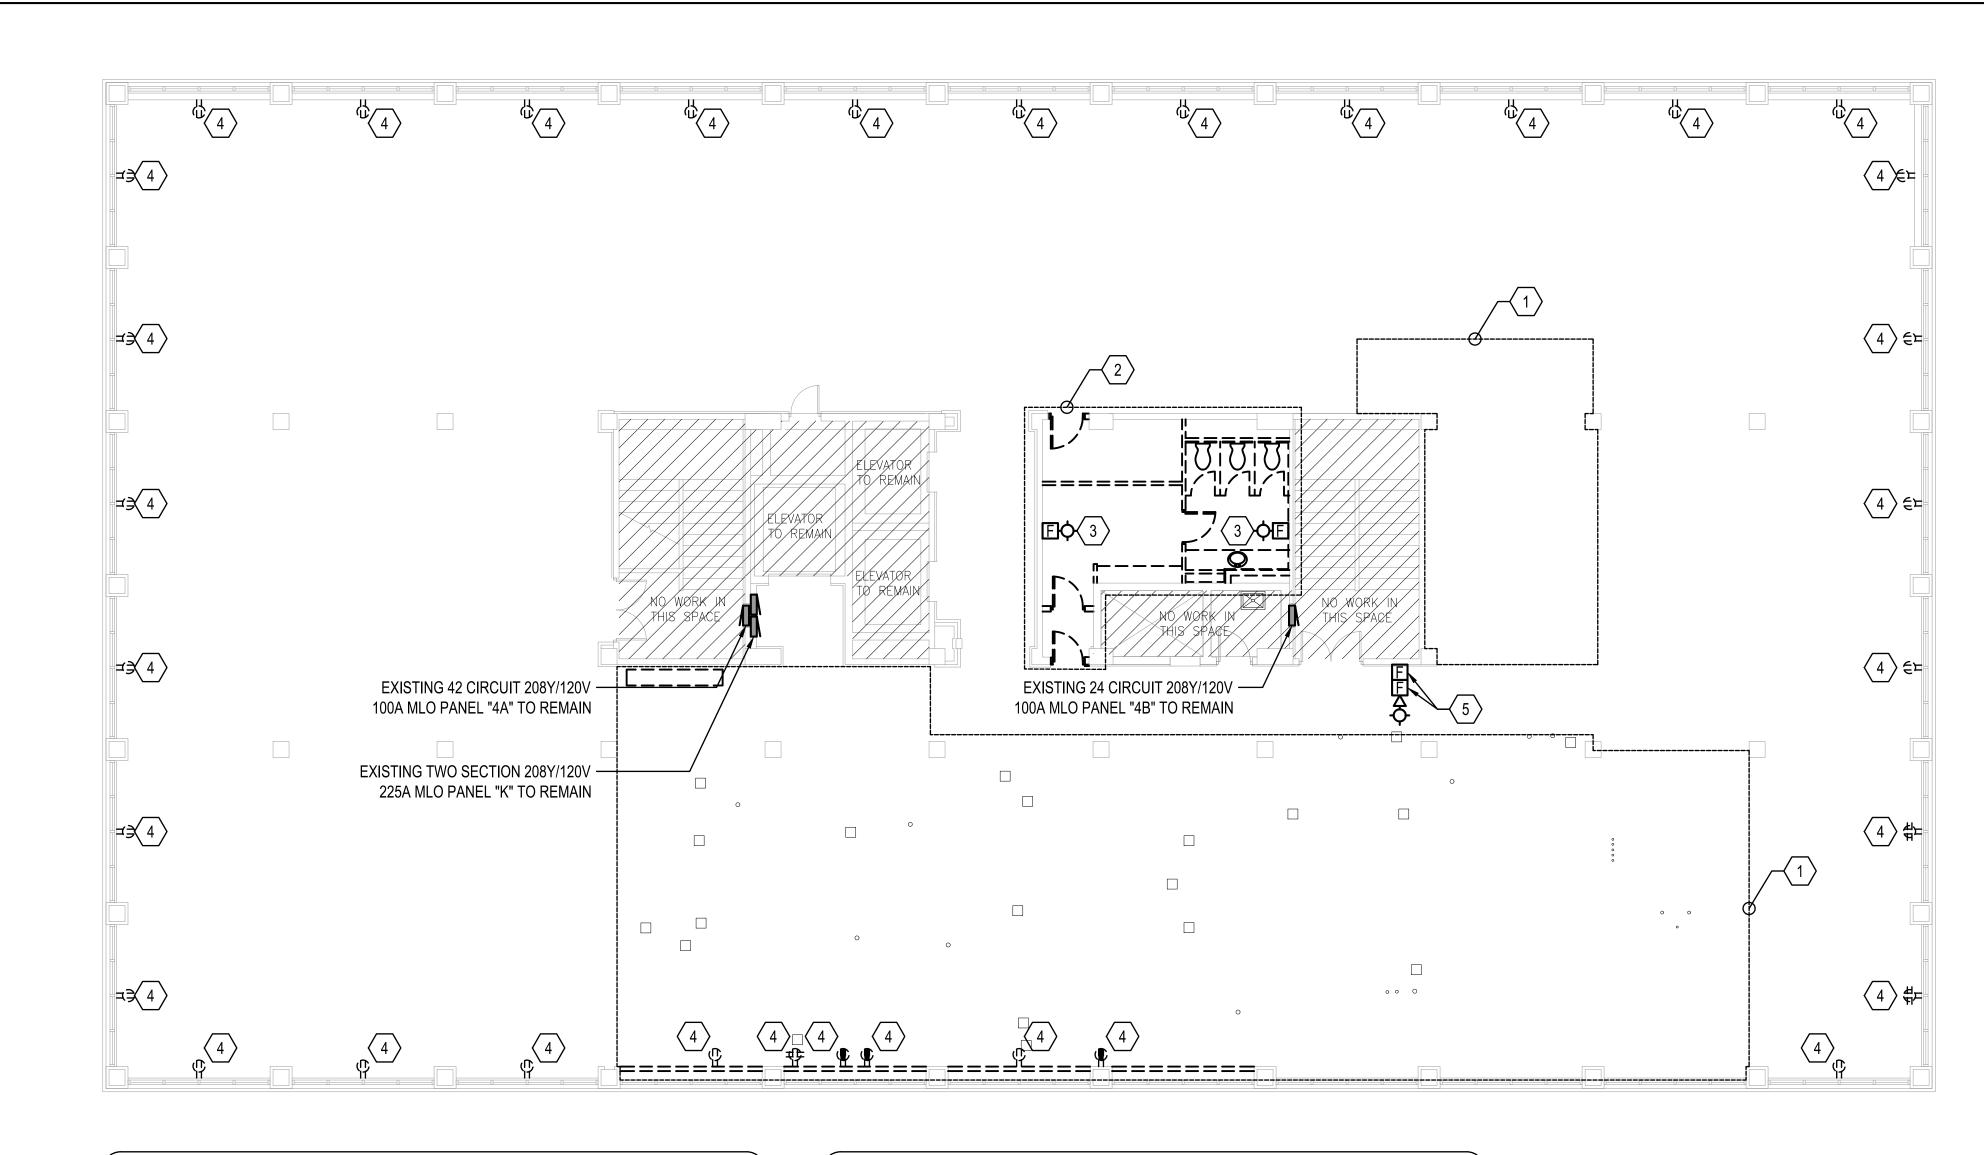

EXISTING WORK GENERAL NOTES


- 1. THE CONTRACTOR SHALL VISIT THE SITE TO FAMILIARIZE THEMSELVES WITH THE SCOPE OF WORK PRIOR TO SUBMITTING A BID. IT IS THE RESPONSIBILITY OF THE CONTRACTOR TO UNDERSTAND AND PROVIDE AND INSTALL ALL NECESSARY COMPONENTS TO FULFILL THE INTENT OF THE CONTRACT DOCUMENTS (INCLUDING BUT NOT LIMITED TO SUPPORTS, BRACING, PATCHING, ETC.).
- 2. THE ELECTRICAL CONTRACTOR SHALL VERIFY ALL WALLS TO BE DEMOLISHED AND TO REMAIN WITH ARCHITECTURAL PLANS PRIOR TO BEGINNING ANY WORK.

EXISTING WORK SHEET NOTES

 $\langle 1 \rangle$ THE SLAB IN THIS AREA IS TO BE PREPPED AND RE-POURED AS A PART OF THIS PROJECT BY OTHERS. THERE ARE MULTIPLE LOCATION WHERE EXISTING CONDUIT IS STUBBED UP THROUGH THE EXISTING SLAB. THE ELECTRICAL CONTRACTOR SHALL INVESTIGATE ALL STUB UP CONDUIT LOCATIONS AND PREPARE THEM FOR THE NEW SLAB:

- 1. THE ELECTRICAL CONTRACTOR SHALL REMOVE ANY EXISTING CONDUCTORS FROM THE EXISTING CONDUITS.
- 2. THE ELECTRICAL CONTRACTOR SHALL COORDINATE WITH THE GENERAL CONTRACTOR TO ENSURE EXISTING STUB UPS ARE CUT AND CAPPED AS REQUIRED FOR THE NEW SLAB.
- $\langle 2 \rangle$ THIS RESTROOM IS TO BE COMPLETELY RENOVATED AS A PART OF THIS PROJECT. THE ELECTRICAL CONTRACTOR SHALL COMPLETELY REMOVE ALL LIGHTING FIXTURES AND WIRING DEVICES. THE ELECTRICAL CONTRACTOR SHALL REMOVE ALL ASSOCIATED CONDUIT AND CONDUCTORS BACK TO NEAREST JUNCTION BOX TO REMAIN. PROVIDE NEW FIXTURES AND WIRING DEVICES PER NEW WORK PLANS.
- $\langle 3 \rangle$ EXISTING FIRE ALARM NOTIFICATION DEVICE TO BE REMOVED DURING THE DEMOLITION PHASE AND REINSTALLED PER NEW WORK PHASE.
- $\langle 4 \rangle$ EXISTING RECEPTACLE ON PERIMETER WALL TO BE REMOVED AND REPLACED NEW PER NEW WORK PLANS.
- $\left< 5 \right>$ EXISTING FIRE ALARM DEVICE TO BE REMAIN.




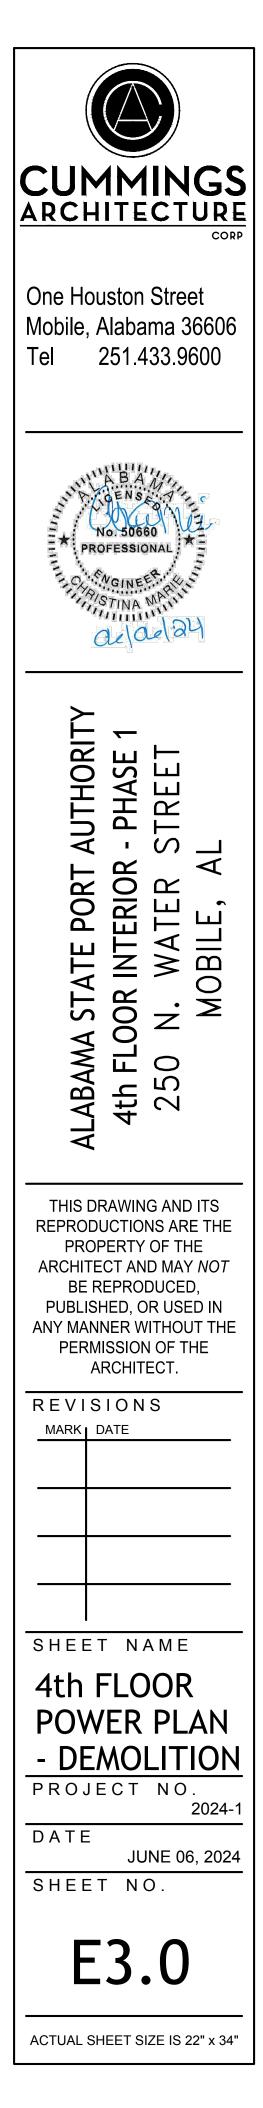


C O N S U L T I N G CHRISTINA MARIE P.E. PE 50660 - ECA 50377 C: (251) 455-9189 JaguarEngineers@Yahoo.Com

ING	POWER	PLAN
01		4.01


SCALE: 1/8"=1'-0"

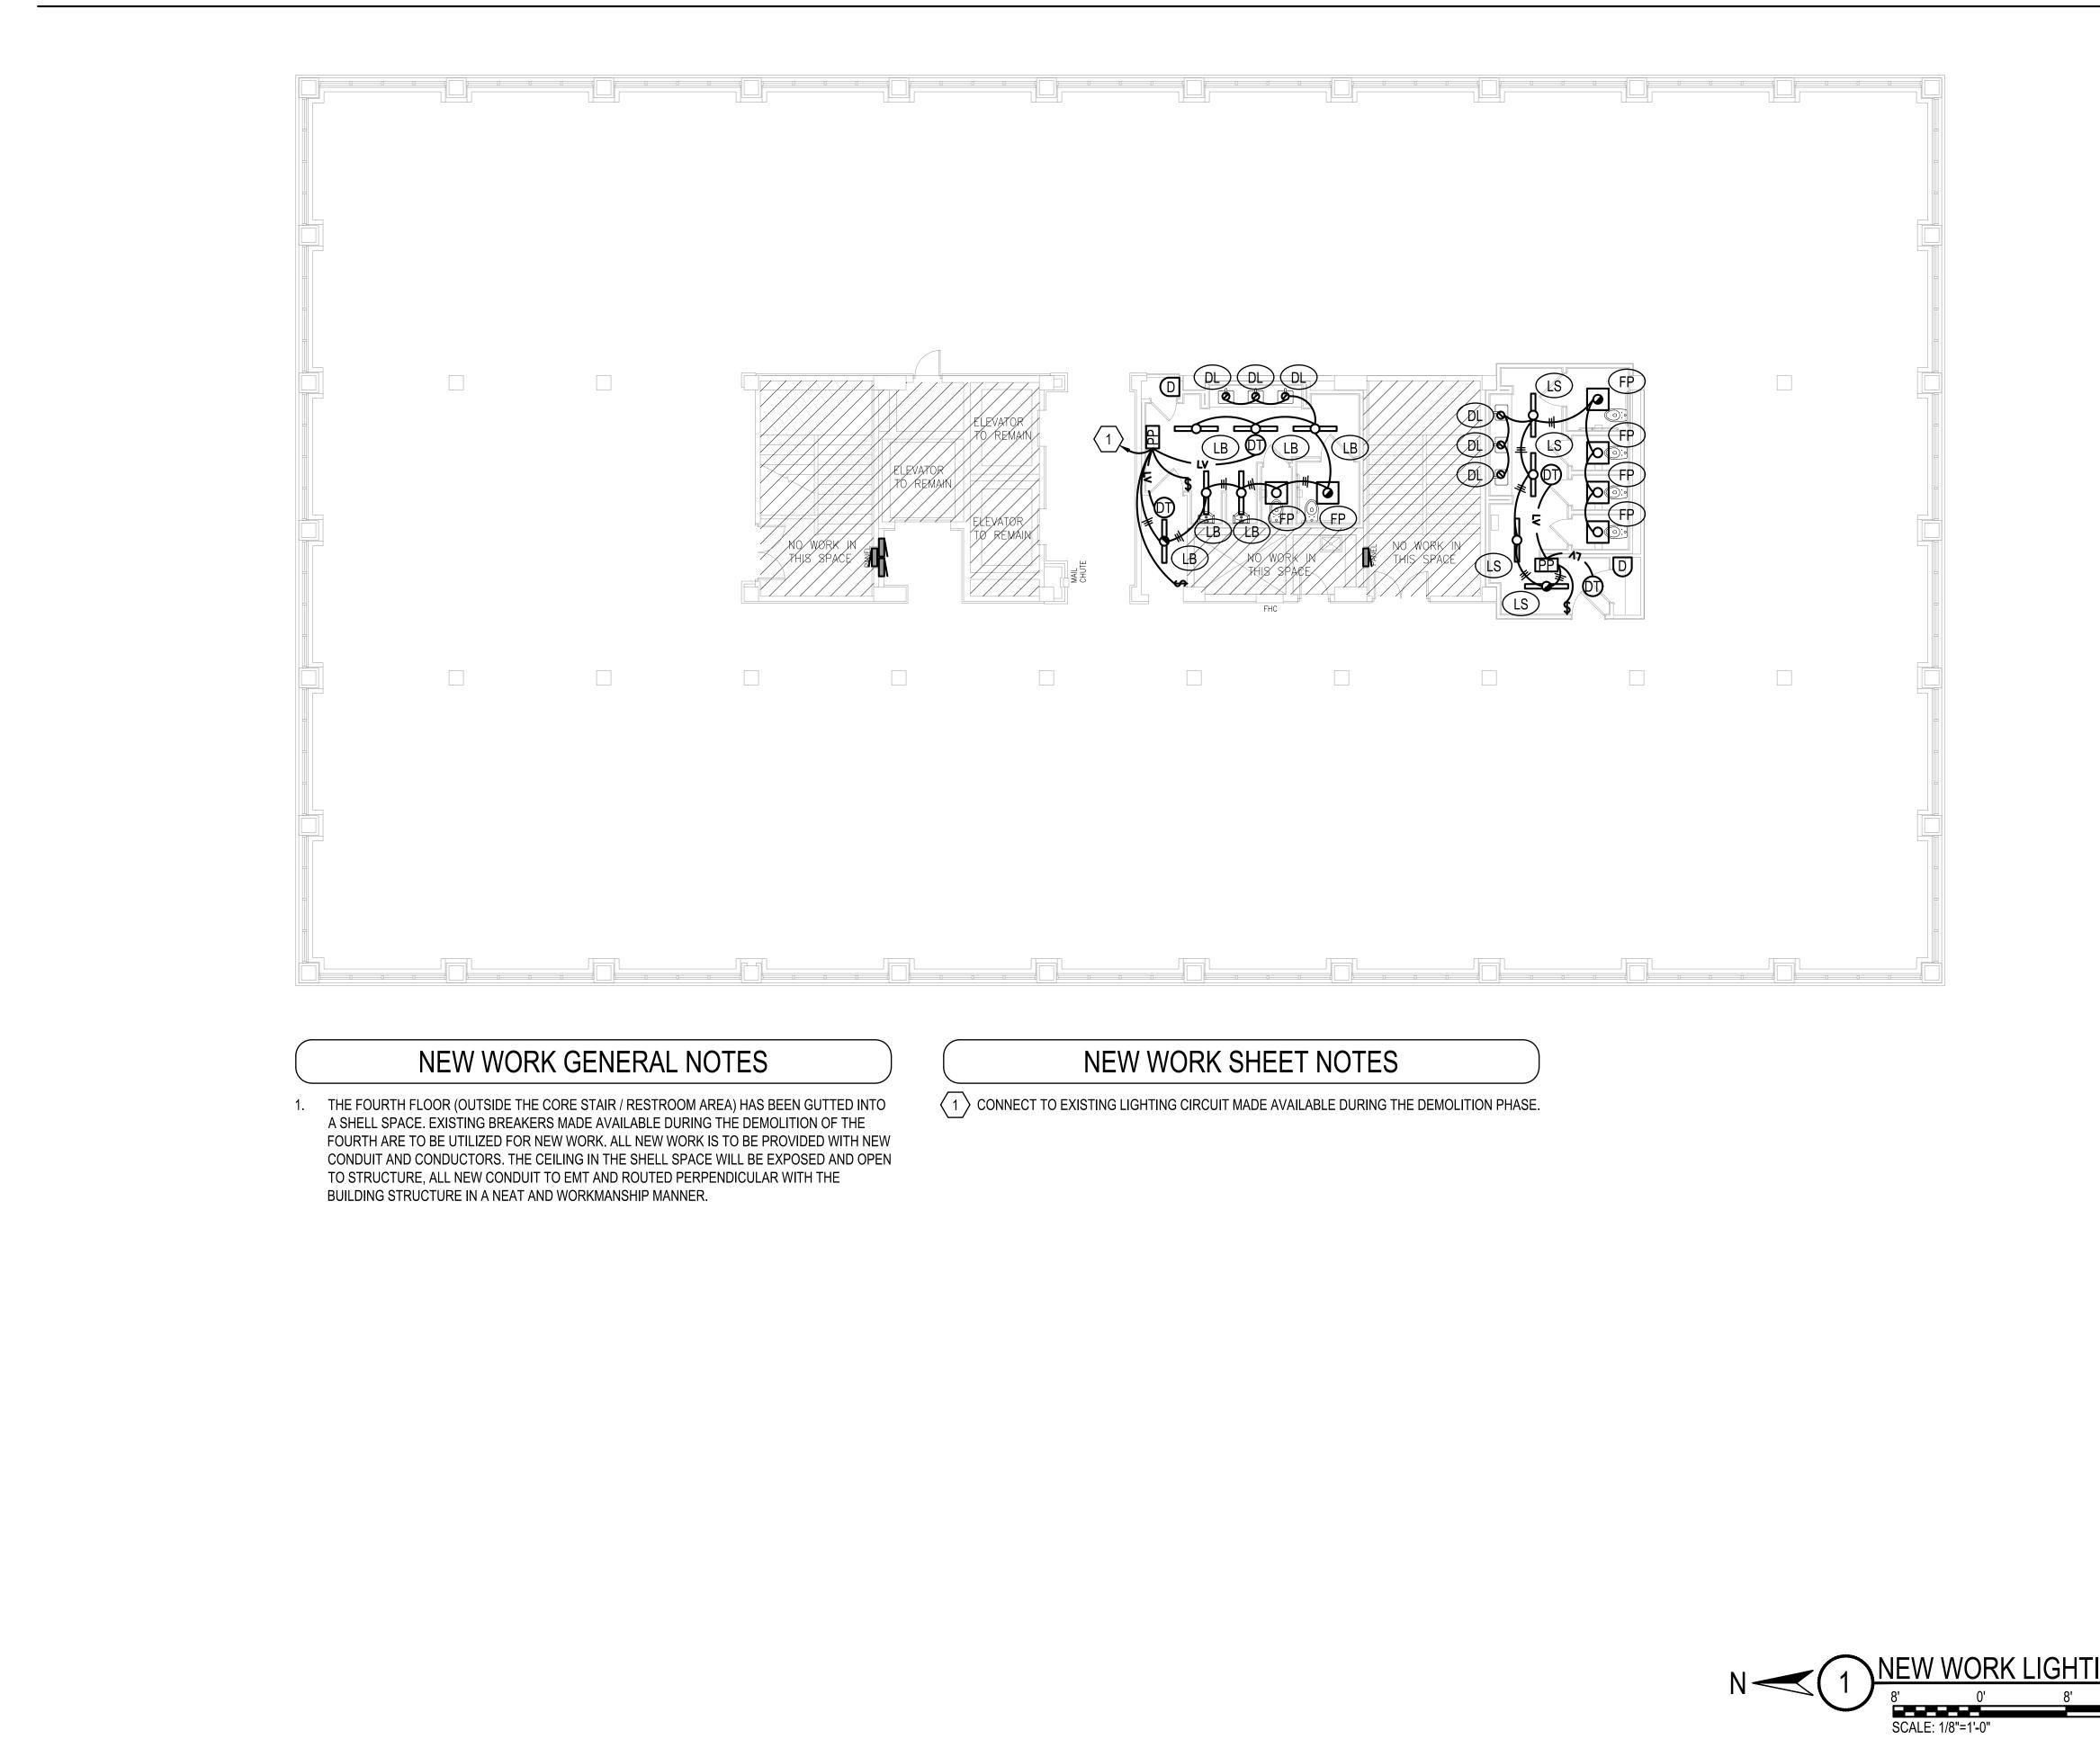

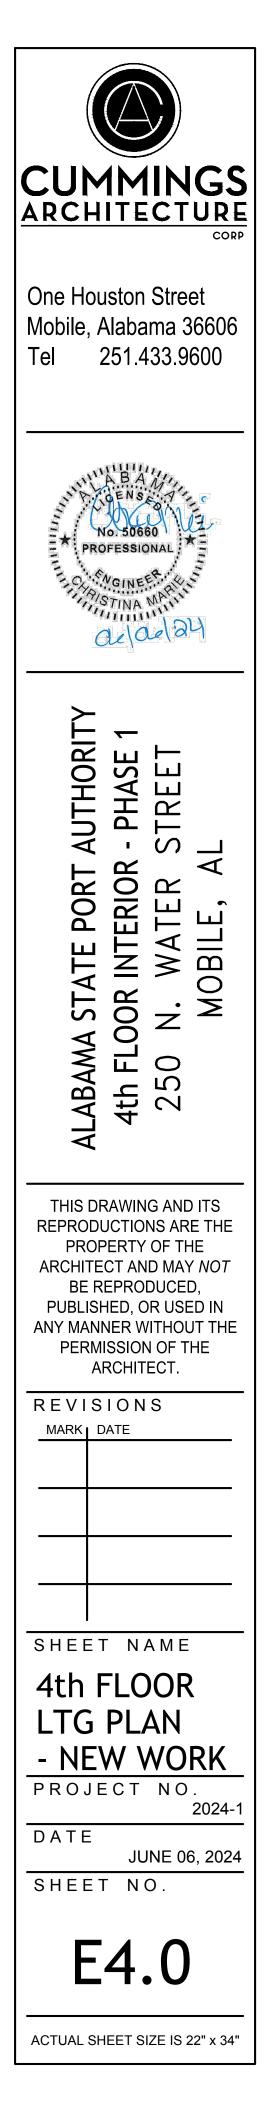

CONSULTING CHRISTINA MARIE P.E. PE 50660 - ECA 50377 C: (251) 455-9189 JaguarEngineers@Yahoo.Com

WORK LIGHTING PLAN	

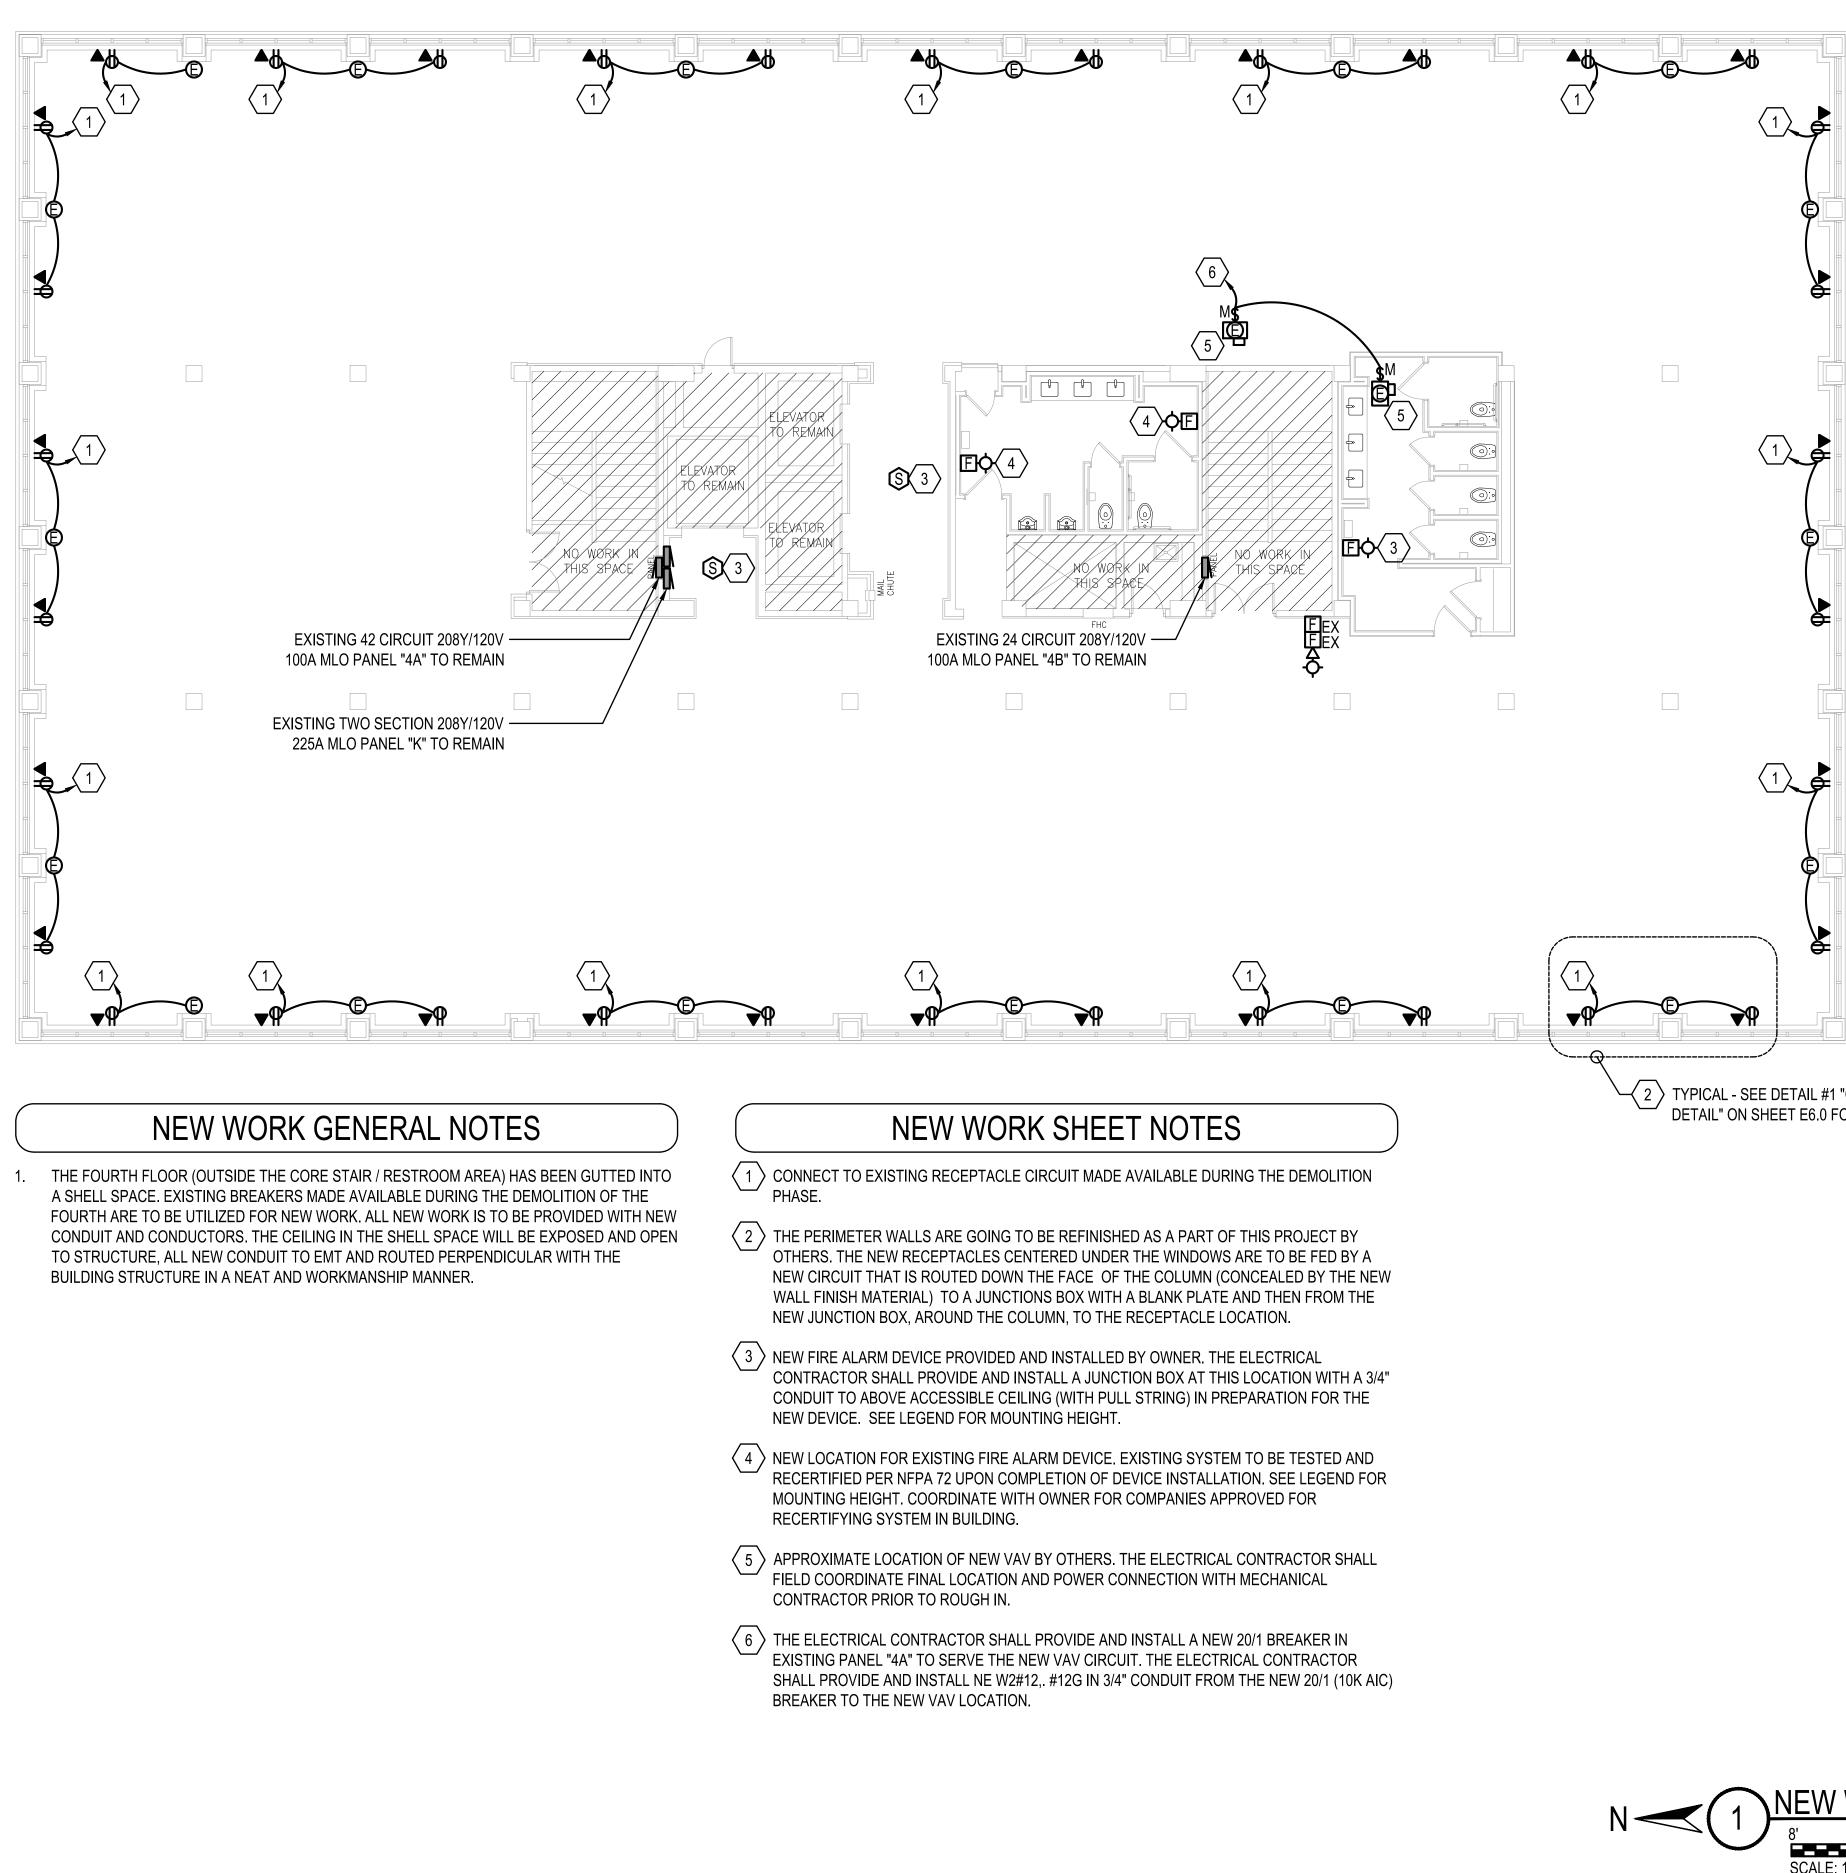

	CONSULTING CHRISTINA MARIE P.E. PE 50660 - ECA 50377 C: (251) 455-9189 JaguarEngineers@Yahoo.Com	CUMMINGS ARCHITECTURE CORP
		One Houston Street Mobile, Alabama 36606 Tel 251.433.9600
		A B A B A No. 50660 PROFESSIONAL STINA STINA A A A A A A A A A A A A A A A A A A
		ALABAMA STATE PORT AUTHORITY 4th Floor Interior - Phase 1 250 N. WATER STREET MOBILE, AL
"Column conduit routing For More Information.		THIS DRAWING AND ITS REPRODUCTIONS ARE THE PROPERTY OF THE ARCHITECT AND MAY <i>NOT</i> BE REPRODUCED, PUBLISHED, OR USED IN ANY MANNER WITHOUT THE PERMISSION OF THE ARCHITECT.
WORK POWER PLAN		SHEET NAME 4th FLOOR POWER PLAN - NEW WORK PROJECT NO. 2024-1 DATE JUNE 06, 2024 SHEET NO.
0' 8' 16' : 1/8"=1'-0"		E5.0
		ACTUAL SHEET SIZE IS 22" x 34"

1ARK			LIC	GHTING	G FIXTURE	SCHEDULE	1" CONDUIT (WITH PULL STRING ROUTED IN THE
	ANUFACTURER AND CATALOG NUMBER	LAMPS TYPE	TOTAL WATTS	VOLTAGE	MOUNTING	NOTES	COLUMN TO ABOVE ACCESSIBLE CEILING. TERMINATE WITH BUSHING.
DL	SHAPER LIGHTING 340-4C-20-D010	LED	22.6	MVOLT	SEMI RECESSED	4" SEMI RECESSED DIMMABLE LED DECORATIVE FIXTURE GLASS TRIM OPTION TO BE SELECTED BY ARCHITECT PRIOR TO ORDER PROVIDE INTEGRAL BATTERY BACK UP AS INDICATED	1" CONDUIT WITH PULL STRING ROUTED FROM THE NEW COLUMN JUNCTION BOX TO THE NEW DATA JUNCTION BOX. ROUTING SHOWN IS DIAGRAMMATICAL FOR CLARITY. ALL CONDUIT IS
S	STARTEK LIGHTING AMERICA SLIMD-4-750-WD-35K-80-PX-XX-U-1C	LED	25	MVOLT	SUSPENDED	2" WIDE 4' LONG SLIM BEAM DIMMABLE LED FIXTURE COLOR & MOUNTING TO BE COORDINATED WITH ARCHITECT PRIOR TO ORDER PROVIDE INTEGRAL BATTERY BACK UP AS INDICATED	TO BE CONCEALED IN THE NEW WALL.
В	STARTEK LIGHTING AMERICA SBEAMD-4-750-WD-35K-80-PX-SM-U-1C	LED	25	MVOLT	SURFACE	2" WIDE 4' LONG SLIM BEAM DIMMABLE SURFACE MOUNTED LED FIXTURE PROVIDE ALL MOUNTING HARDWARE FOR A SECURE INSTALLATION ON A GRID CEILING PROVIDE INTEGRAL BATTERY BACK UP AS INDICATED	
5	LITHONIA LIGHTING PX-2X2-AL07-80CRI-SWW7-SWL-MVOLT-	LED	19.3	MVOLT	RECESSED	2X2 DIMMABLE LED FLAT PANEL PROVIDE INTEGRAL BATTERY BACK UP AS INDICATED	 (2) NEW 4" x 4" JUNCTION BOXES WITH BLANK COVER PLATES/ ONE FOR POWER ONE FOR FUTURE DATA NEEDS
Ľ	LITHONIA LIGHTING WL2-08L-GZ1-LP835-PAF		7.5			2' LED DIMMABLE UTILITY FIXTURE TO BE MOUNTED ON WALL ABOVE DOOR IN CLOSET SPACE	COLUMN CONDUIT ROUTING DETAI
Ī	IX TURES WITH HALF FILLED IN CENTER A LL FIXTURES ARE TO BE DIMMABLE. LL FIXTURES TO BE APPROVED BY ARCH				PROVIDED WITH AN	EMERGENCY BALLAST, 1100 LUMENS OR THE MAXIMUM AVAILABLE FOR THE FIXTURE.	1 NEW WORK POWER PLAN FOR MOR
							RECEPTACLE WITH COVERPLATE REMOVED
							2 WIRING DEVICE LABEL DET
					_ ^	COMcheck Software Version COMcheckWeb	
						Interior Lighting Compliance Certificate	\bigcap
					Project I Project Title Project Type	nformation e: 2015 IECC : ASPA 4th Floor Shell Renovation - Phase I	POWER PACK
					Energy Cod Project Title Project Type Constructio 250 N. Wa Mobile, Ala	nformation e: 2015 IECC : ASPA 4th Floor Shell Renovation - Phase I : Alteration n Site: Owner/Agent: Designer/Contractor: ter Street abama 36602 Interior Lighting Power	POWER PACK PACK UV C BY J MET
					Energy Cod Project Title Project Type Constructio 250 N. Wa Mobile, Ala Allowed	nformation Provide A SPA 4th Floor Shell Renovation - Phase I Provide A SPA 4th Floor Shell Renovation - Phase I Provide A Alteration Provide A Alteration Provide A Alteration Provide A Alteration Provide A Area Category Provide A Alteration Provide A Alteratio	4" SQUARE BOX FOR LINE VOLTAGE WIRES, NOT ALL WIRES ARE SHOWN
					Energy Code Project Title Project Type Constructio 250 N. Wa Mobile, Ala Allowed 1-Common	nformation e: 2015 IECC : ASPA 4th Floor Shell Renovation - Phase I : Alteration n Site: Owner/Agent: Designer/Contractor: ter Street tabama 36602 Interior Lighting Power Area Category B C D Floor Area Allowed Watts / ft2 Watts	4" SQUARE BOX FOR LINE VOLTAGE WIRES, NOT ALL WIRES ARE SHOWN
					Energy Code Project Title Project Type Constructio 250 N. Wa Mobile, Ala Allowed 1-Common Propose Fixtu	nformation	4" SQUARE BOX FOR LINE VOLTAGE WIRES, NOT ALL WIRES ARE SHOWN
					Energy Code Project Title Project Type Constructio 250 N. Wa Mobile, Ala Allowed 1-Common Proposed Fixtu Common S LED: DL: LED: DL: LED: LS: 0 LED: WL: LED: LS: 0 LED: WL: LED: LB: 0 Interior Lig Interior Stateme Compliance building pla systems ha	Importation	() OCCUPANCY SENSOR POW MET MET MET MET MET MET MET MET
					Energy Code Project Title Project Type Constructio 250 N. Wa Mobile, Ala Allowed 1-Common Proposed Fixtu Common S LED: DL: LED: DL: LED: LS: 0 LED: WL: LED: LS: 0 LED: WL: LED: LB: 0 Interior Lig Interior Stateme Compliance building pla systems ha	nformation minimize 2015 IECC minimize ASPA 4th Floor Shell Renovation - Phase I minimize Aspa 4th Floor Shell Renovation - Phase I minimize Alteration mission Designer/Contractor: The image of the state of the s	() OCCUPANCY SENSOR POV NOT TO SCALE
					Energy Code Project Title Project Type Constructio 250 N. Wa Mobile, Ala Allowed 1-Common 1 Proposed Fixtu Common 2 LED: DL: LED: DL: LED: LS: 0 LED: WL: LED: LS: 0 LED: WL: LED: LB: 0 Interior Lig Interior Stateme Compliance building pla systems ha applicable r	nformation minimize 2015 IECC minimize ASPA 4th Floor Shell Renovation - Phase I minimize Aspa 4th Floor Shell Renovation - Phase I minimize Alteration mission Designer/Contractor: The image of the state of the s	OCCUPANCY SENSOR POWER VITAGE WIRES, NOT ALI WIRES ARE SHOWN 3 OCCUPANCY SENSOR POWER NOT TO SCALE



		TO 20
	SCHEDULE	1" CONDUIT (WITH PULL STRING ROUTED IN THE COLUMN TO ABOVE ACCESSIBLE CEILING.
SEMI CESSED	4" SEMI RECESSED DIMMABLE LED DECORATIVE FIXTURE GLASS TRIM OPTION TO BE SELECTED BY ARCHITECT PRIOR TO ORDER PROVIDE INTEGRAL BATTERY BACK UP AS INDICATED	TERMINATE WITH BUSHING. 1" CONDUIT WITH PULL STRING ROUTED FROM THE NEW COLUMN JUNCTION BOX TO THE NEW DATA JUNCTION BOX. ROUTING SHOWN IS
PENDED	2" WIDE 4' LONG SLIM BEAM DIMMABLE LED FIXTURE COLOR & MOUNTING TO BE COORDINATED WITH ARCHITECT PRIOR TO ORDER PROVIDE INTEGRAL BATTERY BACK UP AS INDICATED	DIAGRAMMATICAL FOR CLARITY. ALL CONDUIT IS TO BE CONCEALED IN THE NEW WALL. NEW DATA JUNCTION BOX IS TO BE INSTALLED
RFACE	2" WIDE 4' LONG SLIM BEAM DIMMABLE SURFACE MOUNTED LED FIXTURE PROVIDE ALL MOUNTING HARDWARE FOR A SECURE INSTALLATION ON A GRID CEILING PROVIDE INTEGRAL BATTERY BACK UP AS INDICATED	ADJACENT TO THE NEW RECEPTACLE.
CESSED	2X2 DIMMABLE LED FLAT PANEL PROVIDE INTEGRAL BATTERY BACK UP AS INDICATED	 (2) NEW 4" x 4" JUNCTION BOXES WITH BLANK COVER PLATES/ 3/4" C ONE FOR POWER ONE FOR FUTURE DATA NEEDS RECE SHOW
RFACE ED WITH AN	2' LED DIMMABLE UTILITY FIXTURE TO BE MOUNTED ON WALL ABOVE DOOR IN CLOSET SPACE EMERGENCY BALLAST, 1100 LUMENS OR THE MAXIMUM AVAILABLE FOR THE FIXTURE.	COLUMN CONDUIT ROUTING DETAIL (1 <u>NEW WORK POWER PLAN FOR MORE</u> NOT TO SCALE
ON.		
TO FIXTURE		WRITE ON THE FRONT OF EACH WIRING DEVICE THE CORRESPONDING CIRCUIT DESIGNATION SO THAT IT IS NOT VISIBLE WITH THE COVERPLATE ON. LETTERING SHALL BE 1/4" HIGH, FINE POINT PERMANENT FELT TIP BLACK MARKER, BY HAND. USE WHITE MARKER ON BLACK DEVICES. RECEPTACLE WITH COVERPLATE REMOVED
Project I Project Titles Project Type	ASPA 4th Floor Shell Renovation - Phase I	2 WIRING DEVICE LABEL DETAIL NOT TO SCALE
	ter Street bama 36602 Interior Lighting Power A B C D	4" SQUARE BOX FOR LINE VOLTAGE WIRES, NOT ALL
1. Common (Area CategoryFloor Area (ft2)Allowed Watts / ft2Allowed WattsSpace Types:Restrooms5300.98519	WIRES ARE SHOWN
Proposed	Total Allowed Watts = 519 I Interior Lighting Power A B C D E re ID : Description / Lamp / Wattage Per Lamp / Ballast Lamps/ # of Fixture (C X D) Fixture Fixture Watt.	3 OCCUPANCY SENSOR POWE NOT TO SCALE
Common S LED: DL: (LED: LS: (LED: FP: (LED: WL: LED: LB: (Dther: 1 4 25 100 Dther: 1 6 19 116 Other: 1 2 8 15	ROOF
Interior I Stateme Compliance building plan systems hav	Statement: The proposed interior lighting alteration project represented in this document is consistent with the specifications, and other calculations submitted with this permit application. The proposed interior lighting ve been designed to meet the 2015 IECC requirements in COM <i>check</i> Version COM <i>checkWeb</i> and to comply with any handatory requirements listed in the Inspection Checklist.	NOTE: ALL RECESSED FIXTURES SHALL BE WIRED FROM FIXTURES SHOWN IN CONTINUOUS ROWS; NO WIRIN OPTION, SEVERAL FIXTURES (NOT TO EXCEED 4) MA
Name - Title	Signature Date	3/8" FMC 4 FOOT (MINIMUM) TO 6 FOOT (MAXIMUM) LONG PROVIDE CEILING SUPPORT WIRE WITHIN 6" OF EACH OF FOUR FIXTURE CORNERS RECESSED LED LIGHTING FIXTURE
Project Title: Data filenam		4 TYPICAL FIXTURE INSTALLATI NOT TO SCALE

20A/1 BREAKER

x 4" SQUARE JUNCTION BOX MOUNTED ABOVE E CEILING


CONDUIT ROUTED IN THE COLUMN TO A NEW x 4" JUNCTION BOX WITH BLANK COVER PLATE

W ROUGH IN LOCATION FOR FUTURE TELECOM EDS. THE JUNCTION BOX IS TO BE INSTALLED DJACENT TO THE RECEPTACLE.

EW RECESSED DUPLEX RECEPTACLE

" CONDUIT AND WIRING ROUTED FROM THE NEW LUMN JUNCTION BOX TO THE NEW DUPLEX ECEPTACLE IN THE EXTERIOR WALL. ROUTING HOWN IS DIAGRAMMATICAL FOR CLARITY. ALL ONDUIT IS TO BE CONCEALED IN THE NEW WALL.

(TYPICAL - SEE INFORMATION)

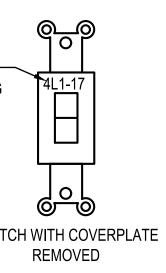

E NOT IN CONDUIT SUPPORTED OKS OR OTHER APPROVED D TO OCCUPANCY SENSOR(S).

ER PACK DETAIL

ROM A JUNCTION BOX AS SHOWN ABOVE, INCLUDING RING THROUGH FIXTURES. AT CONTRACTOR'S) MAY BE WIRED TO A COMMON JUNCTION BOX.


TION BOX SECURE TO STEEL JOIST OR PENDANT WITH THREADED ROD AND REQUIRED HANGERS.

VIDED FIXTURE GRID CLIPS TO PREVENT LING THRU GRID (4 REQ).

SUSPENDED CEILING

TION DETAIL

F \square CONSULTING CHRISTINA MARIE P.E. PE 50660 - ECA 50377 C: (251) 455-9189 JaguarEngineers@Yahoo.Com

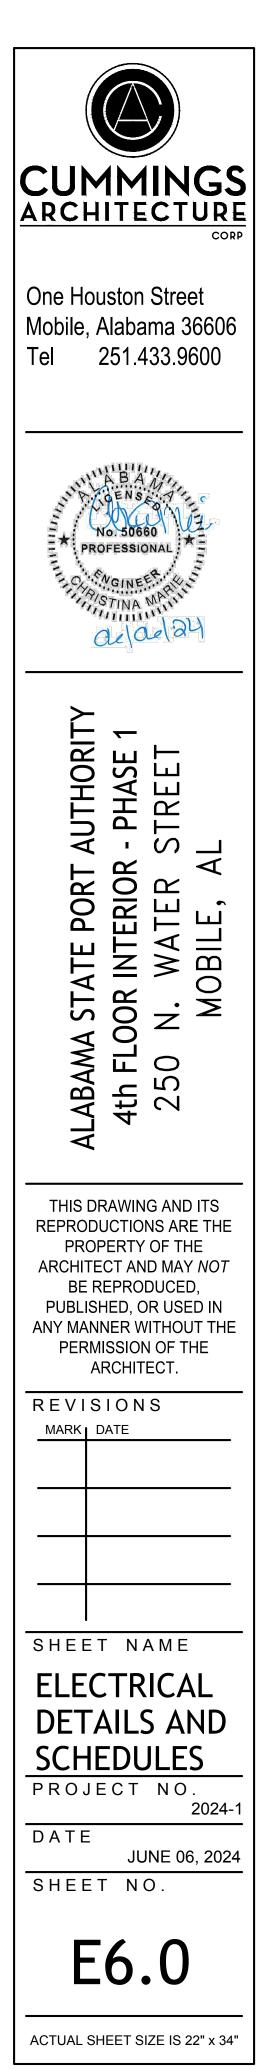

KOHLER_®

Features

- Washout urinal.
- 3/4" top spud.
- 0.125 gpf (0.47 lpf) to 1.0 gpf (3.8 lpf).
- 14" (356 mm) extended rim.
- Will replace K-4904-ET.

Material

Vitreous china.

Water Conservation & Rebates

 WaterSense-compliant when used with a 0.125 gpf or 0.5 gpf WaterSense flushometer.

Recommended Accessories

K-10668 WaterSense® 0.125 gpf Exposed Flushometer K-10949 Tripoint[™] DC 1/8 GPF Urinal Flushometer K-13520 WaterSense® 0.125 gpf Exposed Flushometer K-7528 WAVE HES 1/8 GPF Urinal Flushometer K-7546 Tripoint™ HES 1/8 GPF Urinal Flushometer K-10675 WAVE DC 0.5 GPF Urinal Flushometer K-10958 Tripoint™ DC 0.5 GPF Urinal Flushometer K-7537 0.5 gpf Exposed Flushometer K-7526 WAVE HES 0.5 GPF Urinal Flushometer K-13519 0.5 gpf Exposed Flushometer K-10676 WAVE DC 1.0 GPF Wshdwn Flushometer K-10960 1.0 gpf Exposed Flushometer K-13518 1.0 gpf Exposed Flushometer K-7539 Tripoint[™] HES 1.0 GPF Blwout Flushometer K-7542 1.0 gpf Exposed Flushometer K-7527 1.0 gpf Exposed flushometer

Components

Additional included component/s: 3/4" inlet spud, 2" outlet spud, Strainer, and Hangers (2).



Bardon™

K-4991-ET

High-Efficiency Urinal



Codes/Standards ASME A112.19.2/CSA B45.1 DOE - Energy Policy Act 1992 EPA WaterSense® ADA ICC/ANSI A117.1

KOHLER[®] One-Year Limited Warranty

See website for detailed warranty information.

Available Color/Finishes

Color tiles intended for reference only.


Color Code Description


- 0 White
- 47 Almond
- 7 Black Black™
- 96 Biscuit



KOHLER_®

Bardon[™] High-Efficiency Urinal K-4991-ET

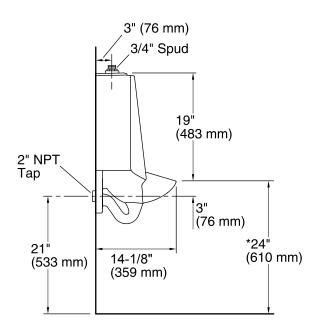

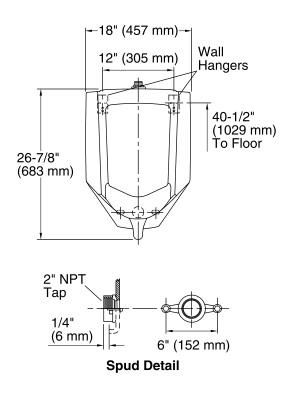

Technical Information

All product dimensions are nominal. Flush outlet Washout technology: Spud size: 3/4", Inlet, Top Min. Water per Flush: 0.125 gal (0.5 L) Max. Water per Flush: 1 gal (3.8 L) Designed for the above water use when installed with a water-saving flushometer.

Notes

Install this product according to the installation guide.

Refer to manufacturer's instructions and local codes for flushometer requirements.

ADA compliant when installed to the specific requirements of these regulations.





Wellcomme[™] Ultra

Elongated Floor Mount, Flushometer Bowl K-96053

Features

- Elongated, Standard height bowl.
- 1-1/2" top spud.
- 10" x 7" water surface size.
- 2-1/8" glazed trapway.
- Also available with antimicrobial finish K-96053-SS.

Material

• Vitreous china.

Technology

- Designed to outperform competitors in bowl cleanliness and plug resistance.
- Maximum waste removal.
- Engineered for toilet seat cover removal.
- Excellent bowl rinse.
- Engineered to flush effectively in buildings with low supply pressure and flow*.
- Maximum drain line carry at all flush volumes per ASME Standard.

Installation

- 26-3/8" L x 14-7/8" W x 15-1/4" H
- 10" or 12" rough-in
- Replaces Wellcomme K-4350 and Wellworth K-4406. Height and footprint may vary.

Water Conservation & Rebates

- 1.1 to 1.6 gpf flush range (1.1, 1.28 and 1.6 gpf).
- WaterSense compliant when used with a 1.1 or 1.28 gpf WaterSense flushometer.

Optional Accessories

K-4731-C Commercial Heavy-Duty Toilet Seat K-4731-CA Commercial Heavy-Duty Toilet Seat K-7531 Tripoint[™] HES 1.28 GPF WC Flushometer K-7535 Tripoint[™] HES 1.6 GPF WC Flushometer K-7521 WAVE HES 1.28 GPF WC Flushometer K-7523 WAVE HES 1.6 GPF WC Flushometer K-10673 WAVE Touchless Toilet 1.28 gpf Flushometer K-10674 Wave DC 1.6 GPF WC Flushometer K-76320 Manual 1.1 GPF WC Flushometer K-76321 Manual 1.28 GPF WC Flushometer K-76322 Manual 1.6 GPF WC Flushometer

Components

Additional included component/s: Spud, and Bolt Cap Accessory Pack.





Codes/Standards ASME A112.19.2/CSA B45.1

DOE - Energy Policy Act 1992 EPA WaterSense[®] California Energy Commission (CEC)

KOHLER[®] One-Year Limited Warranty

See website for detailed warranty information.

Available Color/Finishes

Color tiles intended for reference only.

Color Code Description

0	White
96	Biscuit
47	Almond
7	Dia als Di


7 Black Black™





Wellcomme[™] Ultra

Elongated Floor Mount, Flushometer Bowl K-96053

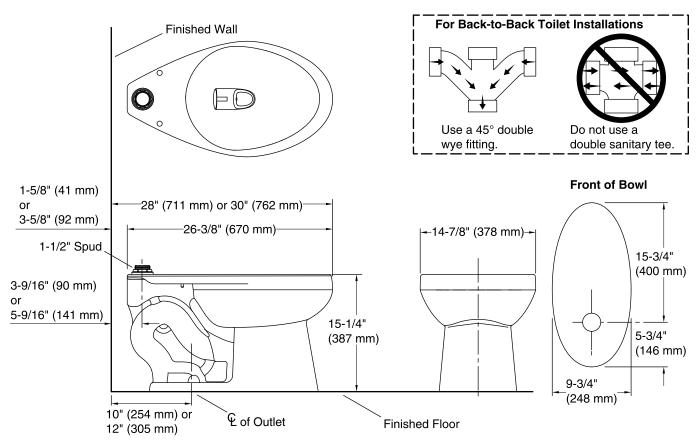

Technical Information

All product dimensions are nominal.

Toilet type:	Flushometer, Floor-mount
Waste Outlet:	Floor
Bowl shape:	Elongated front
Flush type:	Flushometer valve siphon
Spud size:	1-1/2", Inlet, Top
Trap passageway:	2-1/8" (54 mm)
Water Consumption	
Full:	1.1 gpf (4.3 lpf) or 1.28 gpf (4.8 lpf)
	or 1.6 gpf (6 lpf)
Water surface size:	10" x 7" (254 mm x 178 mm)
Rim to water surface:	6" (152 mm)
Rough-in:	10" or 12" (254 or 305 mm)
Seat-mounting holes:	5-1/2" (140 mm)

Fixture Supply Requirements

Min static pressure:	35 psi (241.3 kPa)
Max static pressure:	80 psi (551.6 kPa)
Min flowing pressure:	25 psi (172.4 kPa)
Min flow rate:	25 gpm (94.6 lpm)

USA/Canada: 1-800-4KOHLER (1-800-456-4537)

Kohler Co. reserves the right to make revisions without notice to product specifications.

Notes

Install this product according to the installation instructions.

For back-to-back toilet installations: Use only a 45° double wye fitting.

If Fixture Supply Pressure is below 35 psi static, then fixture must be paired with a valve rated at 1.28 gpf or greater.

Requires flushometer valve to match desired water consumption 1.1 gpf (4.3 lpf) or 1.28 gpf (4.8 lpf) or 1.6 gpf (6 lpf).





Kingston™ Elongated toilet bowl K-25076-SS

Features

- Ideal for commercial installations
- Antimicrobial finish inhibits the growth of mold-, mildew-, stain-, and odor-causing bacteria on the fixture surface. This product does not protect users against bacteria, viruses, or other disease organisms. Always clean and wash this product thoroughly before and after each use
- Elongated bowl offers added room and comfort
- 2-1/8" (54 mm) fully glazed trapway
- Combines with a K-25100, K-25100-RA, K-25100-T or K-25100-TR tank to create a complete K-25077-SS, K-25077-SSRA, K-25077-SST or K-25077-SSTR Kingston two-piece toilet

Installation

- Three-bolt quick-connect installation
- Standard 12" (305 mm) rough-in
- Seat sold separately

Recommended Products/Accessories

K-23726 Drain treatment



ADA CSA B651 OBC



Codes/Standards

ASME A112.19.2/CSA B45.1 EPA WaterSense® ADA ICC/ANSI A117.1 CSA B651 OBC

KOHLER[®] Toilets and Seats Limited Warranty

See website for detailed warranty information.

Available Colors/Finishes

Color tiles intended for reference only.

Color Code Description

0 White





No image available. This product is a component and not intended to be a standalone installation.

Technical Information

All product dimensions are nominal.			
Toilet type:	Floor-mount		
Waste Outlet:	Floor		
Bowl shape:	Elongated		
Flush type:	Gravity siphon jet		
Trap passageway:	2-1/8" (54 mm)		
Water surface size:	10-5/8" x 6-15/16" (269 mm x 176 mm)		
Rim to water surface:	5-5/8" (143 mm)		
Rough-in:	12" (305 mm)		

Notes

Install this product according to the installation instructions.

ADA, OBC, CSA B651 compliant when installed to the specific requirements of these regulations.

Plumbing codes may require elongated toilets and elongated, open-front seats in public bathrooms.

Accessibility standards may require controls to be located on the open side of the toilet.



SLOAN.

OPTIONS

Flush Volume

1.28 gpf (4.8 Lpf) (1.28) 1.6 gpf (6.0 Lpf) (1.6)

Power Type

Battery Hardwired

Water Efficiency

High Efficiency Low Consumption

Override

True Mechanical (TMO)

Outlet Tube

Trap Primer (TP)

Bumper

Angle Stop (YO)

Compliances & Certifications

ADA Compliant BAA Compliant UPC Certified cUPC Certified BREEAM Water Credit Green Globes Water Credit LEED V4 Water Efficiency Credit Satisfies LEED Credits WaterSense Listed cUPC Green Certified

NOTES

For product line drawings, view model-specific spec sheets.

All information contained within this document subject to change without notice.

ROYAL® SENSOR FLUSHOMETER ROYAL 111 SMOOTH



Image for a standard ROYAL 111 SMOOTH shown

DESCRIPTION

Royal® Exposed Sensor Water Closet Flushometer

FEATURES

- All organic rubber has been replaced with synthetic compounds
- Critical components, including cover, valve body, control stop and sweat solder kit, are made of semi-red brass
- PERMEX synthetic rubber diaphragm with Dual Filtered Fixed Bypass
- Valve body, Cover, Tailpiece and Control Stop shall be in compliance with ASTM Alloy Classification for Semi-Red Brass
- Valve shall be in compliance to the applicable sections of ASSE 1037.

DOWNLOADS

- EBV 200 Smooth Installation Instructions
- EL 600-A Installation Instructions
- Royal Exposed Installation Instructions
- Royal Exposed Spanish Installation Instructions
- Control Stop Repair and Maintenance Guide
- Flush Connections Flanges Repair and Maintenance Guide
- Tail Piece Repair and Maintenance Guide
- Royal Manual Diaphragm Flushometer Repair and Maintenance Guide
- EBV-200-A Repair and Maintenance Guide
- EL600A Smooth Side Mount Repair and Maintenance Guide
- Additional Downloads

Sloan 10500 Seymour Ave, Franklin Park, IL 60131 Phone: 800.982.5839 • Fax: 800.447.8329 • sloan.com

SLOAN.

OPTIONS

Flush Volume

0.125 gpf (0.5 Lpf) (0.125) 0.25 gpf (0.9 Lpf) (0.25) 0.5 gpf (1.9 Lpf) (0.5) 1.0 gpf (3.8 Lpf) (1.0) 1.5 gpf (5.7 Lpf) (1.5)

Power Type

Battery Hardwired

Water Efficiency

High Efficiency Low Consumption Water Saver

Bypass

Dual-Filtered Bypass

Override

True Mechanical (TMO)

Compliances & Certifications

ADA Compliant

- BAA Compliant
- cUPC Certified
- UPC Certified
- BREEAM Water Credit
- Green Globes Water Credit LEED V4 Water Efficiency Credit
- Satisfies LEED Credits
- WaterSense Listed
- cUPC Green Certified

NOTES

For product line drawings, view model-specific spec sheets.

All information contained within this document subject to change without notice.

Image for a standard ROYAL 186 SMOOTH shown

DESCRIPTION

Royal® Exposed Sensor Urinal Flushometer

FEATURES

- Includes the required wall plate and a purple wall flange to let users know reclaimed water is in use
- All organic rubber has been replaced with synthetic compounds
- Optional purple handle provides additional indication of reclaimed water use
- Critical components, including cover, valve body, control stop and sweat solder kit, are made of semi-red brass
- PERMEX synthetic rubber diaphragm with Dual Filtered Fixed Bypass
- Valve body, Cover, Tailpiece and Control Stop shall be in compliance with ASTM Alloy Classification for Semi-Red Brass
- Valve shall be in compliance to the applicable sections of ASSE 1037.

DOWNLOADS

- EL 600-A Installation Instructions
- EBV 200 Smooth Installation Instructions
- Royal Exposed Installation Instructions
- Royal Exposed Spanish Installation Instructions
- Control Stop Repair and Maintenance Guide
- Flush Connections Flanges Repair and Maintenance Guide
- Tail Piece Repair and Maintenance Guide
- EBV-200-A Repair and Maintenance Guide
- EL600A Smooth Side Mount Repair and Maintenance Guide
- Royal Manual Diaphragm Flushometer Repair and Maintenance Guide

ROYAL® SENSOR FLUSHOMETER ROYAL 186 SMOOTH



Additional Downloads

SLOAN.

OPTIONS

Power Type

Battery

Body Type

Low

Mounting

Deck

Power Supply

Battery (BAT)

Sensor Type

Infrared

Flow Rate

0.35 gpm (1.3 Lpm) (0.35GPM) 0.5 gpm (1.9 Lpm) (0.5GPM)

Spray Type

Multi-Laminar (MLM)

Spout Type

Pedestal

Trim Plate

4" (102mm) (4)

Finish

Polished Chrome (CP)

Control Access

Below Deck

Mixer

Back-Check Tee (TEE) Below Deck Manual Mixing Valve (BDM)

Compliances & Certifications

ADA Compliant ASME A112.18.1 Compliant CEC Compliant CalGreen Compliant IAPMO NSF-61 NYC604.4 Proposition 65 TAS UPC Certified

NOTES

For product line drawings, view model-specific spec sheets.



Image for a standard SF-2150 shown

DESCRIPTION

Sloan® Battery-Powered Deck-Mounted Low Body

FEATURES

Commercial Grade, ADA Compliant, Electronic, Sensor-Activated, Brass Pedestal Hand Washing Faucet with the following features:

- Adjustable Infrared Sensor Range
- 36" (914 mm) Long Sensor Cable
- 24" (610 mm) Long Flex Hose
- Filtered Solenoid Valve with serviceable Strainer Filter
- Includes Four (4) AA-size Batteries
- Includes appropriate Mounting Hardware
- 1 Year limited warranty

DOWNLOADS

- SF Series Installation Instructions
- SF Series (FR) Installation Instructions
- SF Series (SP) Installation Instructions
- SFP 35-A Installation Instructions
- SF 2100/2150 Faucet Extension Installation Instructions
- Trim Plate Guide
- Sloan 2100/2150 Repair and Maintenance Guide
- Additional Downloads

VIDEOS



SF-2100/2150/SF-2200/2250/SF-2300/2350/SF-2400/2450 Parts Breakdown

SF-2100/2150/SF-2200/2250/SF-2300/2350/SF-2400/2450 Module Replacement

Sloan 10500 Seymour Ave, Franklin Park, IL 60131 Phone: 800.982.5839 • Fax: 800.447.8329 • sloan.com



All information contained within this document subject to change without notice.

Find a matching soap dispenser for this faucet. Find a compatible sink for this faucet.




SF-2100/2150/SF-2200/2250/SF-2300/2350/SF-2400/2450 Battery Replacement- Sensor Range Adjustment





TAG

Dimensional Data (inches and [mm]) are Subject to Manufacturing Tolerances and Change Without Notice

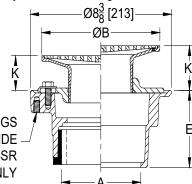

FOUR 3/8-16NC TAPPINGS PROVIDED ON UNDERSIDE FOR -SA, -SQ, AND -SR SUFFIX OPTIONS ONLY

Dimensions in Inches [mm]						Strainer Open	
	B Strainer	K		K'		Approx. Wt. Lbs. [kg]	Area Sq. In.
A - Pipe Size	Dia.	Min.	Max.	Min.	Max.	Eb0. [Kg]	[cm ²]
2,3 [51,76]	5 [127]	1 [25]	1-1/2 [38]	1-3/32 [28]	2-1/4 [57]	11 [5]	6-1/4 [40]
2,3,4 [51,76,102]	6 [152]	1 [25]	1-25/32 [45]	1-13/32 [36]	2-17/32 [64]	13 [6]	9 [58]
2,3,4 [51,76,102]	7 [178]	1 [25]	2-1/8 [54]	1-23/32 [44]	2-7/8 [73]	14 [6]	12 [77]
3,4 [76,102]	8 [203]	1-5/32 [30]	2-1/8 [54]	1-3/4 [44]	2-7/8 [73]	16 [7]	19 [123]
6 [152]	8 [203]	1-5/32 [30]	2-1/8 [54]	1-3/4 [44]	2-7/8 [73]	18 [8]	19 [123]
6 [152]	10 [254]	1-7/16 [37]	2-1/2 [64]	2 [51]	3-1/4 [83]	22 [10]	23 [148]

ENGINEERING SPECIFICATION: ZURN ZN415B

Floor and shower drain, Dura-Coated cast iron body with bottom outlet, combination invertible membrane clamp and adjustable collar with seepage slots and "TYPE B" polished nickel bronze, light-duty heel-proof strainer.

OPTIONS (Check/specify appropriate options)

	(Specify size	/type) OUTLET	'E' BODY HT. DIM.
2,3,4 [51,76,102]	L IČ	Inside Caulk	4-3/16 [106]
2 [51]	IP	Threaded	2-7/16 [62]
3 [76]	IP	Threaded	2-3/4 [70]
4 [102]	IP	Threaded	2-13/16 [71]
6 [152]	IP	Threaded	2-7/8 [73]
2,3,4 [51,76,102]	NH	No-Hub	3-13/16 [97]
2,3,4 [51,76,102]	NL	Neo-Loc	3-7/8 [98]

PREFIXES

D.C.C.I. Body Assembly w/ Polished Bronze Top __ ZB

7900 Goreway Drive, Unit 10, Brampton, Ontario L6T 5W6, Ph. 877.892.5216

ZN	D.C.C.I. Body	Assembly w/	Polished Nick	el Bronze Top
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SUFFIXES

	•				
	Chrome-Plated BronzeTop Galvanized Cast Iron Heavy-Duty Slotted Grate (ZN 5,6[127,152]Sizes Only) Oval Funnel (See Z329-7) (7,8,10[178,203,254] Strainers only) Trap Primer Connection (Specify 1/2 [13] or 3/4 [19]) Protective Cover Stabilizer Assembly (See Z1035)		Neo-loc Test Cap Gasket (2,3,4 [51,76,102] NL Outlet Only) 1-3 [25-76] High Extension Adapter Backwater Valve		
 WARNING: Cancer and Reproductive Harm - <u>www.P65Warnings.ca.gov</u> ADVERTENCIA: Cáncer y daño reproductivo - <u>www.P65Warnings.ca.gov</u> AVERTISSEMENT: Cancer et effets néfastes sur la reproduction - <u>www.P65Warnings.ca.gov</u> 					
Zurn Industries, LLC Specification Drainage Operation 1801 Pittsburgh Avenue, Erie, PA USA 16502, Ph. 855.663.9876			Rev. X		

In Canada | Zurn Industries Limited

01/05/23 Date: 144898 C.N. No. Patent zurn.com/patents Prod. | Dwg. No. Z415B