Request for Qualifications / Request for Proposals



PROFESSIONAL SERVICE CONTRACT

RFP/RFQ Number ASPA-TS-2024-04 ITC Fourth Floor Phase II Architectural Services

November 2024

Issued By
ENGINEERING DEPARTMENT
ALABAMA STATE PORT AUTHORITY

John C. Driscoll, Director & CEO Kay Ivey, Governor of Alabama

Professional Service Contract Request for Qualifications / Proposals Alabama State Port Authority RFP Number: ASPA-TS-2024-04 ITC Fourth Floor Phase II Architectural Services

1.0 INTRODUCTION

The Alabama State Port Authority (ASPA) submits this Request for Proposals and Qualifications (RFP) to solicit Statements of Qualifications (SOQ) and a Fee Proposal from those entities (Respondents) interested in providing Professional Architect Services related to the design and construction of interior improvements to the 4th Floor of the International Trade Center.

Details on the requirements of the Request for Proposals and Qualifications (RFP) and the criteria for selection will be described in more detail in subsequent sections of this document. All respondents must meet all requirements to practice Architecture in the State of Alabama. All times noted within this document are local times. Any requests for information must be given in written form. No verbal inquiries will be recognized.

To facilitate the review and award of a contract, the RFQ and Request for Proposals (RFP) are combined into one step, hereinafter referred to as Request for Proposals (RFP). The purpose of this RFP is to solicit information that will enable ASPA to determine which Respondent is best qualified to provide the required architectural services.

The Contract award will be qualification-based for services during the design and construction phases of the project. Services will be performed on a time and materials basis for the duration of the Agreement.

There will be an on-site pre-submittal meeting at 3:00 pm on Tuesday, December 3, 2024, at the International Trade Center, 250 North Water Street, Mobile, AL.

2.0 BACKGROUND INFORMATION

2.1 Respondent's Scope of Work

The Alabama State Port Authority (ASPA) intends to procure one Professional Architect firm for the detailed design of improvements to the 4th Floor of the International Trade Center (ITC) located at 250 North Water Street in Mobile, Alabama. The ITC is ASPA's primary administrative office space in the heart of downtown Mobile, AL. Originally constructed in the 1960's, the fourth floor housed a full-service kitchen, dining room, lounge and tenant office spaces. In 2021, a new HVAC system was installed including 18 VAV's on the fourth floor. In 2022, except for the HVAC components, the space was gutted to prepare for renovations. In 2023, the original plate glass store front window system was replaced with Low E, insulated, fixed, impact windows. This year,

new ADA compliant restrooms and other improvements will be completed in Phase One of 4th floor renovations.

This RFP is for Phase Two Architectural services. The fourth floor consists of a total of 12,000 square feet including the core. The core contains new ADA compliant restrooms, two cable hoist elevators, one hydraulic freight elevator, two stair wells and mechanical spaces. Aside from the core, and a few structural concrete columns, the remainder of the floor is open with 12 to14-foot ceiling height which is somewhat cluttered with mechanical, plumbing and electric equipment. The ceiling/roof and floor are cast in place reinforced concrete. The interior walls (lining the core), floors and ceiling will be bare at the conclusion of Phase One. The exterior walls will be drywall over metal stud framing to a height of 12 feet. Communication conduit and electrical circuits will be provided in every one of the 34 window bays on the four exterior walls.

ASPA would like to transform this now vacant space into a (natural) light filled workspace for approximately 30 occupants including the ASPA Senior staff and their support staff that currently occupy the floors below. The organization and relationships of the staff are indicated on the attached Executive Staffing Chart. Six individuals in black lettering will require more dedicated space without being isolated from the remainder of the staff. A combination of conference rooms, collaborative work space, warming kitchen, beverage bar, and work stations are desired. Some spaces may be set aside by transparent or semi-transparent walls, but openness and natural light are desired.

The Architect will be charged with designing a space that is unobstructed yet quiet, well-conditioned but not cluttered with mechanical equipment, and finished with modern flooring, wall finishes and accents. The scope will include finishes, fixtures and furnishings, lighting, electrical, mechanical, plumbing and fire alarm / suppression.

2.3 Federal and State of Alabama Requirements

- Transportation Worker Identification Credential (TWIC) is not required for this
 project however, any person entering ASPA facilities is subject to background
 screening.
- b. It is not anticipated that this project will include work near active rail facilities. Federal Railroad Administration safety requirements of Title 49, Part 214 of the Code of Federal Regulations (CFR) will be applicable when accessing an area within 25 feet of an active track center line. CFR requirements may be found at https://www.ecfr.gov/current/title-49/subtitle-B/chapter-II/part-214.
- c. Beason-Hammon Alabama Taxpayer & Citizen Protection Act is applicable to any business entity contracting with the Alabama State Port Authority. The E-Verify website link is provided for convenience: http://immigration.alabama.gov/eVerify.aspx.

2.4 Schedule

ASPA currently anticipates conducting this procurement in accordance with the following list of milestones. This schedule is subject to revision and ASPA reserves the right to modify this schedule as it finds necessary, in its sole discretion.

• Advertise RFP/RFQ: November 14, 2024 • Pre-Submittal Meeting – 3:00 p.m. December 3, 2024 • Deadline to submit questions: December 10, 2024 ASPA Response to questions: December 13, 2024 • Deadline to submit RFP/RFQ – 3:00 p.m. December 20, 2024 • Short List Presentations (optional) January 6, 2025

The following dates are tentative:

 Notice of Intent to Award Date: January 10, 2025 Contract effective Date (NTP): February 1, 2025 Concept Submittal: February 21, 2025 • 60% Design Submittal: March 21, 2025 Final Design Submittal: April 18, 2025 Advertise/Award Construction Contract: May 2025

2.5 **ASPA's Point of Contact**

ASPA's sole point of contact (POC) for matters related to this RFP/RFQ is Pete Olivero. ASPA's POC is the only individual authorized to discuss the RFP/RFQ with any interested parties, including Respondents. All communications with POC about this RFP/RFQ shall be in writing addressed as follows.

Peter Olivero, PE, PLS, Facilities Engineer Alabama State Port Authority P.O. Box 1588 Mobile, AL 36633

Phone: 251-441-7533

Email: pete.olivero@alports.com

ASPA disclaims the accuracy of information derived from any source other than POC, and the use of any such information is at the sole risk of the Respondent.

2.6 Acknowledgement of Receipt of RFP/RFQ Revisions, and/or Addenda

Respondent shall provide to ASPA the Acknowledgement of Revisions and/or Addenda set forth as Attachment 2.6, signed by the Respondent's Principal Officer with the submission of the RFP package.

3.0 **CONTENTS OF RFP SUBMISSION PACKAGE**

General

Responses to this RFP/RFQ will be used to select one firm to provide Professional Architect services as described herein and is intended to enable Respondents to demonstrate their qualifications, and to enable ASPA to evaluate those qualifications.

The Proposal submitted shall consist of two (2) separate components. The first is the Statement of Qualifications and the second is the Financial Proposal.

Written proposals will be evaluated by an ASPA selection committee. Members of the selection committee will independently review each of the proposals and score it using the criteria in Attachment 6.0 – SOQ Score Sheet.

3.2 Statement of Qualifications

- **3.2.1** The Respondent shall prepare a Statement of Qualifications document and place it in a separate envelope within the submission package. The SOQ should include specific information that will demonstrate the qualifications and experience required by this RFP/RFQ.
- **3.2.2** A Letter of Submittal shall be prepared on the Respondent's letterhead and identify the full legal name and address of the Respondent. The Respondent is defined as the legal entity who will execute the Contract with ASPA. The Letter of Submittal must: 1) be signed by an authorized representative of the Respondent's organization; and 2) identify an individual who will serve as the Point of Contact for the Respondent.
- **3.2.3** The Respondent should provide sufficient information to enable ASPA to understand and evaluate the Respondent's staff and experience. This should include personnel resumes and relevant projects using the Personnel Resume Form attached hereto as Attachment 3.2.3 or unique company forms containing the same information. Submittal should include photographs and renderings from other projects by the respondent that demonstrate the respondent's abilities and creativity in commercial applications like ours.
- **3.2.4** The consultant should demonstrate its ability to provide design services in a timely manner. Adequate staffing in number and quality will be considered. Indicate the home base of staff that will be involved with this project.

3.3 Financial Proposal

The Respondent shall prepare a fee schedule for the proposed professional services. The fee schedule is to include hourly rates, daily rates, mileage rates, reimbursable expenses, and other costs desired to be billable items. The breakdown shall include all team members, and any sub-consultants anticipated to be used. For informational purposes, the mark-up on sub-consultants will be limited to 5%.

One copy of the Financial Proposal shall be placed in a separate sealed envelope within the submission package. Only the Financial Proposals of the firm(s) selected for contract award will be opened and reviewed. The non-selected firms' Financial Proposals will be returned to them as sealed and unopened. The purpose of the Financial Proposal is to provide the ASPA with a benchmark for the cost of the professional services to be performed.

4.0 RFP SUBMISSION PACKAGE SUBMITTAL REQUIREMENTS

4.1 Due Date, Time and Location

All submissions, including hand-delivered packages, US Postal Service express mail, or private delivery service must be delivered to the following individual at the following address by 3:00 p.m. local time on December 20, 2024. Respondents shall furnish one (1) hardcopy and one (1) electronic copy on a USB drive in their submission package.

Peter Olivero, PE, PLS Alabama State Port Authority Engineering Department International Trade Center 250 North Water Street Mobile, AL 36602

4.2 SOQ Submission Verification (Must be included as last page of submission)

By signature below I verify that I have read and understand this RFP/RFQ, including:

 Willingness to sign ASPA's standard form agreement
Timely execution of the contract
Confirmed number of Addenda issued:
I hereby submit these qualifications for consideration.
SUBMITTING FIRM NAME:
SIGNATURE OF PRINCIPAL:
PRINTED NAME OF PRINCIPAL:
DATE:

4.3 Format

A sealed parcel containing the Statement of Qualifications, and the Financial Proposal envelop shall be submitted on the due date and time. The parcel shall be clearly marked to identify the RFP and to identify the contents. Neither fax nor email submissions will be accepted. Respondents are responsible for effective delivery by the above deadline, and late submissions will be rejected without opening and returned to the sender. ASPA accepts no responsibility for misdirected or lost proposals.

5.0 QUESTIONS AND CLARIFICATIONS

All questions and requests for clarifications regarding this RFP/RFQ shall be submitted to ASPA's POC in electronic format (submission by email to pete.olivero@alports.com)

by the deadline set forth in Section 2.4. No requests for additional information, clarification or any other communication should be directed to any other individual.

ASPA's responses to questions for clarification shall be in writing and may be accomplished by an Addendum. ASPA will not be bound by any oral communications, or written interpretations or clarifications that are not issued in writing set forth in an Addendum.

6.0 EVALUATION OF THE RFP SUBMISSION PACKAGE

ASPA will evaluate the submissions by virtue of scoring the Statement of Qualifications package using the rating criteria point system in Attachment 6.0 SOQ Score Sheet. The ASPA Evaluation Committee may select the highest scoring professional firms for short list interviews.

Short listed firms may be provided an opportunity to present and discuss their "Proposal" with the ASPA Evaluation Committee. This potential interview should not be considered a marketing opportunity but will focus on the team members that will be performing the work for the task orders. Interviews may be limited to thirty-minute presentation plus time for question-and-answer discussion.

The winning respondent will be selected based on demonstrated competence and qualification for the type of services required without regard to fee. After selection of the "Most Qualified" Respondent, an initial review, discussion and final negotiation of the Financial Proposal will be conducted. At conclusion, a Refined Financial Proposal may be required to reflect final cost negotiations. Failure to arrive at an acceptable cost for the services will result in rejection of the Proposer and commencement of contract discussion with the next highest ranked Respondent.

7.0 RIGHTS AND OBLIGATIONS OF ASPA

In connection with this procurement, ASPA reserves to itself all rights (which rights shall be exercisable by ASPA in its sole discretion) available to it under applicable law, including without limitation, the following, with or without cause and with or without notice:

- The right to cancel, withdraw, postpone or extend this RFP without incurring any obligations or liabilities.
- The right to modify all dates set or projected in this RFP.
- The right to suspend and terminate the procurement process for this RFP at any time.
- The right to issue addenda, supplements and modifications to this RFP.

• The right to respond to all, some, or none of the inquiries, questions and/or requests for clarification received relative to this RFP/RFQ.

ASPA assumes no obligations, responsibilities, and liabilities to reimburse all, or part of the costs incurred or alleged to have incurred by parties considering a response to and/or responding to the RFP/RFQ. All costs shall be borne solely by each Respondent.

8.0 ADMINISTRATIVE REQUIREMENTS

All Respondents shall comply with the following:

- Requirements for practicing Architecture in accordance with the provisions of Alabama Law and the Alabama Board of Architects.
- Beason-Hammon Alabama Taxpayer and Citizen Protection Act.

ASPA does not discriminate against a Respondent because of race, religion, color, sex, national origin, age, disability, or any other basis prohibited by state law relating to discrimination in employment.

9.0 INSURANCE

The Respondents to whom this contract is awarded will be required to furnish insurance in accordance with Attachment 9.0.

10.0 ATTACHMENTS

The following attachments are specifically made a part of, and incorporated by reference into, this RFP:

- ATTACHMENT 2.6 ACKNOWLEDGEMENT OF REVISION AND/OR ADDENDA
- ATTACHMENT 3.2.3 PERSONNEL RESUME FORM.
- ATTACHMENT 6.0 SOQ SAMPLE SCORE SHEET
- ATTACHMENT 9.0 INSURANCE REQUIREMENTS
- ITC Executive Staffing Chart
- ITC Fourth Floor Renovations Phase One Drawings



ATTACHMENT 2.6

ALABAMA STATE PORT AUTHORITY RFP/RFQ Number ASPA-TS-2024-04 ITC Fourth Floor Phase II Architectural Services

ACKNOWLEDGEMENT OF REVISION AND/OR ADDENDA

By signing this Attachment 2.6, the Offeror acknowledges receipt of the following revisions and/or addenda to the RFP for the above designated project which were issued under cover letter(s) of the date(s) shown hereon:

	Addendum Number	Dated:		
	Addendum Number	Dated:		
	Addendum Number	Dated:		
	Addendum Number	Dated:		
Signa	ture		Date	



ATTACHMENT 3.2.3 RFP/RFQ Number ASPA-TS-2024-04 ITC Fourth Floor Phase II Architectural Services

PERSONNEL RESUME FORM

Brief resume for personnel available for this project
a. Name & Title:
a. Name & Tide.
b. Task Assignment:
c. Name of Firm with which you are now associated:
d. Years experience: With this firm Years With Other Firms Years
Please list chronologically (most recent experience first) your employment history,
position and general experience or fields of practice for the last ten (10) years.
Attack additional management and
Attach additional pages as needed.
e. Education: Name & Location of Institution(s)/Degree(s)/Year/Specialization:
f Astivo Dogistration, Dissipling/Dogistration #
f. Active Registration: Discipline/Registration #:

g. Document the extent and depth of your relevant experience and qualifications. List at least three (3), but no more than five (5) relevant projects for which you have performed						
architectural services. For each project:						
Note your specific responsibilities and authorities, not those of the firm.						
2. Note whether experience is with current firm or with other firm.						
Provide beginning and end dates for each assignment.						

ATTACHMENT 6.0 SOQ SCORE SHEET

ASPA-TS-2024-04

ITC Fourth Floor Phase II Architectural Services

CRITERIA	TO BE RATED	Maximum Points	Respondent 1	Respondent 2	Respondent 3	Respondent 4
1. Knowledge & Experience The firm's knowledge and experience of full service design.		150				
2. Professional Qualifications The qualifications of firm members expected to participate in delivery of services offered including relevant experience, technical skills, and professional registration 150						
3. Capacity to Perform the Work The overall availability and adequacy of equipment, software and staff in both number and quality to perform the the services offered						
The past performance of the firm on similar projects including architectural, mechanical, electrical and fire protection.		250				
5. Understanding and Creativity	The firm's understanding of ASPA's requirements and the creativity applied in similar previous projects or concept offerings that are specific to this project	250				
6. Geographic Location	The geographic location and ability for timely response of the firm relative to the ASPA facilities in Mobile, Alabama	50				
		1000	0	0	0	0
Ranking by Score						

ALABAMA STATE PORT AUTHORITY INSURANCE REQUIREMENTS FOR CONTRACT WORK

INDEMNIFICATION

The Contractor shall assume all liability for and shall indemnify and save harmless the State of Alabama and the Alabama State Port Authority, and its officers and employees from all damages and liability for injury to any person or persons, and injury to or destruction of property, including the loss of use thereof, by reason of an accident or occurrence arising from operations under the contract, whether such operations are performed by himself or by any subcontractor or by anyone directly or indirectly employed by either of them occurring on or about the premises, or the ways and means adjacent during the term of the contract, or any extension thereof, and shall also assume the liability for injury and/or damages to adjacent or neighboring property by reason of work done under the contract.

INSURANCE REQUIREMENTS

The Contractor shall not commence work under the contract until he has obtained all insurance required under the following paragraphs and until such insurance has been approved by Alabama Sate Port Authority, nor shall the Contractor allow any subcontractor to commence work until all similar applicable insurance has been obtained by the subcontractor or the Contractor has provided coverage for the subcontractor. The Contractor shall provide, at his expense, insurance in accordance with the following:

General Requirements (applicable to all policies)

All policies of insurance must be written with companies acceptable to Alabama state port authority. The Contractor shall furnish to Alabama state port authority certificates of insurance, signed by the licensed agent, evidencing required coverages. Alabama state port authority reserves the right to require certified copies of any and all policies. Each policy of insurance shall provide, either in body of the policy or by endorsement, that such policy cannot be substantially altered or cancelled without thirty (30) days' written notice to Alabama state port authority and to the insured. Except for Workers Compensation, said policies will identify Alabama State Port Authority, its officers, officials, agents, servants and employees as Primary and Non-contributory Additional Insureds in connection with work performed for, on behalf of, or on the property of Alabama state port authority.

Commercial General Liability

The Contractor shall take out and maintain during the life of the contract Commercial General Liability insurance, including Blanket Contractual and Completed Operations coverages, in an amount not less than \$3,000,000 for any one occurrence for bodily injury, including death, and property damage liability.

Business Automobile Liability

The Contractor shall take out and maintain during the life of the contract Business Automobile Liability insurance covering <u>any auto</u> in an amount not less than \$1,000,000 for any one occurrence for bodily injury, including death, and property damage liability.

Workers Compensation


The Contractor shall take out and maintain during the life of the contract Workers Compensation and Employers Liability insurance providing coverage under the Alabama Workers Compensation Act in an amount not less than that required by Alabama law.

Where applicable, Contractor shall take out and maintain during the life of the contract insurance providing coverage as required by Federal statute, including but not limited to U.S. Longshoremen and Harborworkers' Compensation Act (USL&H), Jones Act, and Railroad Federal Employers Liability Act (FELA).

Professional Liability

The Contractor shall take out and maintain during the life of the contract Professional Liability insurance including design with limits not less than \$1,000,000 per occurrence.


Alabama Port Authority Executive Staffing Chart

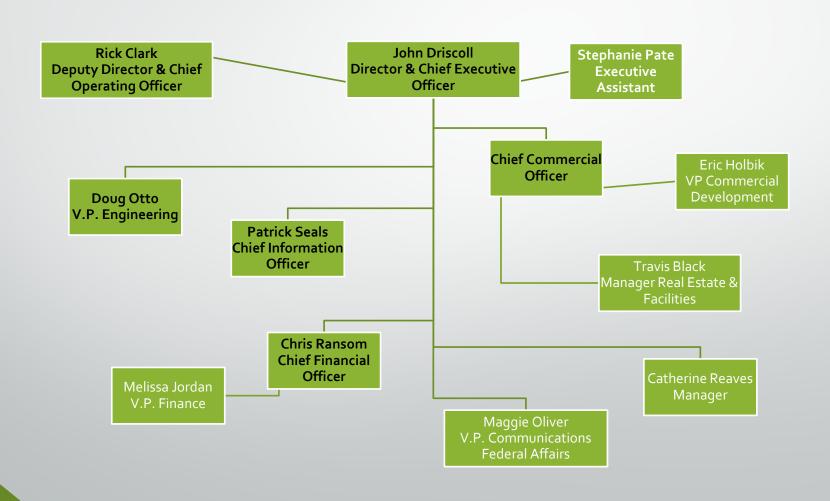


ALABAMA STATE PORT AUTHORITY 4th FLOOR INTERIOR - PHASE 1

250 N. WATER STREET

MOBILE, AL

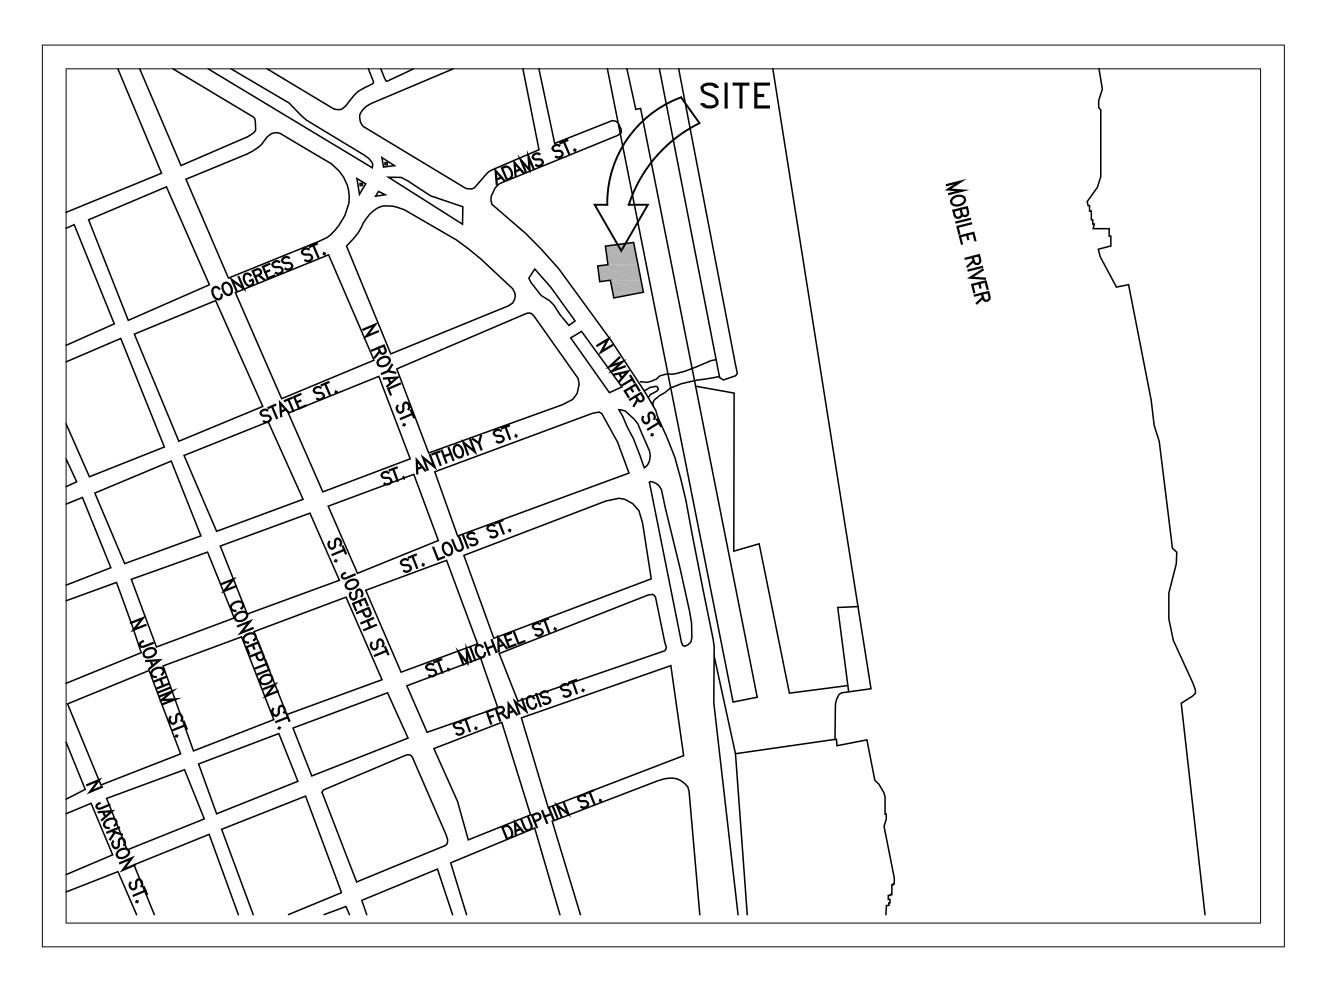


DRAWING INDEX						
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4th FLOOR INTERIOR - PHASE 1
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TITLE SHEET

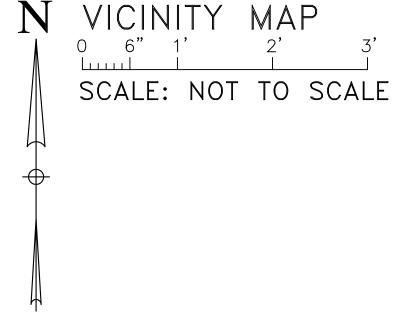PROJECT NO. 2024-01

DATE JUNE 6, 2024

SHEET NO.

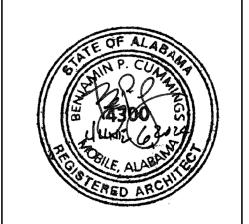T

<u>DEMOLITION NOTES</u>

- D1 WORK TO CONCRETE SLAB IN AREAS THAT ARE SHADED:
- REMOVE THE MUD BED TO EXPOSE THE CONCRETE SLAB. CLEAN THE CONCRETE SLAB.
- REMOVE OR RELOCATE OLD PLUMBING SUPPLY AND WASTE LINES AS DIRECTED ON THE PLUMBING PLANS.
- "BLIND OFF" ALL PENETRATIONS THROUGH THE SLAB. APPLY PRIMER TO SLAB.
- INSTALL MAPEI, SELF-LEVELER PLUS (OR EQUAL) SELF-LEVELING UNDERLAYMENT. INSTALL PER MANUFACTURERS
- INSTRUCTIONS. FILL RECESS UP TO LEVEL OF ADJACENT SLAB. (NOTE: IN RESTROOM WHERE HARD TILE IS STILL PRESENT, REMOVE THE TILE.)
- D2 FULLY REMOVE THIS STEEL FRAME.
- D3 (not used)
- D4 REMOVE THE CERAMIC TILE BLOCK FROM BETWEEN THE COLUMNS.
- D5 REMOVE CERAMIC TILE FROM THIS WALL.
- D6 SEE MECHANICAL PLANS FOR THE MODIFICATIONS TO THE HVAC
- D7 REMOVE THE BLACK TILE FROM THE AREA THAT IS SHADED, SAW LOBBY SHALL REMAIN.
- FOR SIZE.

D9 REMOVE DOOR AND FRAME.

D10 COMPLETELY GUT THIS RESTROOM: REMOVE TOILETS AND SINK. ALTER SUPPLY AND DRAIN LINES

AS SHOWN ON THE PLUMBING PLANS.

 REMOVE THE TOILET PARTITIONS. REMOVE THE LAVATORY COUNTER AND OTHER COUNTER.


 REMOVE MIRRORS AND ACCESSORIES. REMOVE THE CARPET AND BASE.

REMOVE THE CERAMIC TILE.

 REMOVE THE SUSPENDED CEILING SYSTEM. REMOVE THE PLASTER CEILING.

REMOVE WALLS THAT ARE DASHED.

 REMOVE LIGHTS AND RECEPTACLES AND SWITCHES AND ASSOCIATED CONDUIT. REMOVE CIRCUITS BACK TO SOURCE.

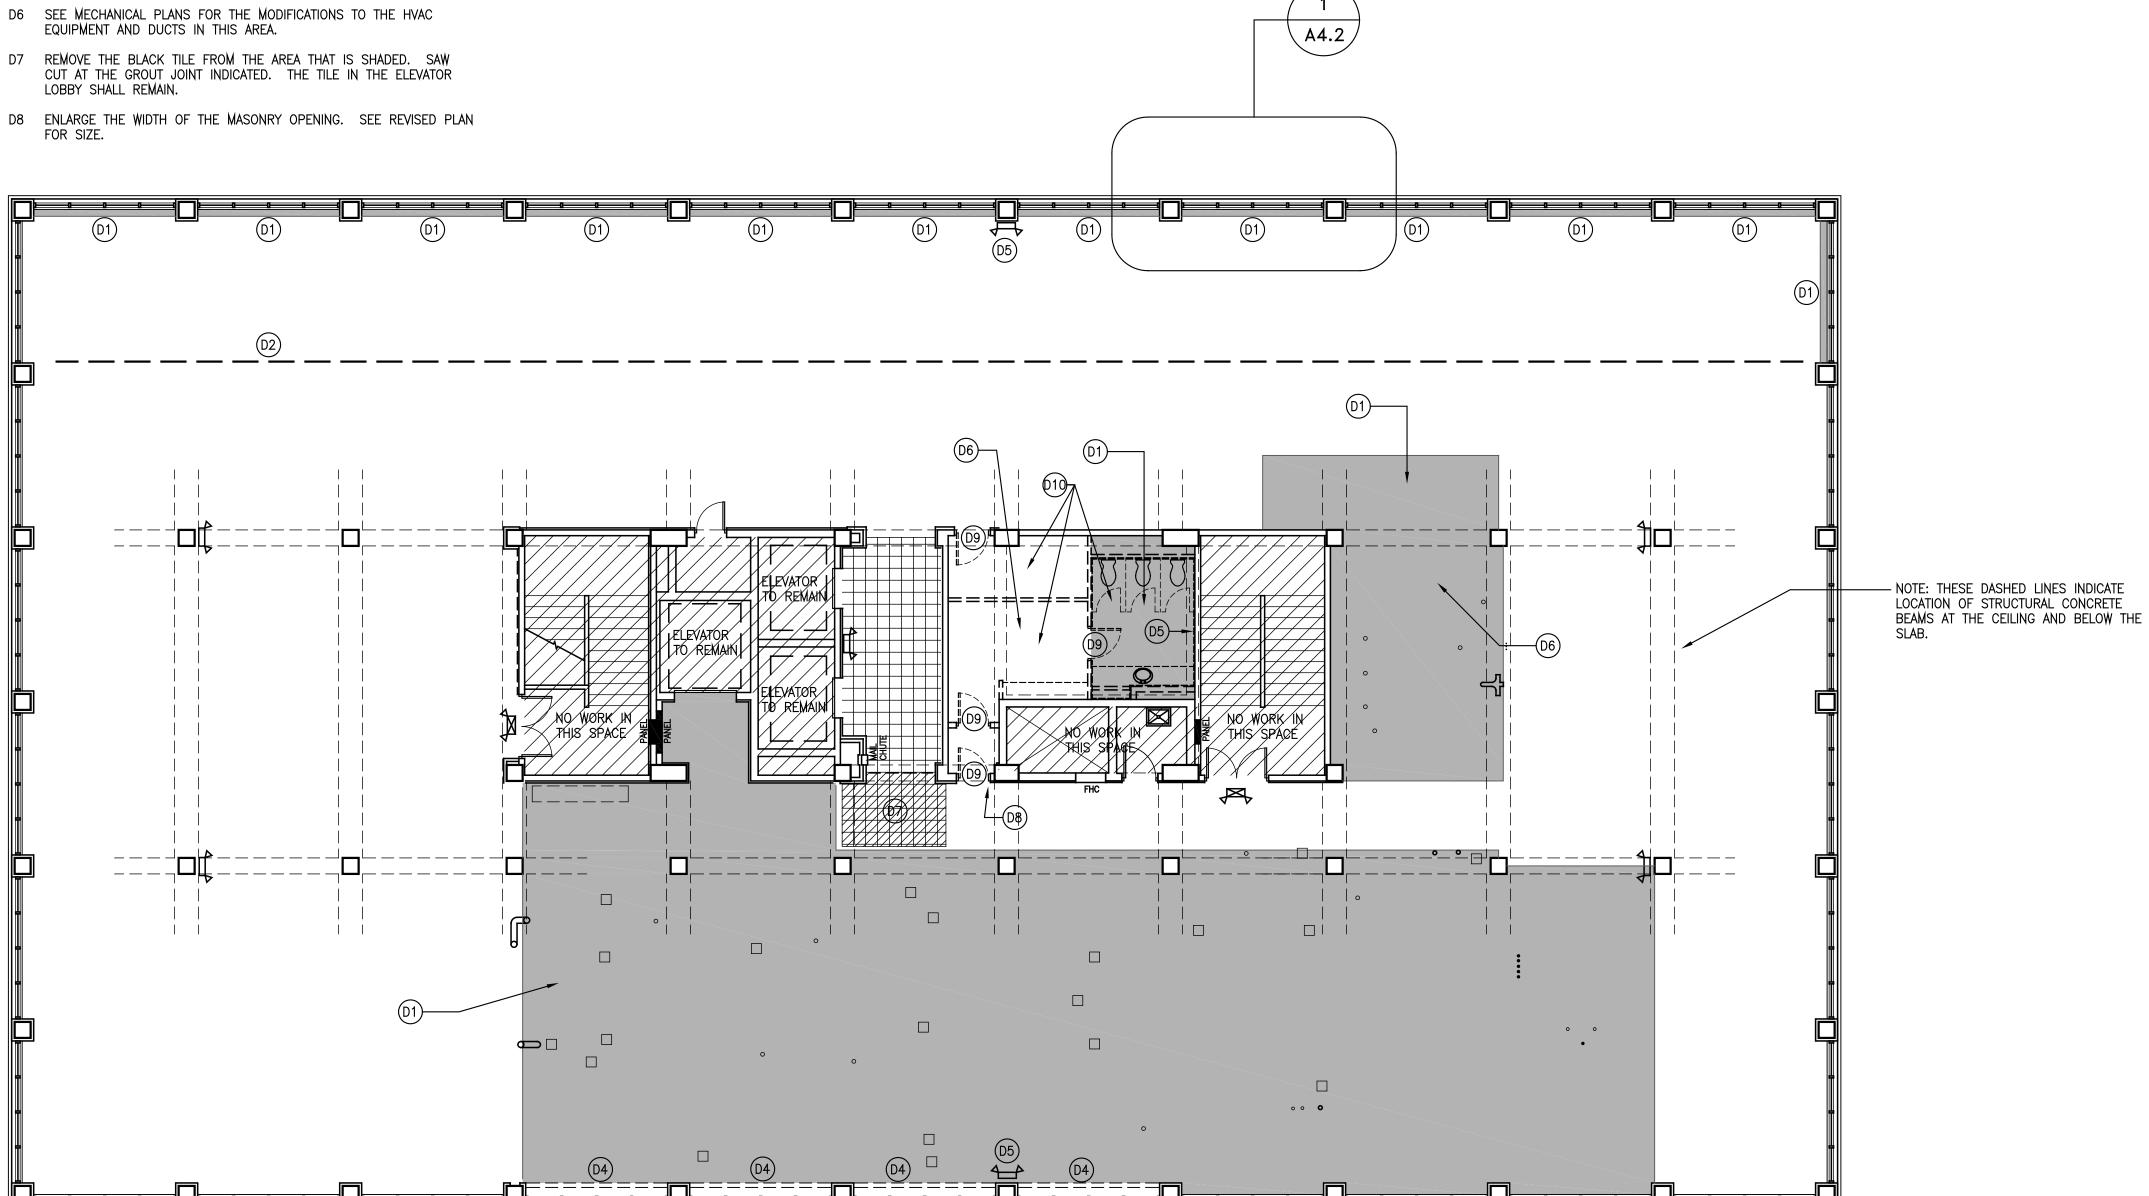



4TH FLOOR PLAN — DEMOLITION


O 4' 8' 12' 16' 20' 24'

SCALE: 1/8" = 1'-0"

CUMMINGS ARCHITECTURE

One Houston Street Mobile, Alabama 36606

TEL 251.433.9600

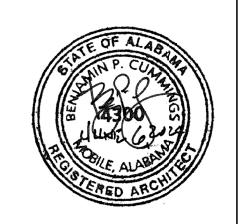

AUTHORITY
- PHASE 1
STREET PORT / TERIOR TER (ATE I ST/ OR FLO 4th 25

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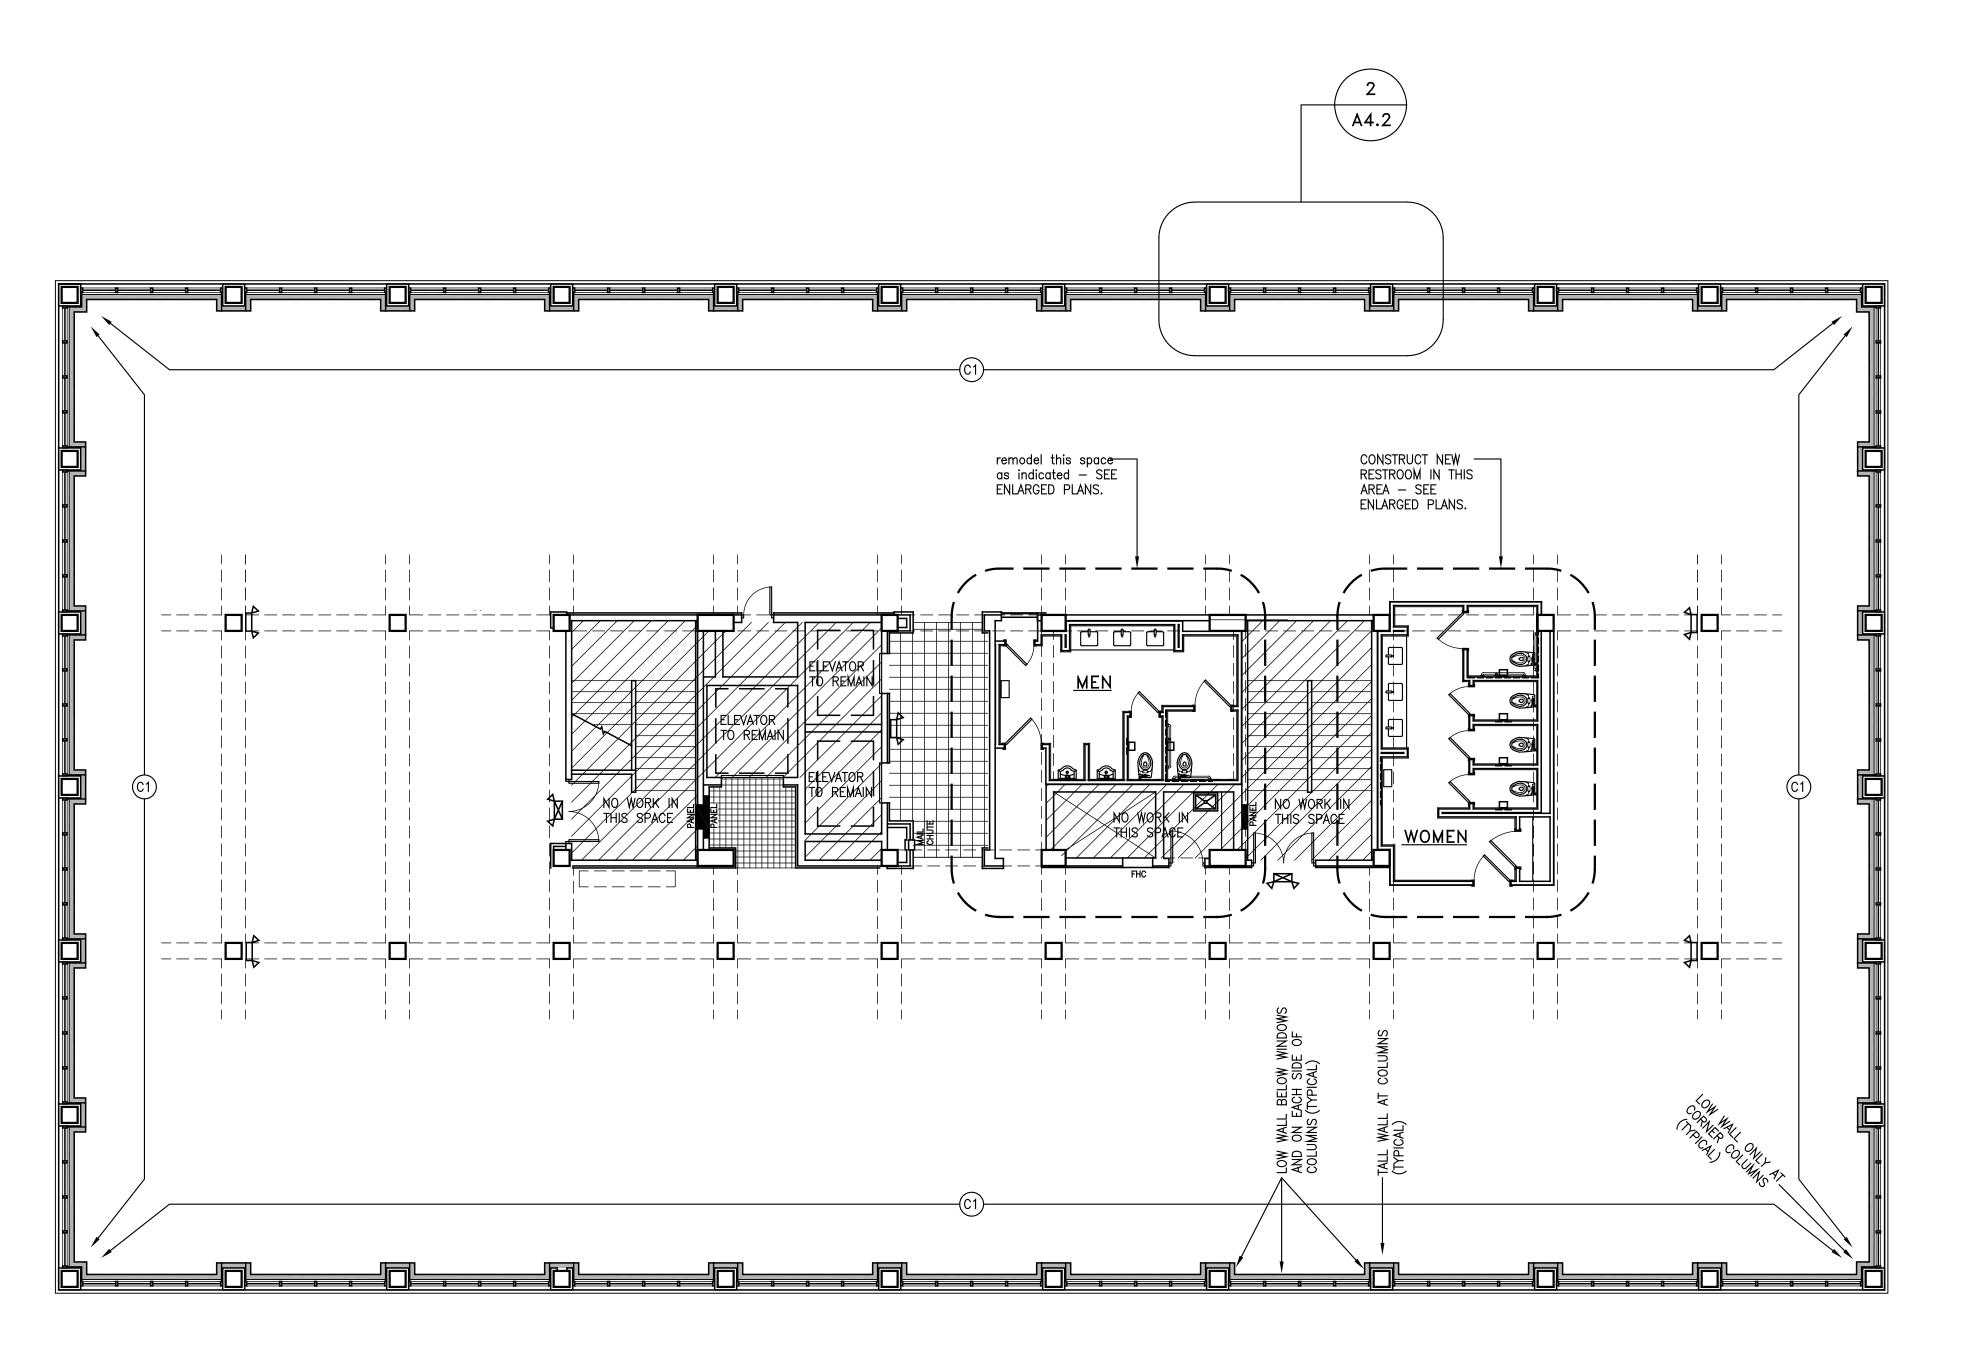
4th FLOOR PLAN - DEMOLITION


PROJECT NO. 2024-01

DATE JUNE 6, 2024


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4th FLOOR INTERIOR - PHASE 1
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4th FLOOR


PLAN - NEW WORK

PROJECT NO. 2024-01

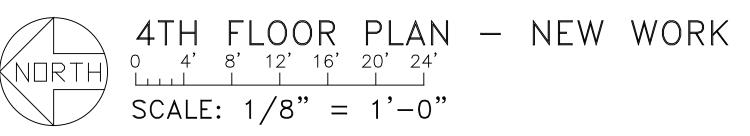
DATE JUNE 6, 2024

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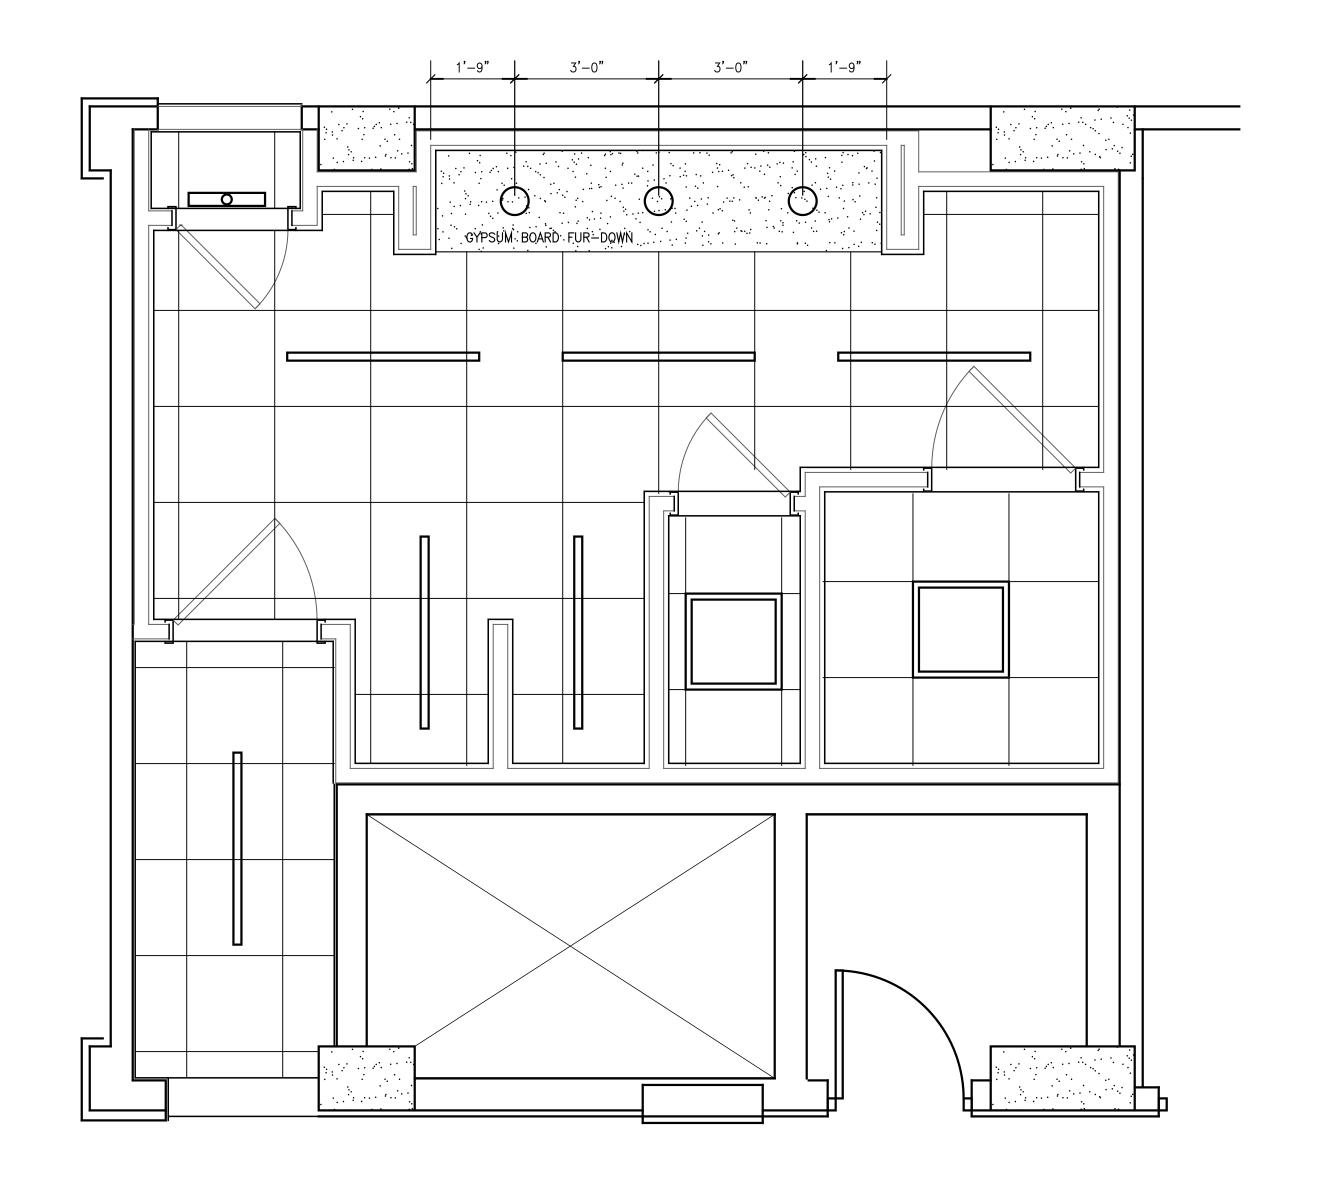
RESTROOM PLANS

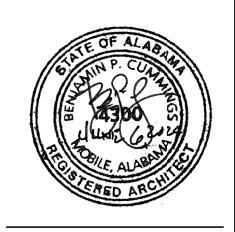
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DATE
JUNE 6, 2024
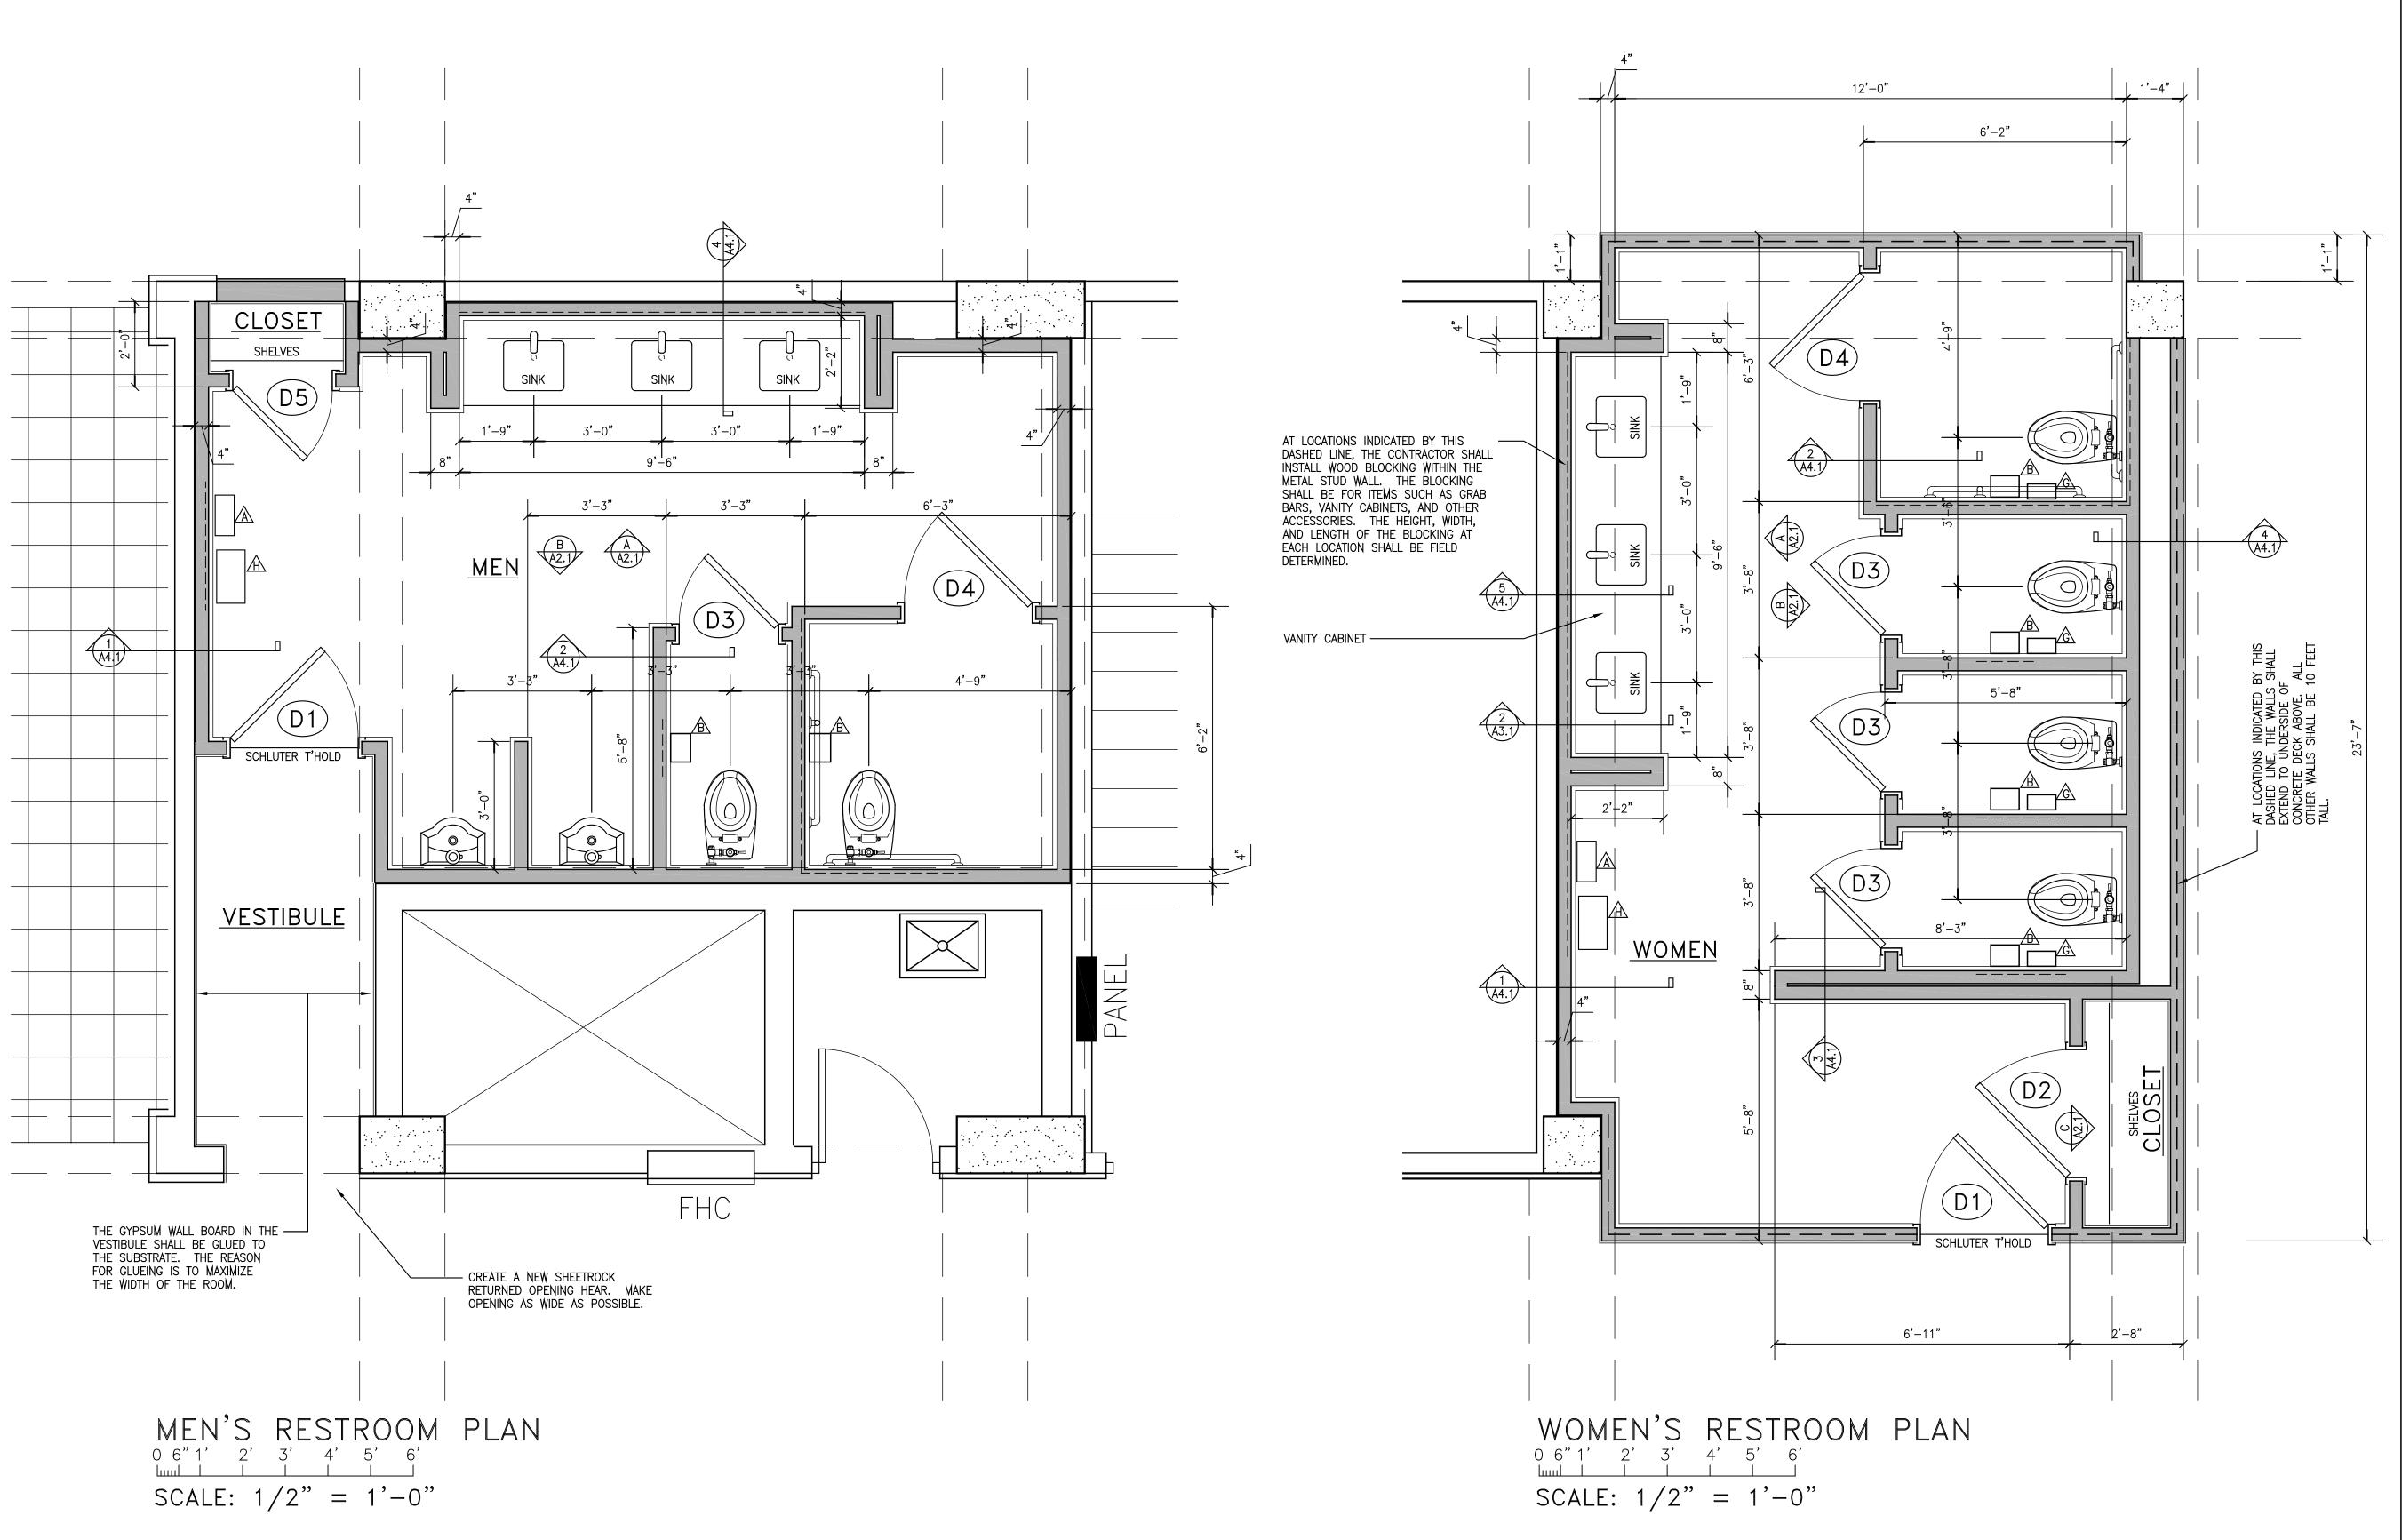
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A1.3



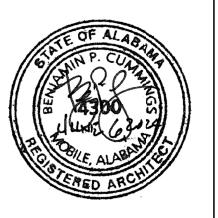

MEN'S REFLECTED CEILING PLAN

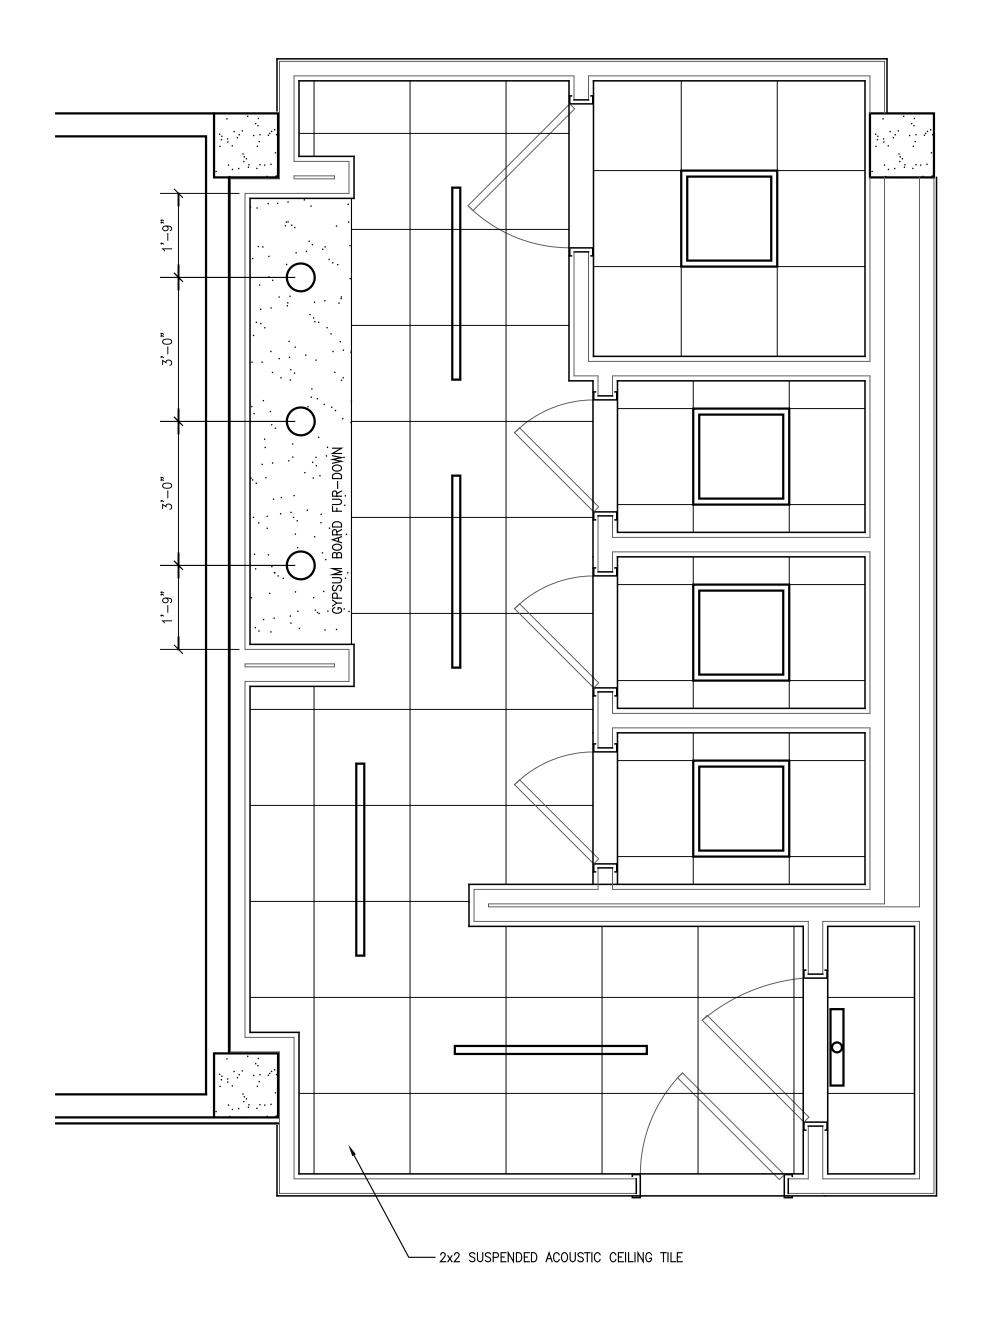0 6" 1' 2' 3' 4' 5' 6'

SCALE: 1/2" = 1'-0"


WOMEN'S REFLECTED CEILING PLAN

0 6" 1' 2' 3' 4' 5' 6'

SCALE: 1/2" = 1'-0"



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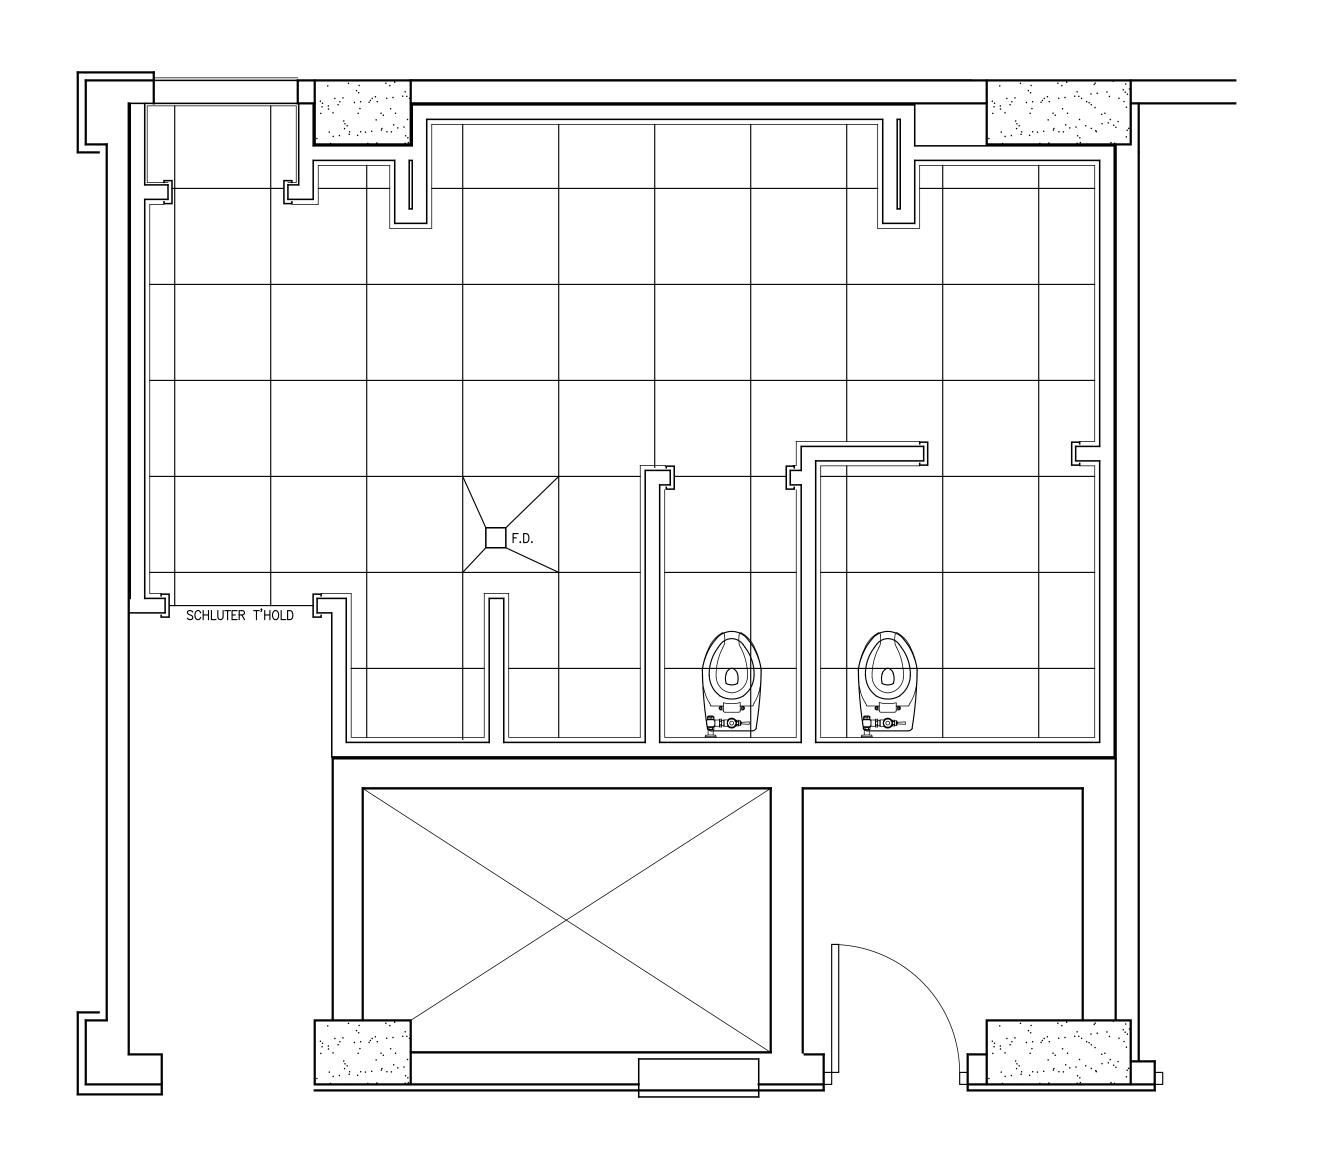
REFLECTED CEILING PLAN

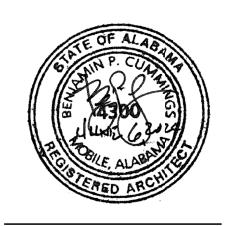
PROJECT NO. 2024-01

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A1.4





NOTE: EXCEPT FOR THE TOILET STALLS, THE 2x2 FLOOR TILE GRID PATTERN SHALL MATCH THE GRID PATTERN OF THE CEILING.

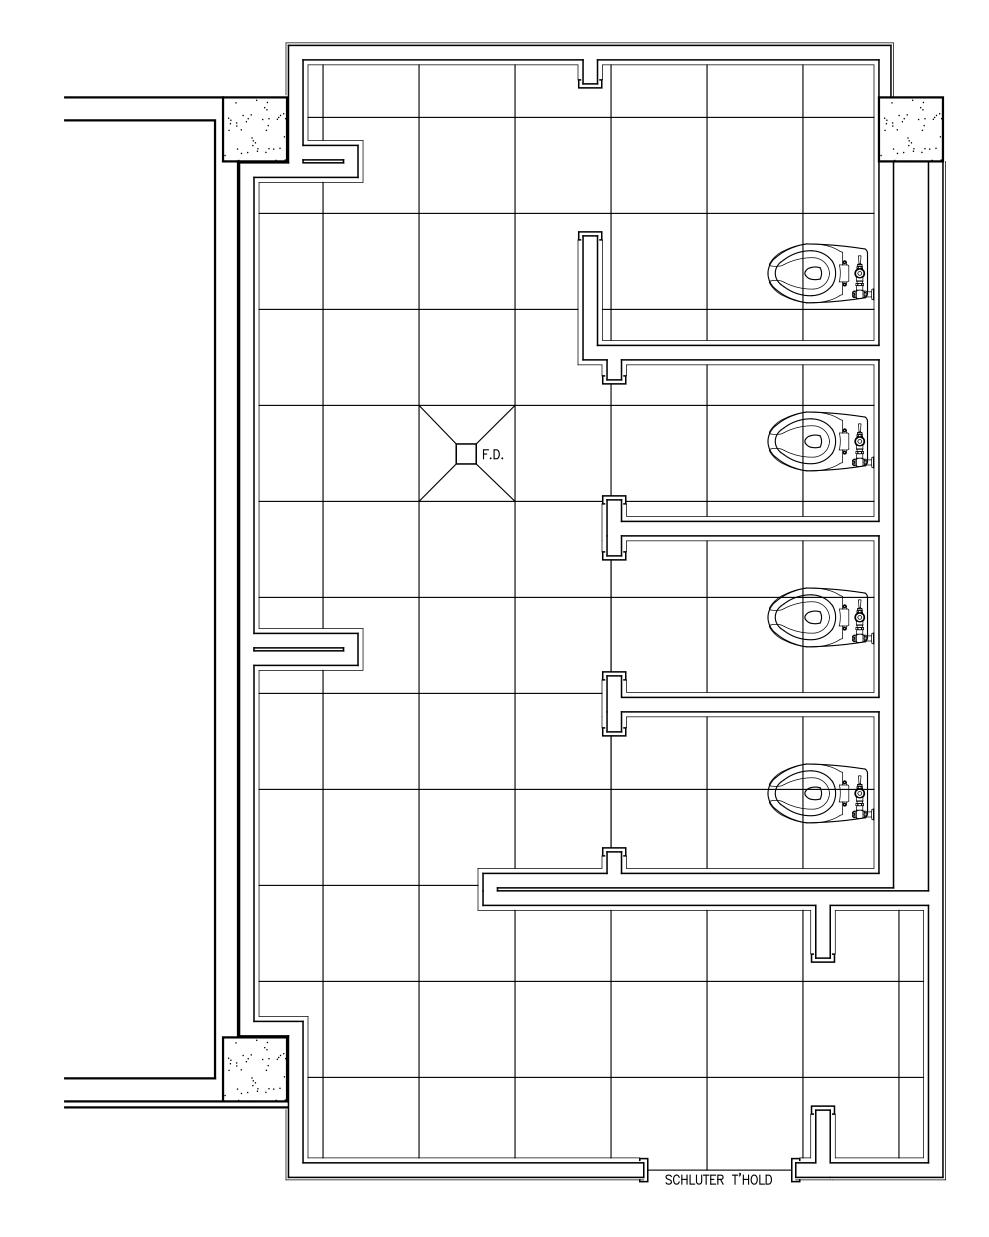NOTE: THE JOINTS OF THE WALL TILES SHALL ALIGN WITH THE JOINTS IN THE FLOOR TILE AND THE CEILING GRID.

MEN'S FLOOR PATTERN PLAN

O 6" 1' 2' 3' 4' 5' 6'

SCALE: 1/2" = 1'-0"

WOMEN'S FLOOR PATTERN PLAN

O 6" 1' 2' 3' 4' 5' 6'

SCALE: 1/2" = 1'-0"



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4th FLOOR INTERIOR - PHASE 1
250 N. WATER STREET
MOBILE, AL

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FLOOR PATTERN PLAN


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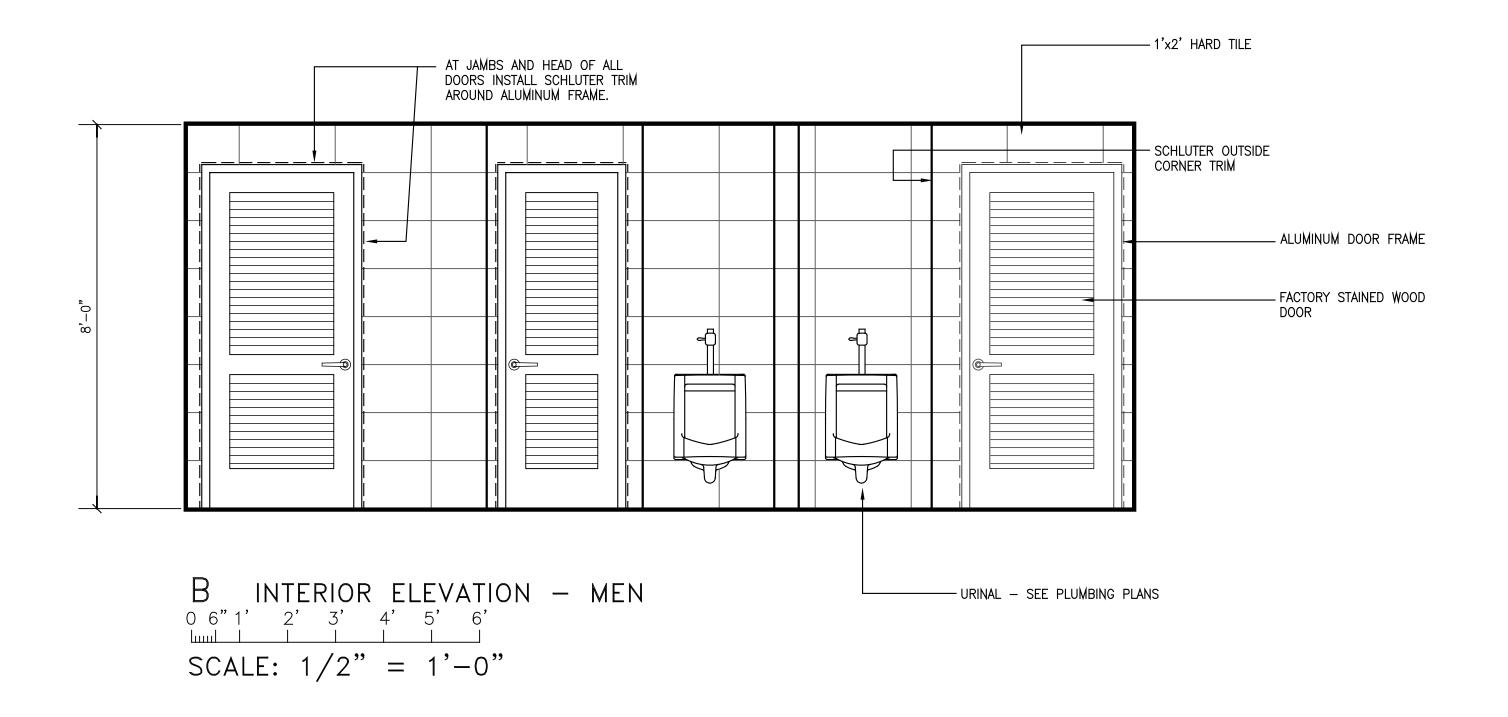
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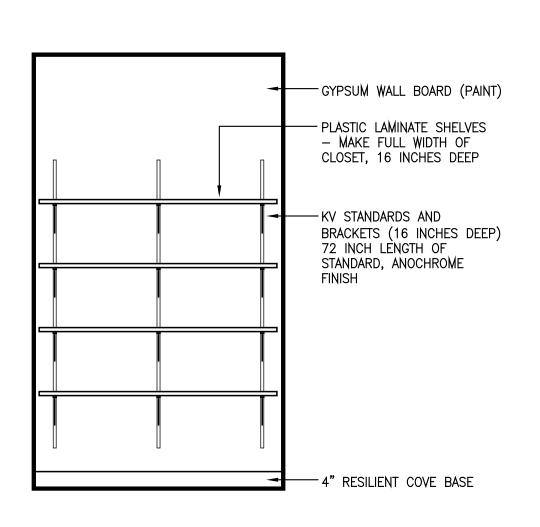
DATE JUNE 6, 2024

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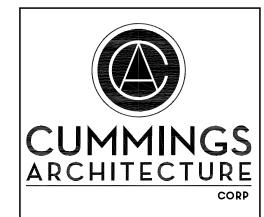
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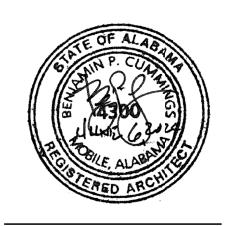


C	INTE	RIOR	El	LEV	ATION	_	CLOSETS
0 6"1	' 2'	3'	4'	5'	6'		
SCAI	_E: 1	/2"	=	1'	-0"		



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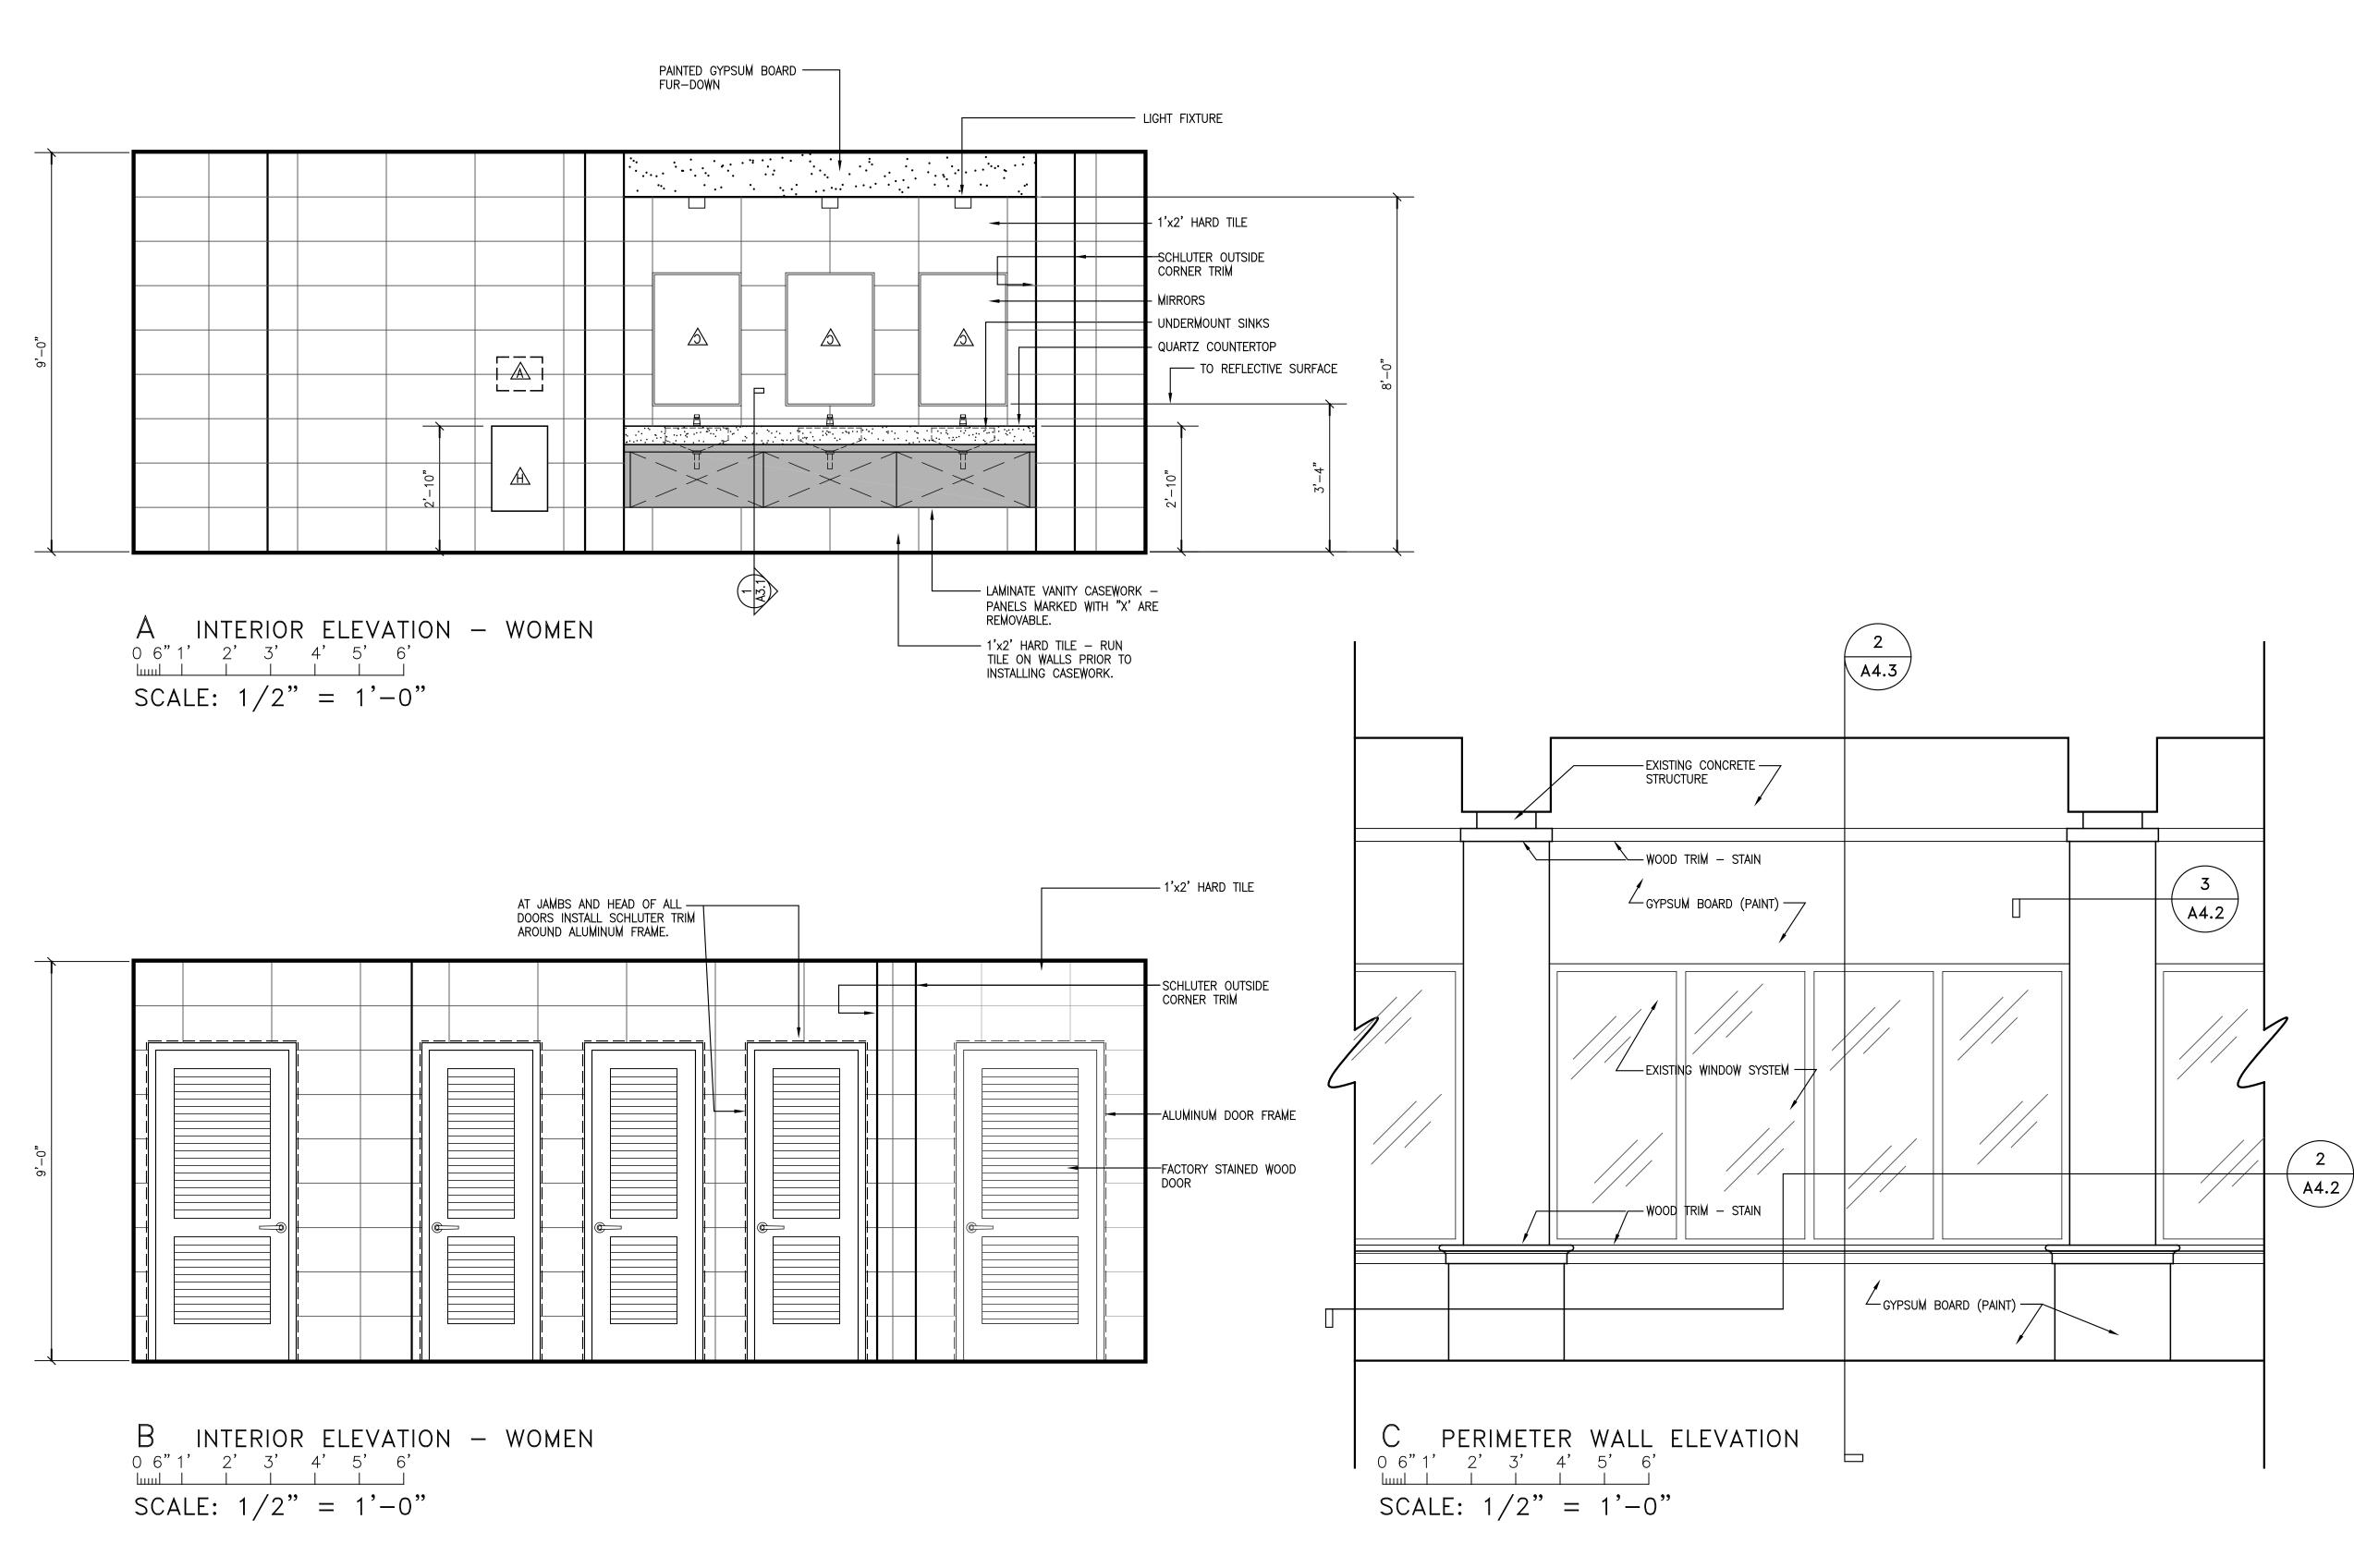
RESTROOM INTERIOR ELEVATIONS

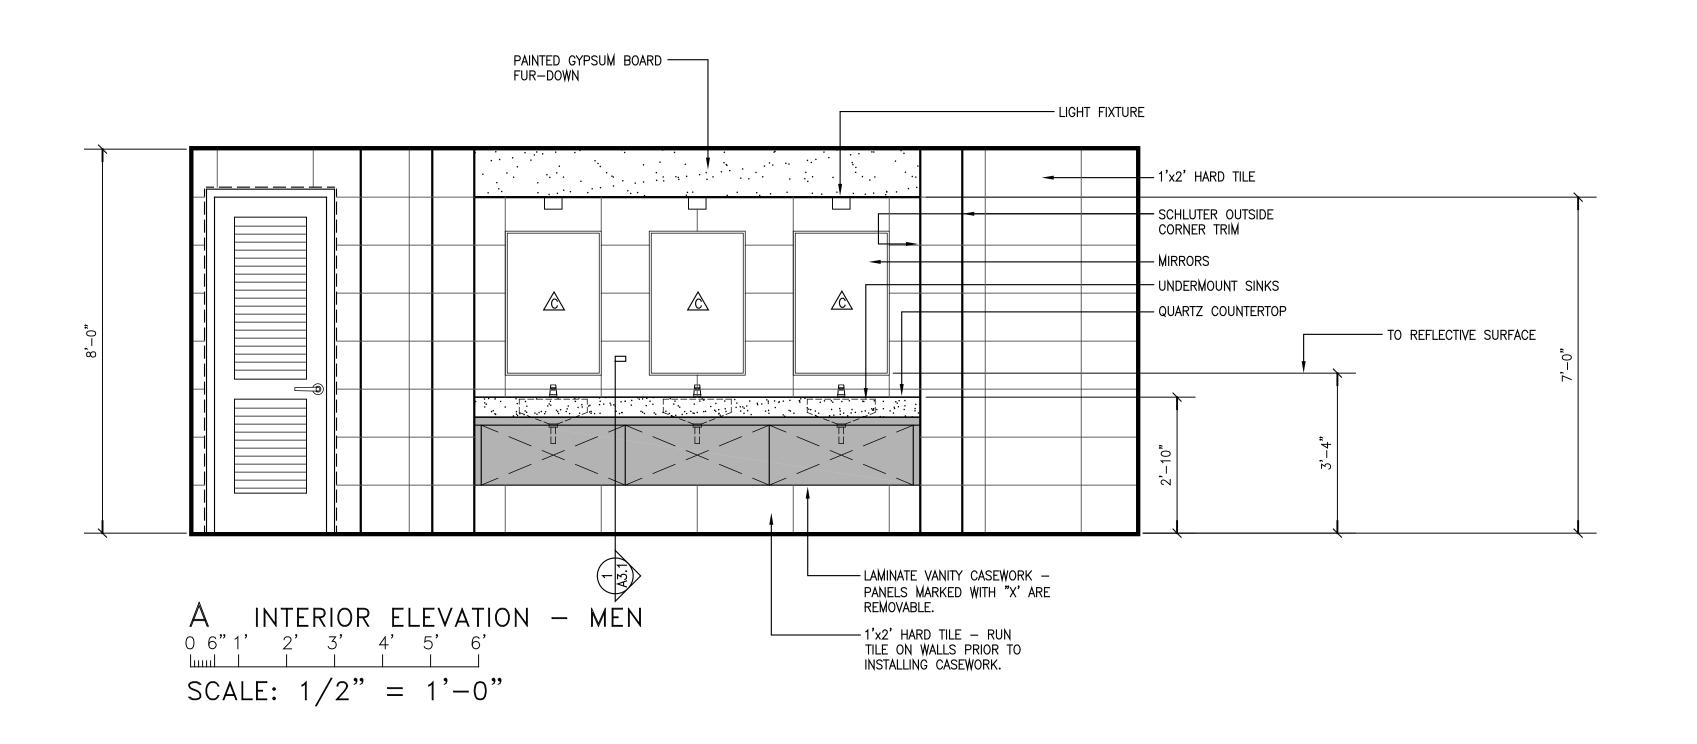PROJECT NO. 2024-01

DATE JUNE 6, 2024

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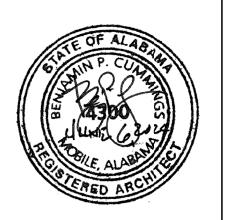
A2.1





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RESTROOM
INTERIOR

ELEVATIONS


PROJECT NO. 2024-01

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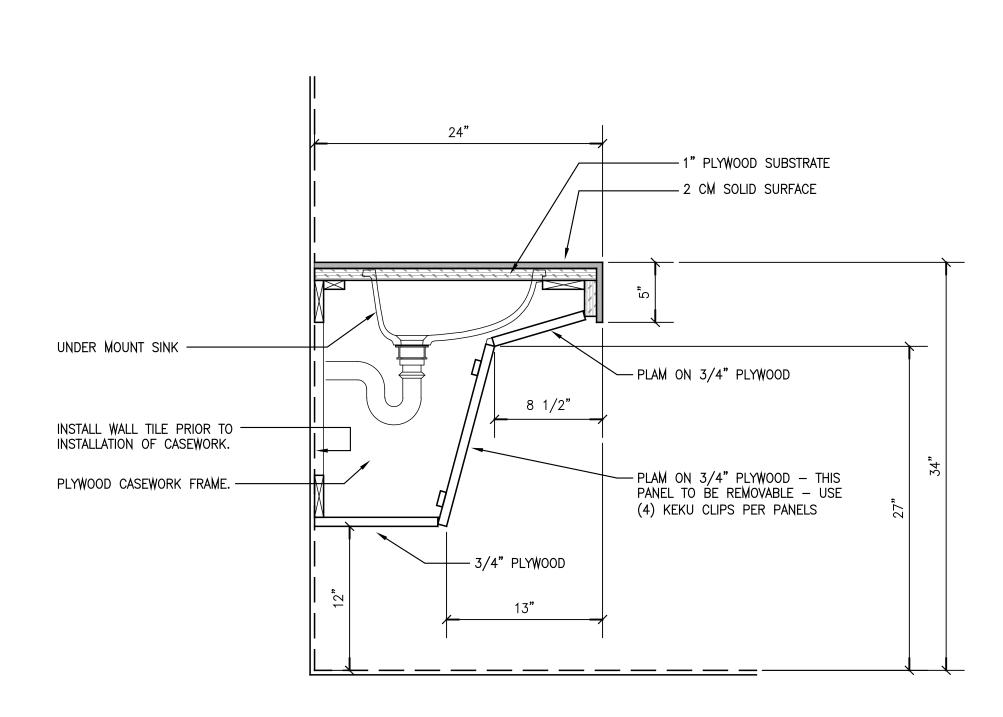
SHEET NO.

A2.2



WHEELCHAIR TOILET COMPARTMENT

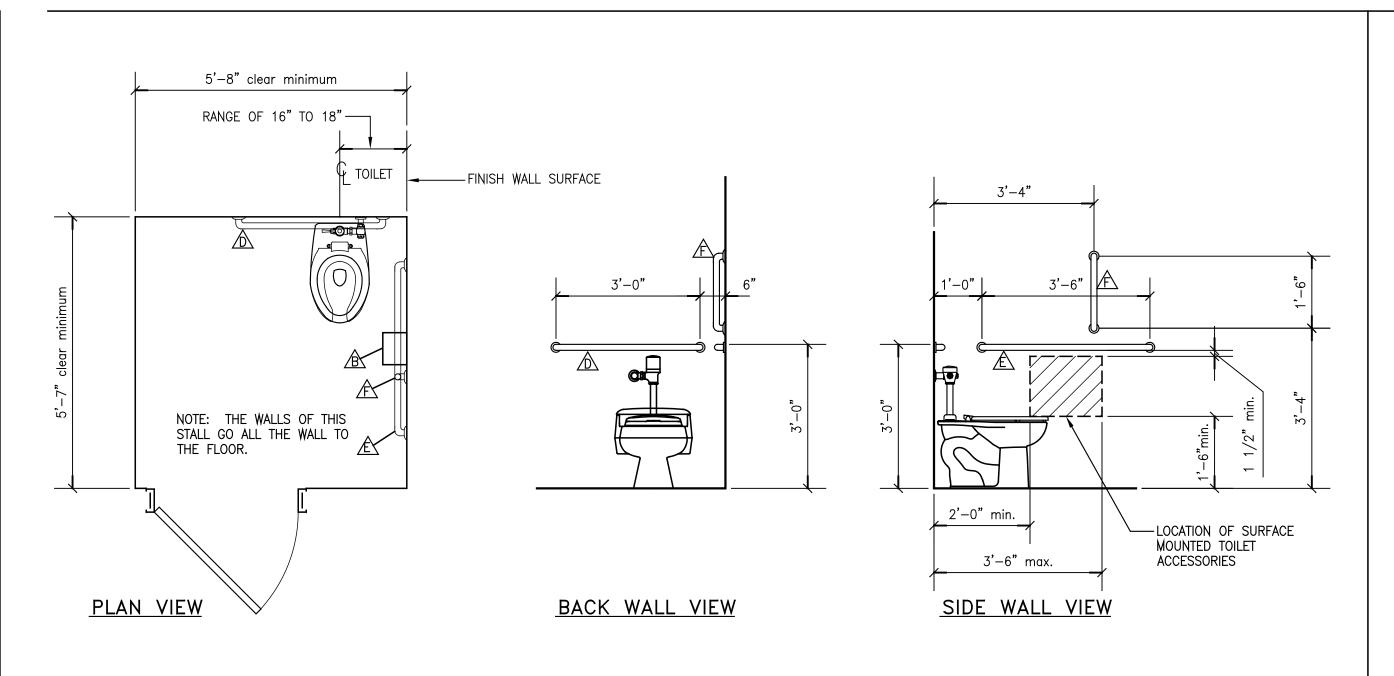SCALE: 1/2" = 1'-0"



2 <u>vanity detail</u>

SCALE: 1 1/2" = 1'-0"

ACCESSORY SCHEDULE MANUFACTURER KEY DESCRIPTION MODEL NUMBER FURNISHED AND PAPER TOWEL DISPENSER INSTALLED BY OWNER FURNISHED AND TOILET TISSUE DISPENSER INSTALLED BY OWNER MIRROR BOBRICK B-165 2436 36" GRAB BAR — STAINLESS STEEL BOBRICK B-5806-36 42" GRAB BAR – STAINLESS STEEL BOBRICK B-5806-42 18" GRAB BAR – STAINLESS STEEL B-5806-18 BOBRICK SANITARY NAPKIN DISPOSAL BOBRICK B - 270 SURFACE MOUNTED WASTE RECETACLE BOBRICK B - 277

FINISH SCHEDULE

HARD TILE (IN RESTROOMS, TOILET STALLS, AND CLOSETS)

• 24" x 24" HARD TILE: BPI — MILESTONE STONE, FARMHOUSE LIVING, ALABASTER MATTE INSTALL NEW TILE USING SCHLUTER WATERPROOFING SYSTEM. INSTALL SCHLUTER DITRA ONTO SLAB. FLASH TO

WALL USING KERDI BAND STRIPS. INSTALL PER MANUFACTURERS INSTRUCTIONS. USE BOSTIK BIG TILE & STONE POLYMER-MODIFIED LARGE & HEAVY TILE MORTAR. APPLY PER MANUFACTURERS INSTRUCTIONS.

• FLOOR TILE AND WALL TILE GROUT LINES SHALL ALIGN. FLOOR PATTERN SHALL MATCH THE CEILING TILE PATTERN, MEANING THAT THE SQUARE PATTERN AT THE CEILING AND THE SQUARE PATTERN AT THE FLOOR

SHALL BE THE SAME. GROUT JOINT LINES TO BE 1/8".

GROUT SHALL BE BOSTIK 1900 EPOXY MODIFIED GROUT, COLOR: STORM H198

<u>WALLS</u>

HARD TILE (IN MEN AND WOMEN RESTROOMS AND STALLS)

12" x 24" HARD TILE: <u>BPI -MILESTONE STONE</u>, <u>FARMHOUSE LIVING</u>, <u>ALABASTER MATTE</u>
 INSTALL NEW TILE USING SCHLUTER WATERPROOFING SYSTEM. INSTALL SCHLUTER KERDI PRODUCT OVER

MOISTURE RESISTANT GYPSUM WALL BOARD. FLASH KERDI TO FLOOR USING KERDI BAND STRIPS. INSTALL PER MANUFACTURERS INSTRUCTIONS. USE BOSTIK BIG TILE & STONE POLYMER-MODIFIED LARGE & HEAVY TILE

FLOOR TILE AND WALL TILE GROUT LINES SHALL ALIGN.

 GROUT JOINT LINES TO BE 1/8". GROUT SHALL BE BOSTIK 1900 EPOXY MODIFIED GROUT, COLOR: STORM H198

GYPSUM WALL BOARD (IN CLOSETS, FUR-DOWN ABOVE SINKS AND VESTIBULE) 5/8" MOISTURE RESISTANT GYPSUM WALL BOARD.

PRIME AND PAINT

 SHEEN: EGGSHELL COLOR: SHERWIN WILLIAMS, 6105 DIVINE WHITE

PROVIDE AND INSTALL SCHLUTER STAINLESS STEEL TRIM AT THE FOLLOWING LOCATIONS:

FLOOR TO WALL (BASE): SCHLUTER DILEX AHK 1S 100

 INSIDE CORNERS OF WALLS: SCHLUTER DILEX AHK 1S 100 OUTSIDE CORNERS OF WALLS AND END CAPS: SCHLUTER SCHIENE

 AROUND DOOR FRAMES: SCHLUTER SCHIENE PROVIDE INSIDE AND OUTSIDE CORNER TRIM PIECES.

CEILINGS (IN RESTROOMS AND CLOSETS)

2 x 2 ACOUSTIC SUSPENDED CEILING SYSTEM

• GRID: ARMSTRONG, PRELUDE XL 15/16", WHITE, 2x2

• TILE CEILINGS: ARMSTRONG, 2x2, DUNE, 15/16" ANGLED TEGULAR EDGE COORDINATE GRID LAYOUT WITH FLOOR TILE LAYOUT. THE CEILING GRID AND THE FLOOR TILE SHALL ALIGN.

RESILIENT BASE (IN CLOSETS ONLY) 4 INCH COVE BASE, JOHNSONITE, GREY HAZE WG

LAVATORY COUNTER (IN RESTROOMS)

COUNTERTOP AND BACKSPLASH: CORIAN QUARTZ, 2 CM THICK, VALENTE PEARL

SKIRT BELOW SINK: PLASTIC LAMINATE: FORMICA, NEUTRAL WHITE, 918-58 MATTE FINISH

<u>LAMINATE SHELVES</u> (IN CLOSETS)

PLASTIC LAMINATE: FORMÍCA, NEUTRAL WHITE, 918-58 MATTE FINISH



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AUTHORITY
- PHASE 1
STREET AMA STATE PORT A
FLOOR INTERIOR N WATER S **4th** | 25

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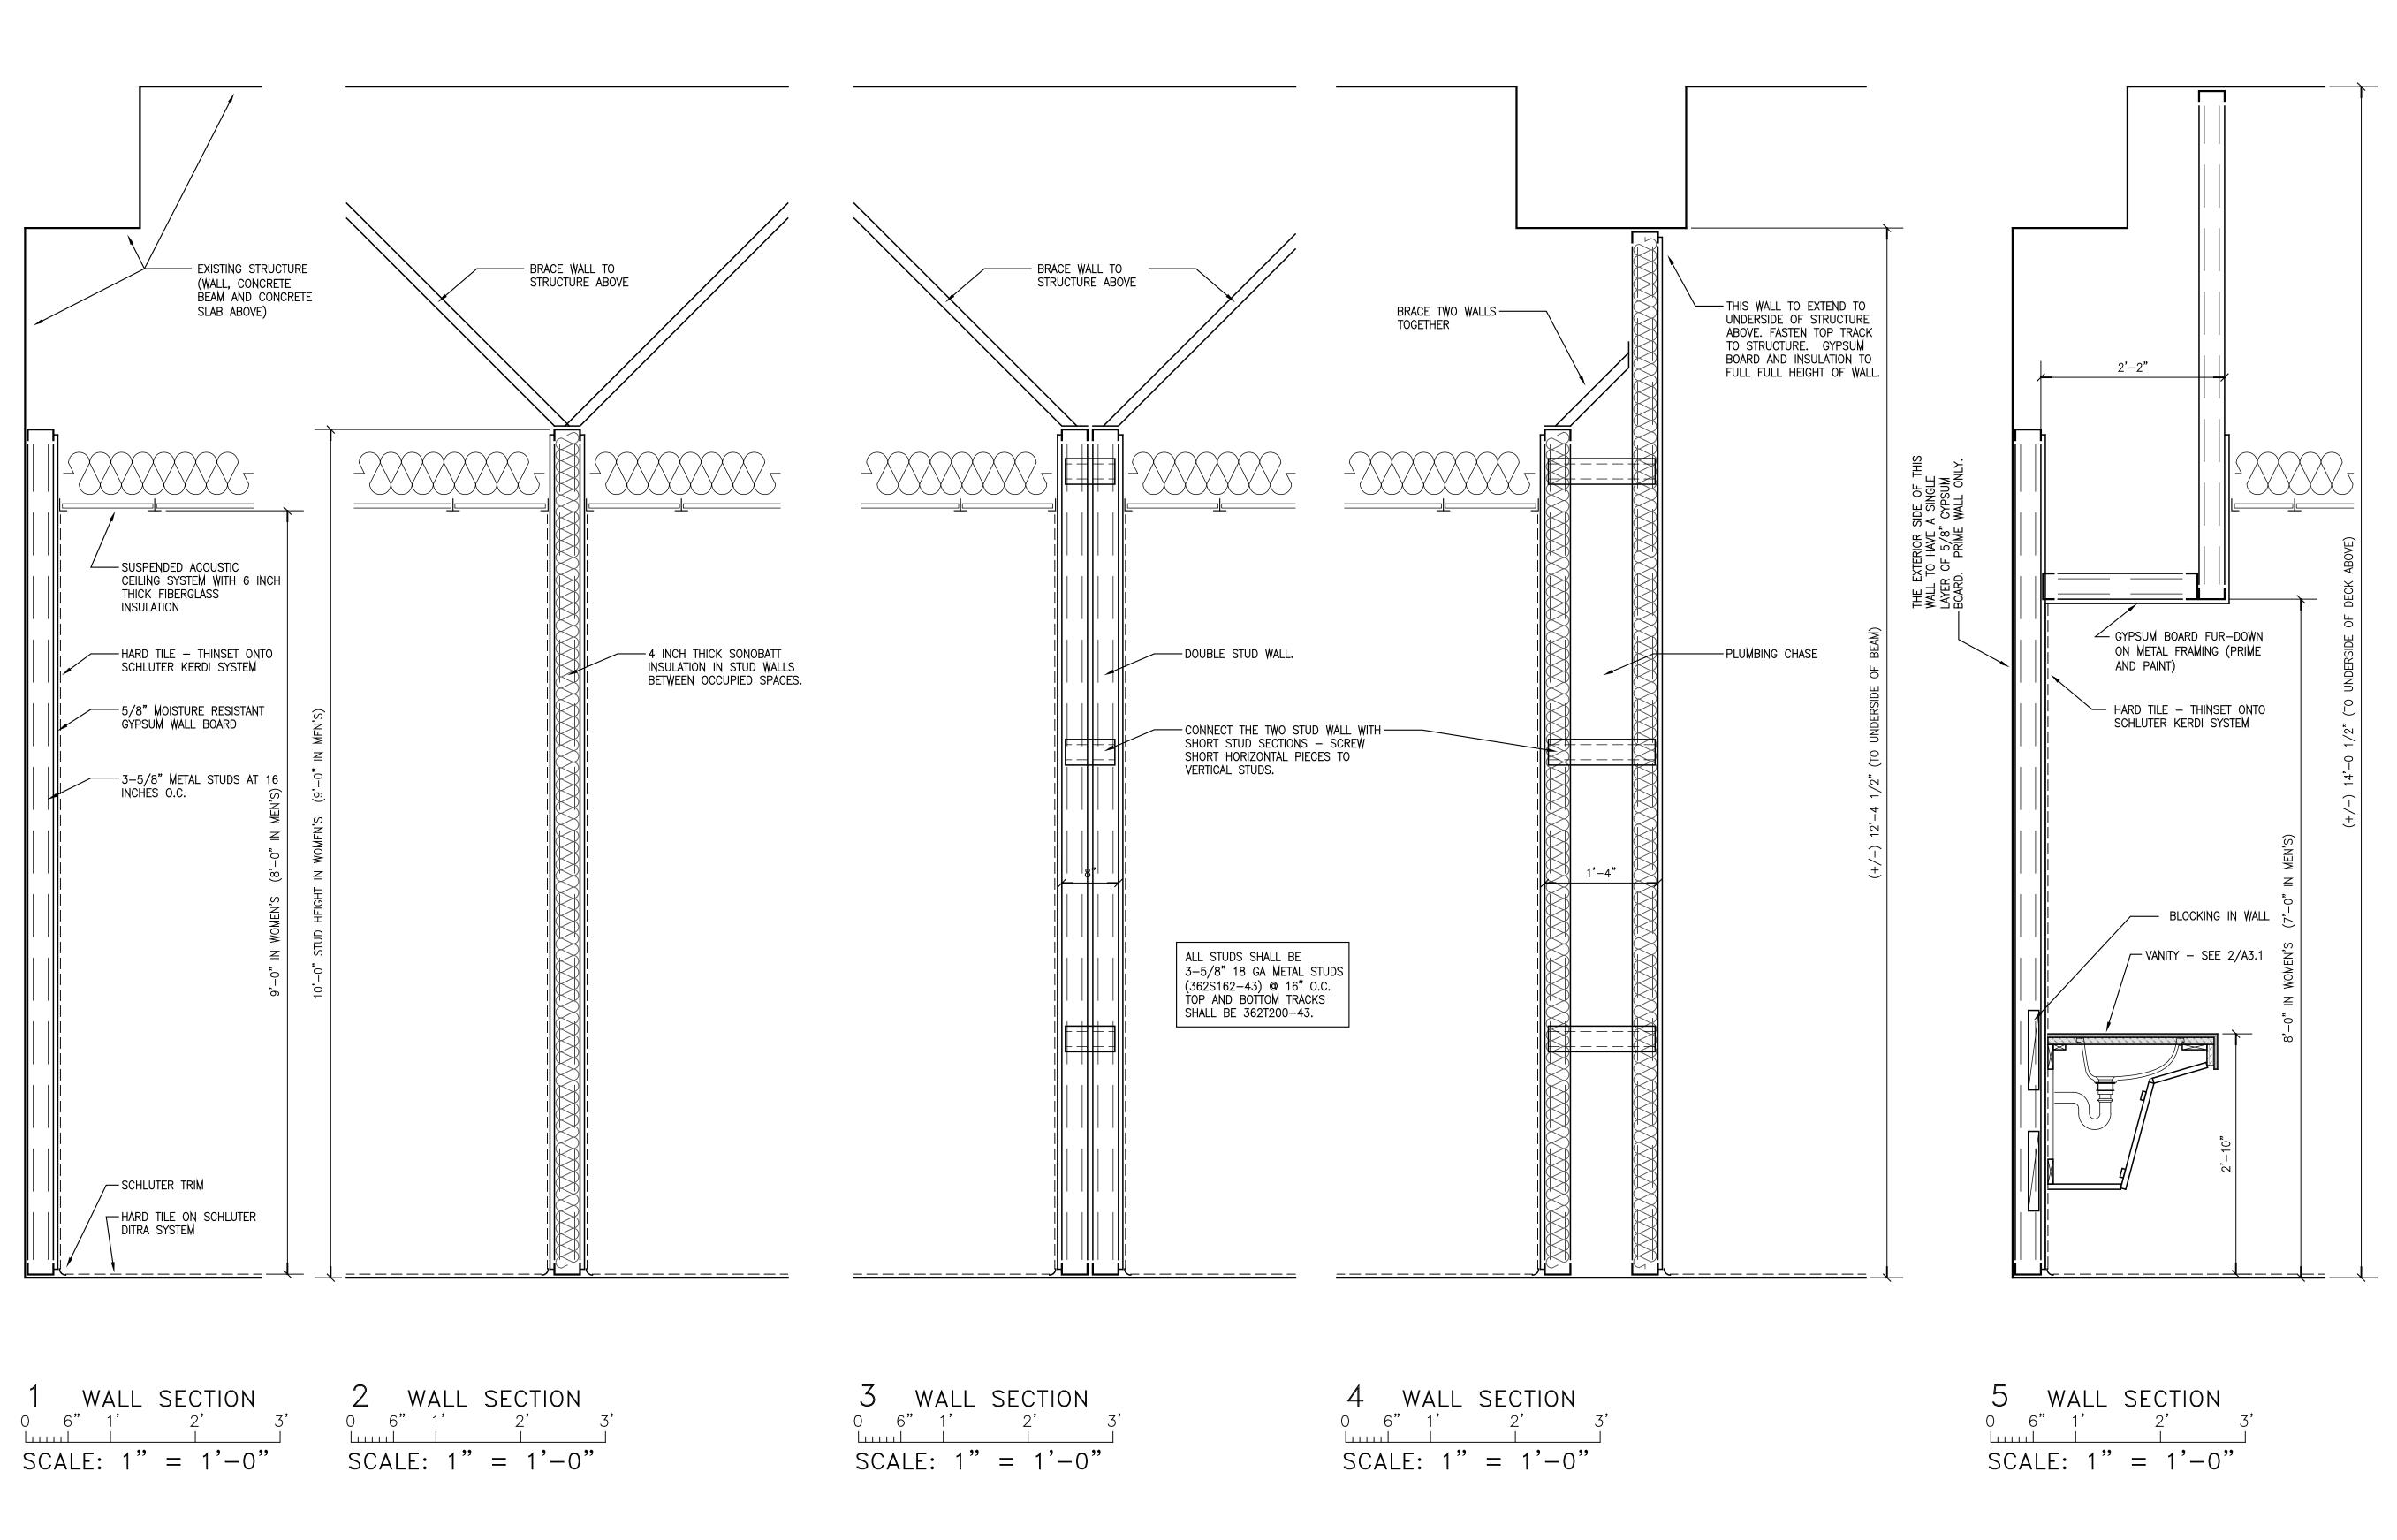
SHEET NAME

FINISH SCHEDULE and DETAILS

PROJECT NO. 2024-01

DATE JUNE 6, 2024

SHEET NO.








LABAMA STATE PORT AUTHORITY 4th FLOOR INTERIOR - PHASE 1 250 N. WATER STREET MOBILE, AL

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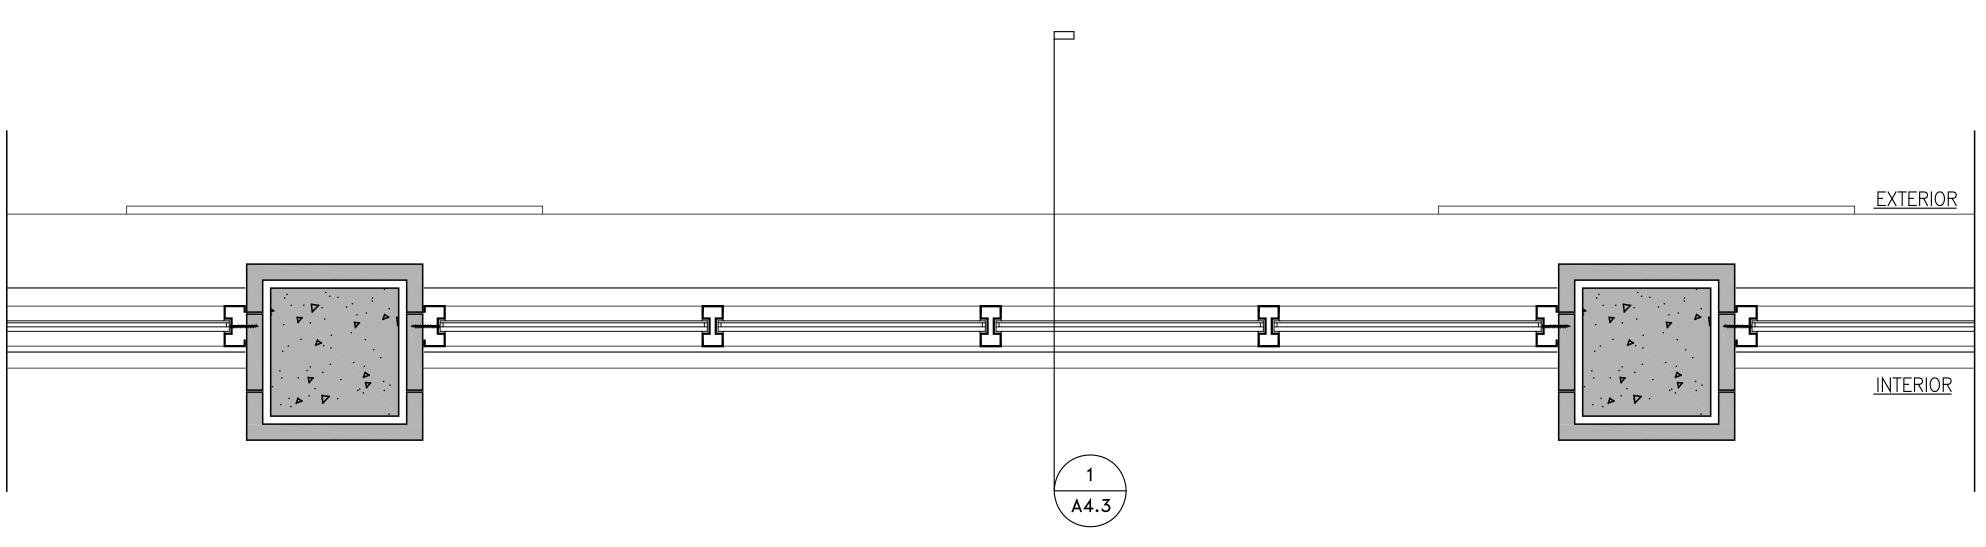
WALL SECTIONS

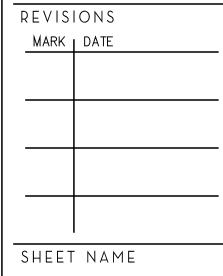
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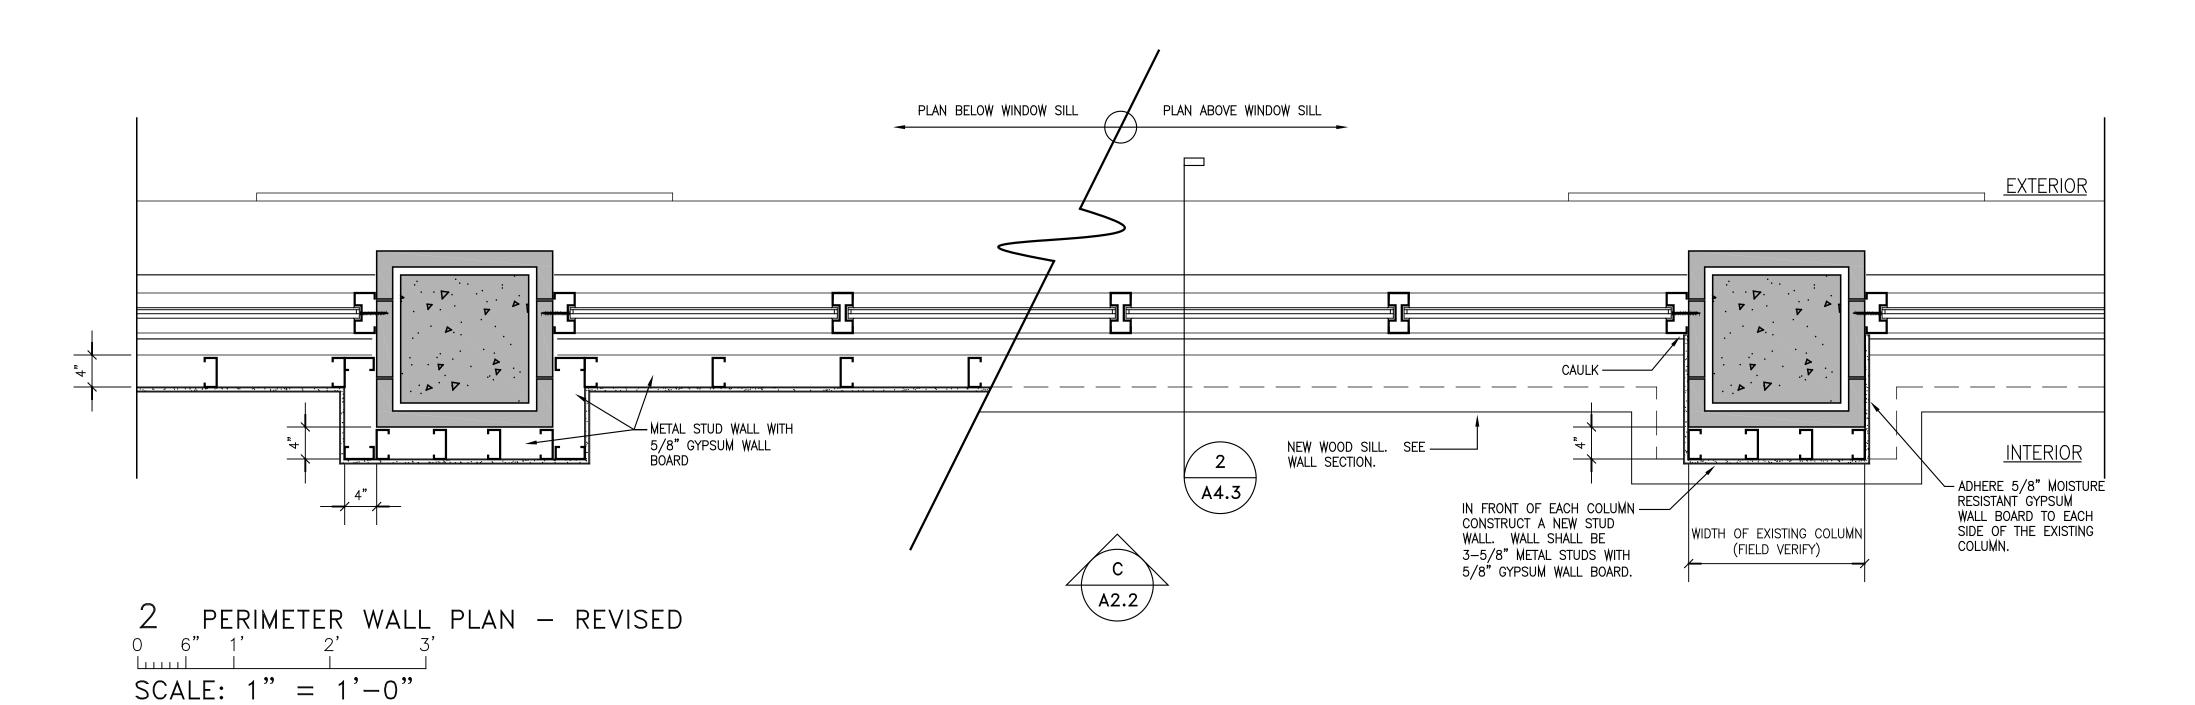
DATE JUNE 6, 2024


SHEET NO.

A4.1





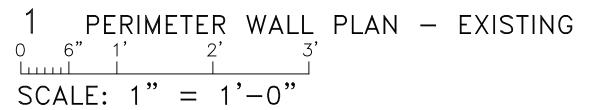

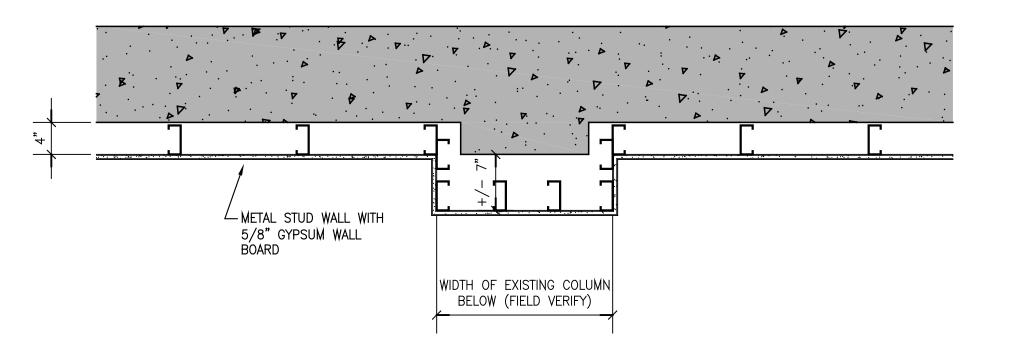

3 PERIMETER WALL PLAN — REVISED $\begin{bmatrix} 6^n & 1 & 2 & 3 \\ 1 & 1 & 2 & 3 \end{bmatrix}$ SCALE: 1" = 1'-0"





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4th FLOOR INTERIOR - PHASE 1
250 N. WATER STREET
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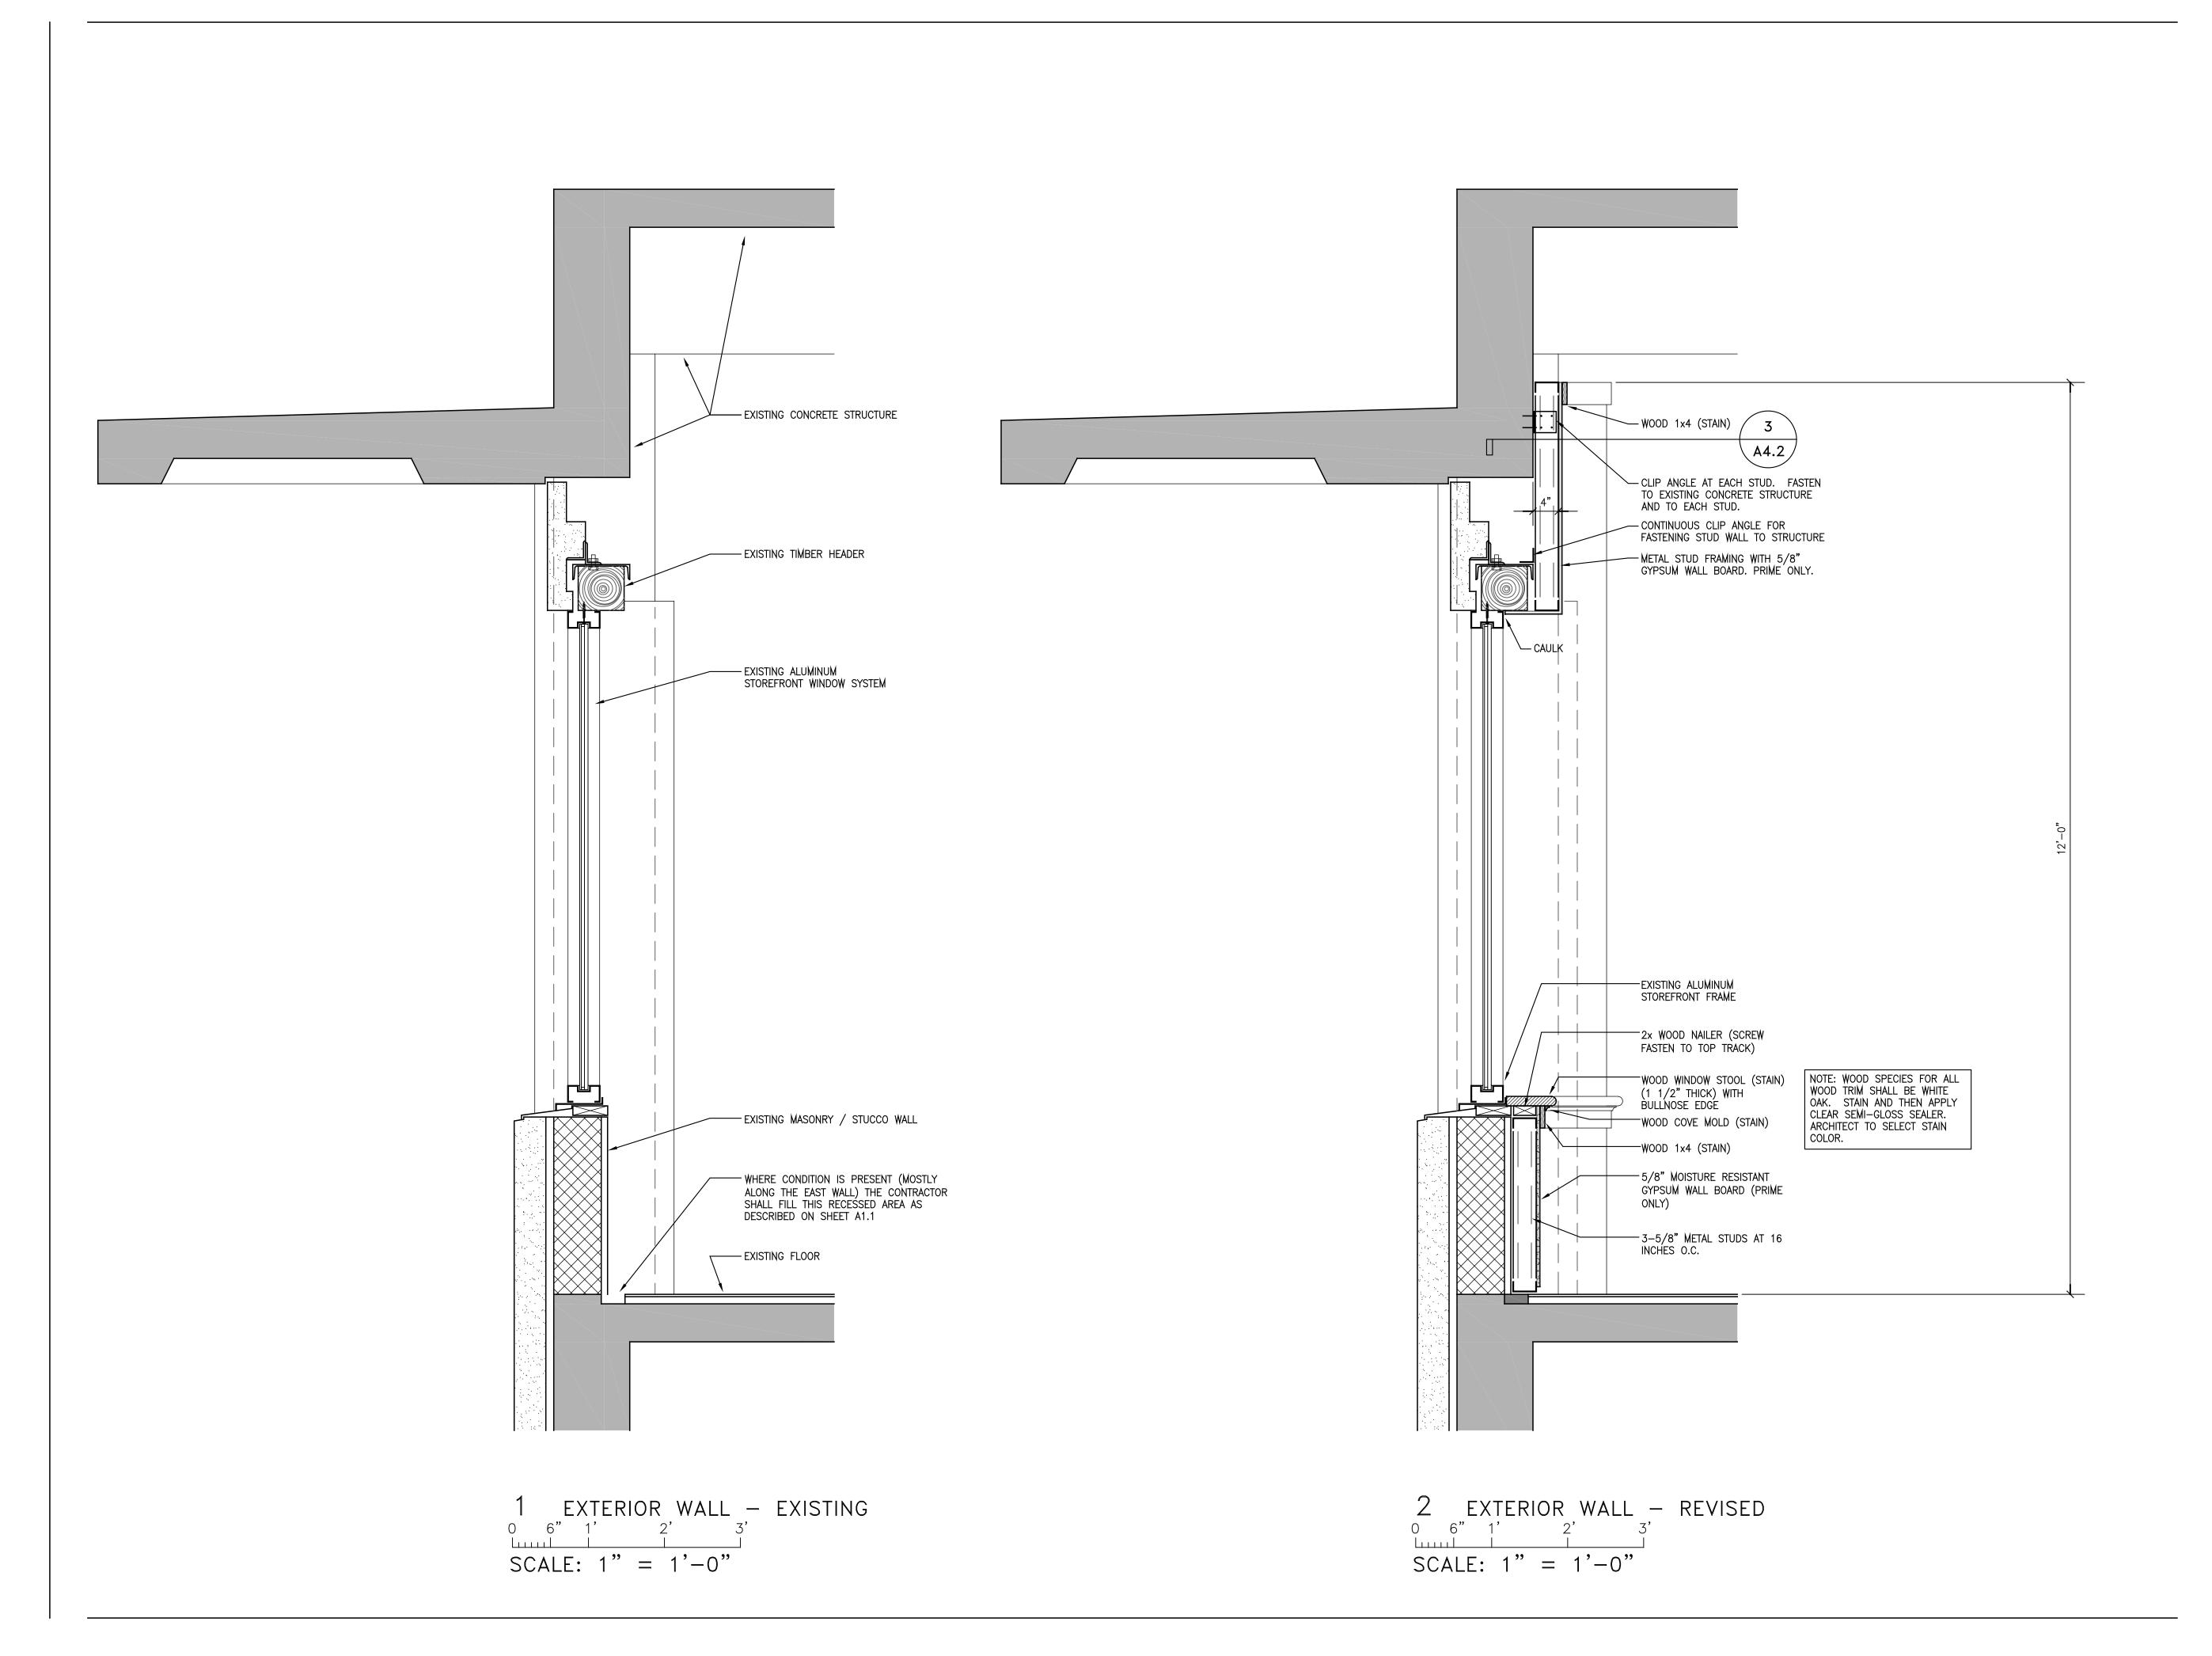
WALL SECTIONS

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WALL SECTIONS


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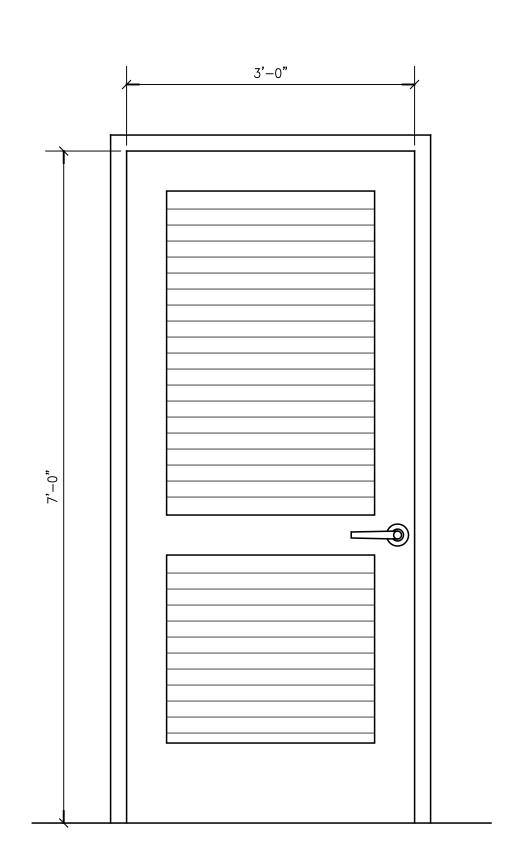
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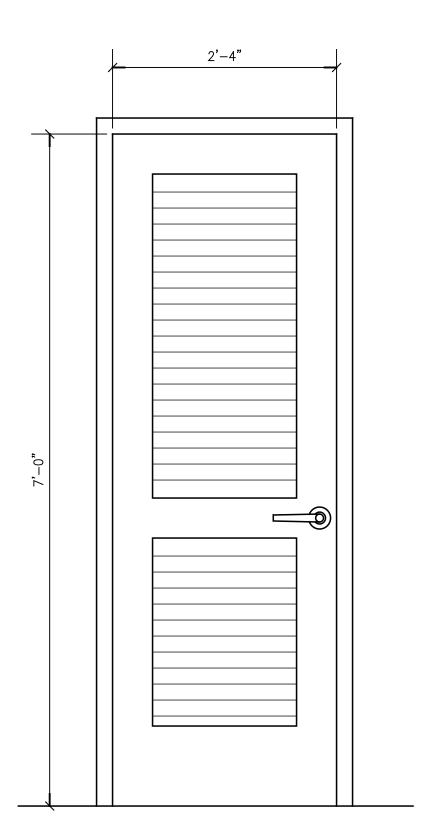
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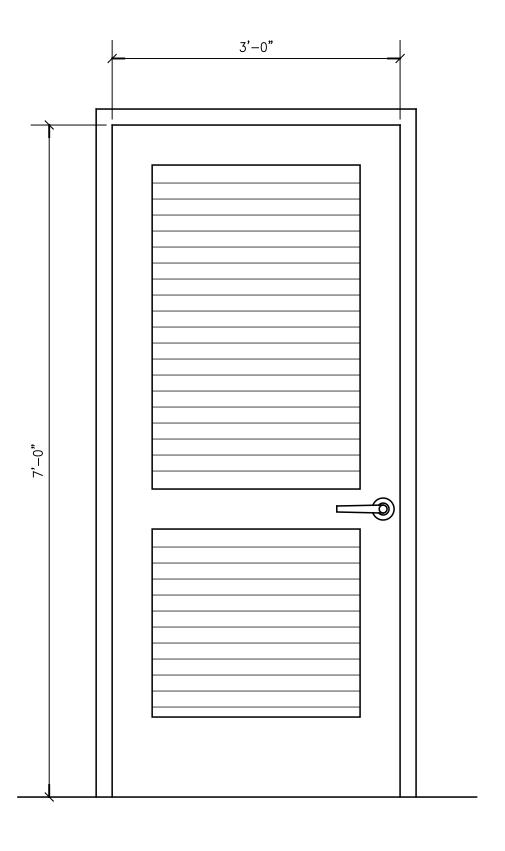
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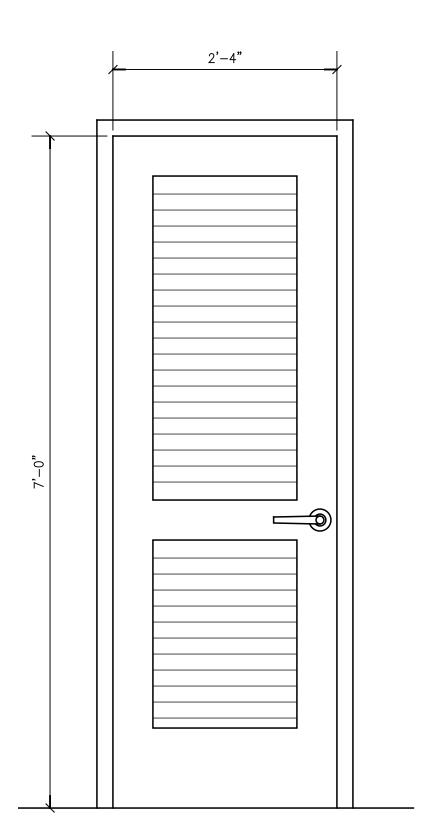
A4.3










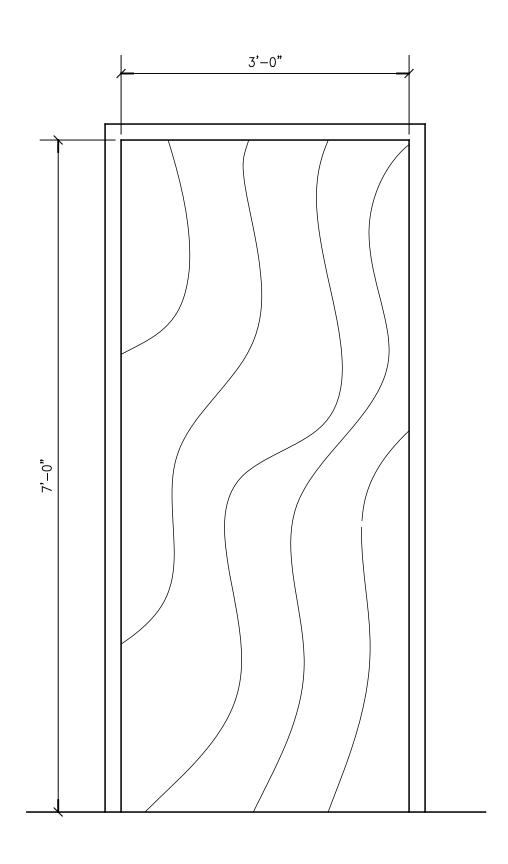

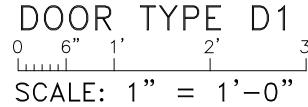

1.75" SOLID CORE WOOD, STAIN GRADE. SPECIES: WHITE OAK. STAIN AND SEAL. ARCHITECT TO SELECT

FRAME: RACO INTERIORS, CLASSIC, FREESTANDING SINGLE EXTRUDED ALUMINUM FRAME FOR DRYWALL CONSTRUCTION (WALL THICKNESS IS 4-7/8"), WHITE PAINT FINISH. INSTALL PER MANUFACTURERS


DOOR SWING: SEE FLOOR PLAN.

INSTRUCTIONS.

- HINGES
- VERTICAL PUSH PLATE

- VERTICAL PULL HANDLE

CLOSER (BRUSHED CHROME FINISH)

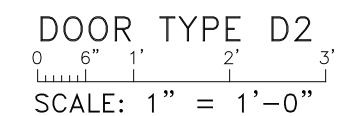


DOOR: 1.75" THICK WOOD STILE AND RAIL LOUVERED DOOR. SPECIES: WHITE OAK, STAIN AND SEAL. ARCHITECT TO SELECT COLOR.

FRAME: RACO INTERIORS, CLASSIC, FREESTANDING SINGLE EXTRUDED ALUMINUM FRAME FOR DRYWALL CONSTRUCTION (WALL THICKNESS IS 4-7/8"), WHITE PAINT FINISH. INSTALL PER MANUFACTURÉRS INSTRUCTIONS.

DOOR SWING: SEE FLOOR PLAN.

HINGES

- LEVER HANDLE PASSAGE SET
- (BRUSHED CHROME FINISH)

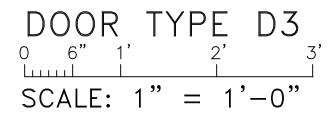


DOOR: 1.75" THICK WOOD STILE AND RAIL LOUVERED DOOR. SPECIES: WHITE OAK. STAIN AND SEAL. ARCHITECT TO SELECT COLOR.

FRAME: RACO INTERIORS, CLASSIC, FREESTANDING SINGLE EXTRUDED ALUMINUM FRAME FOR DRYWALL CONSTRUCTION (WALL THICKNESS IS 4-7/8"), WHITE PAINT FINISH. INSTALL PER MANUFACTURERS INSTRUCTIONS.

DOOR SWING: SEE FLOOR PLAN.

- HINGES LEVER HANDLE PRIVACY SET
- CLOSER COAT HOOK
- (BRUSHED CHROME FINISH)

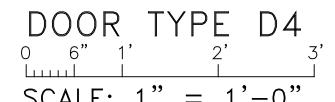


DOOR: 1.75" THICK WOOD STILE AND RAIL LOUVERED DOOR. SPECIES: WHITE OAK, STAIN AND SEAL. ARCHITECT TO SELECT COLOR.

FRAME: RACO INTERIORS, CLASSIC, FREESTANDING SINGLE EXTRUDED ALUMINUM FRAME FOR DRYWALL CONSTRUCTION (WALL THICKNESS IS 4-7/8"), WHITE PAINT FINISH. INSTALL PER MANUFACTURERS INSTRUCTIONS.

DOOR SWING: SEE FLOOR PLAN.

HARDWARE:

- HINGES LEVER HANDLE PRIVACY SET
- CLOSER
- COAT HOOK (BRUSHED CHROME FINISH)

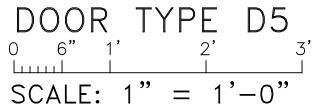

DOOR: 1.75" THICK WOOD STILE AND RAIL LOUVERED DOOR. SPECIES: WHITE OAK. STAIN AND SEAL. ARCHITECT TO SELECT COLOR.

FRAME: RACO INTERIORS, CLASSIC, FREESTANDING SINGLE EXTRUDED ALUMINUM FRAME FOR DRYWALL CONSTRUCTION (WALL THICKNESS IS 4-7/8"), WHITE PAINT FINISH. INSTALL PER MANUFACTURERS


DOOR SWING: SEE FLOOR PLAN.

INSTRUCTIONS.

HINGES LEVER HANDLE PASSAGE SET (BRUSHED CHROME FINISH)



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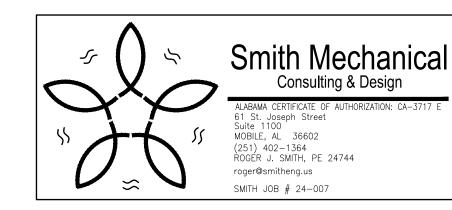
DOOR SCHEDULE

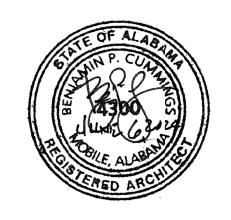PROJECT NO. 2024-01

JUNE 6, 2024

SHEET NO.

			PL	.UMBII	VG FIX	KTURE	E CONNECTION SCHEDULE	
MARK FIXTURE TYPE MANUFACTURER AND MODEL				CONNE	CTIONS		DEMADICO	NOTEO
#	FIXTURE TIPE	MANUFACTURER AND MODEL	WASTE	VENT	CW	HW	REMARKS	NOTES
P-1	FLUSH VALVE WATER CLOSET	KOHLER K-96053 SLOAN ROYAL 111 SMOOTH	3"	2"	1"	-	VITREOUS CHINA, WHITE, 15" HIGH ELONGATED BOWL, FLOOR MOUNTED, TOP SPUD PROVIDE WITH WHITE OPEN FRONT SEAT WITHOUT COVER, AND SLOAN ROYAL BATTERY SENSOR FLUSH VALVE, 1.28 GALLONS PER FLUSH. PROVIDE FLUSH VALVE WITH CHROME PLATED TAIL PIECE EXTENDING FROM VALVE DOWN TO WATER CLOSET AND WALL BRACE. INSTALL PER SPECIFIC MANUFACTURER'S RECOMMENDATIONS.	3
P-1A	FLUSH VALVE WATER CLOSET (HC)	KOHLER K-25076-SS SLOAN ROYAL 111 SMOOTH	3"	2"	1"	-	VITREOUS CHINA, WHITE, 17" HIGH ELONGATED BOWL, FLOOR MOUNTED, TOP SPUD PROVIDE WITH WHITE OPEN FRONT SEAT WITHOUT COVER, AND SLOAN ROYAL BATTERY SENSOR FLUSH VALVE, 1.28 GALLONS PER FLUSH. PROVIDE FLUSH VALVE WITH CHROME PLATED TAIL PIECE EXTENDING FROM VALVE DOWN TO WATER CLOSET AND WALL BRACE. INSTALL PER SPECIFIC MANUFACTURER'S RECOMMENDATIONS. INSTALL PER ADA REQUIREMENTS.	13
P-2	URINAL	KOHLER K-4991-ET SLOAN ROYAL 186 SMOOTH	3"	2"	3/4"	-	VIT. CHINA, WHITE, WALL HUNG, BATTERY POWERED SENSOR FLUSH VALVE TYPE. FLUSH VALVE, 0.5 GALLONS PER FLUSH. PROVIDE SLOAN ROYAL BATTERY SENSOR FLUSH VALVE WITH CHROME PLATED TAIL PIECE EXTENDING DOWN FROM FLUSH VALVE TO TOP OF URINAL. PROVIDE WITH FLOOR MOUNTED CARRIER. INSTALL PER SPECIFIC MANUFACTURER'S RECOMMENDATIONS.	3
P-2A	URINAL (HC)	KOHLER K-4991-ET SLOAN ROYAL 186 SMOOTH	3"	2"	3/4"	-	VIT. CHINA, WHITE, WALL HUNG, BATTERY POWERED SENSOR FLUSH VALVE TYPE. FLUSH VALVE, 0.5 GALLONS PER FLUSH. PROVIDE SLOAN ROYAL BATTERY SENSOR FLUSH VALVE WITH CHROME PLATED TAIL PIECE EXTENDING DOWN FROM FLUSH VALVE TO TOP OF URINAL. PROVIDE WITH FLOOR MOUNTED CARRIER. INSTALL PER SPECIFIC MANUFACTURER'S RECOMMENDATIONS. INSTALL PER ADA REQUIREMENTS.	13
P-3	LAVATORY (HC)	CORIAN ELEMENTS 8254 SLOAN SF-2150 - 0.5 GPM	2"	2"	1/2"	1/2"	SEE ARCHITECTURAL PLANS FOR COUNTER TYPE. PROVIDE UNDERMOUNT, ADA APPROVED LAVATORY EQUAL TO CORIAN ELEMENTS 8254. 19-1/2"x14-3/8" UNDERMOUNT LAVATORY WITH DRAIN LOCATED TOWARD THE BACK OF THE FIXTURE TO ALLOW FOR ADA INSTALLATION. SEE ARCHITECTURAL PLANS FOR ADDITIONAL LAVATORY INSTALLATION REQUIREMENTS. PROVIDE WITH SLOAN BATTERY SENSOR FAUCET WITH ASSE 1070 MIXING VALVE. PROVIDE WITH NEW OFFSET P-TRAP, FLEXIBLE SUPPLIES, AND STOPS. COORDINATE TRAP COVER INSTALLATION WITH GENERAL CONTRACTOR. INSTALL PER ADA REQUIREMENTS.	123
3" FD	FLOOR DRAIN	ZURN Z415B	3"	2"	-	-	CAST IRON FLOOR DRAIN WITH SQUARE POLISHED NICKEL BRONZE GRATE. PROVIDE FLOOR DRAIN WITH "GREEN DRAIN" TRAP SEAL.	







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REVISIONS

PLUMBING SCHEDULES

PROJECT NO. 2024-01

DATE
JUNE 6, 2024

& NOTES

SHEET NO.

ACTUAL SHEET SIZE IS 22" x 34"

- 1 HANDICAPPED FIXTURES SHALL BE INSTALLED PER THE LATEST REQUIREMENTS OF ADA.
- 2 PROVIDE ALL LAVATORIES WITH ASSE 1070 TEMPERATURE LIMITING VALVE. SEE DETAIL FOR INSTALLATION REQUIREMENTS.
- (3) KOHLER, SLOAN, AND CORIAN ELEMENTS ARE THE FIXTURES BASIS OF DESIGN. SUBMIT ALL OTHER ALTERNATES FOR REVIEW AND PRIOR APPROVAL A MINIMUM OF 14 DAYS BEFORE BID DATE.

GENERAL PLUMBING NOTES

- 1. THE CONTRACTOR SHALL EXECUTE ALL WORK SO THAT IT PROCEEDS WITH A MINIMUM INTERFERENCE WITH OTHER TRADES.
- 2. VERIFY EXACT PLUMBING FIXTURE ROUGH-IN AND FINAL HVAC EQUIPMENT REQUIREMENTS IN THE FIELD.
- 3. DRAIN, WASTE, AND VENT PIPING AND FITTINGS SHALL BE STANDARD WEIGHT CAST IRON. CEILING IS A RETURN AIR PLENUM. NO PVC PRODUCTS ARE ALLOWED.
- 4. DOMESTIC WATER PIPING SHALL BE ASTM B 88, TYPE K, WITH ANSI B16.18 OR ANSI B16.22 SOLDER JOINT FITTINGS USING SILVER SOLDER AND FLUX CONTAINING NOT MORE THAN 0.2 PERCENT LEAD; OR WITH ANSI B16.26 FLARED JOINT FITTINGS. ASTM B 88, TYPE L MAY BE PROVIDED FOR ABOVEGROUND PIPING. SLEEVE SERVICE ENTRANCE AT SLAB. SEAL AROUND PIPING WATER PROOF.
- 5. THE CONTRACTOR SHALL BE RESPONSIBLE FOR ALL FINAL CONNECTIONS TO PLUMBING FIXTURES. THIS RESPONSIBILITY INCLUDES, BUT IS NOT LIMITED TO, FURNISHING AND INSTALLING ALL TRAPS, DRAINS, AND SUPPLIES WITH STOPS. FURNISH AND INSTALL PLUMBING FIXTURES INDICATED OR SPECIFIED, COMPLETE WITH ALL EQUIPMENT, FITTINGS, TRIM AND ACCESSORIES INDICATED OR SPECIFIED. EXPOSED WATER PIPING TO FIXTURES SHALL BE CHROME-PLATED BRASS, IPS. ADJUST WATER FLOW THROUGH ALL FIXTURES TO PROVIDE PROPER FLUSHING ACTION WITH THE LEAST AMOUNT OF WATER.
- 6. COORDINATE ROUTING OF WATER SUPPLY, WASTE, AND VENT PIPING WITH OTHER TRADES.
- 7. THE PLUMBING CONTRACTOR SHALL COORDINATE WITH THE GENERAL CONTRACTOR AND OTHER TRADES ALL REQUIRED OPENINGS AND EXCAVATIONS.
- 8. FLOOR CLEANOUTS SHALL BE ADJUSTABLE HEIGHT POLISHED BRONZE, NICKEL BRONZE WITH "CO" CAST IN THE FLOOR PLATE.
- 9. PROVIDE STOPS AND WATER HAMMER ARRESTORS IN ACCORDANCE WITH PDI AND ASSE 1010. AN ACCESS PANEL MUST BE INSTALLED IF WATER HAMMER ARRESTER IS LOCATED INSIDE A WALL OR ABOVE A HARD CEILING. COORDINATE OPENINGS WITH ARCHITECT.

- 10. PROVIDE DIELECTRIC UNIONS AT ALL DISSIMILAR METAL CONNECTIONS.
- 11. INSULATE ALL WATER PIPING. DOMESTIC WATER PIPE NOT EXPOSED TO VIEW SHALL BE INSULATED WITH 1" THICK GLASS FIBER WITH FACTORY APPLIED UNIVERSAL JACKET. DENSITY SHALL BE 4 POUNDS PER CUBIC FOOT. FITTINGS SHALL BE INSULATED ACCORDING TO MANUFACTURER'S RECOMMENDATIONS. INSULATION VAPOR BARRIER SHALL BE LAPPED AND CEMENTED IN ACCORDANCE WITH MANUFACTURER'S RECOMMENDATIONS. DOMESTIC WATER PIPE EXPOSED TO VIEW SHALL BE INSULATED SAME AS WHERE NOT EXPOSED TO VIEW, EXCEPT IT SHALL BE FINISHED WITH A SIZED UNIVERSAL JACKET SUITABLE FOR PAINTING. FITTING SHALL BE MADE OF "QUICKSET" CEMENT MOLDED TO FIT AND COVERED WITH 8 OZ. CANVAS AND FINISHED WITH WHITE VAPOR BARRIER CEMENT, AND HAVE PLASTIC MOLDED FITTING COVERS. INSULATE DOMESTIC WATER AND WASTE PIPING UNDER HANDICAP LAVATORIES AND SINKS USING "LAVGUARD2 E-Z SERIES" MOLDED VINYL PIPING COVERS. COVER ALL PIPING, FITTING, VALVES, AND TRAPS EXPOSED TO VIEW.
- 12. ROUTE ALL PIPING AS TO CAUSE MINIMAL INTERFERENCE FOR MAINTENANCE OF ALL EQUIPMENT. UNLESS OTHERWISE NOTED, ALL DOMESTIC WATER PIPING SHALL BE ROUTED WITHIN CHASE SPACE. PIPING BELOW SLAB SHALL BE WITHOUT JOINTS AND TEES. PIPING PASSING THRU WALLS EXTENDING TO BOTTOM OF STRUCTURE SHALL BE SLEEVED AND SEALED. ALL DOMESTIC WATER PIPING ROUTED EXPOSED BELOW 6'-8" ABOVE FINISH FLOOR SHALL BE PROVIDED WITH A PVC JACKET TO PREVENT DAMAGE TO THE PIPE.
- 13. PROVIDE SHUTOFF VALVE TO EACH SILLCOCK WITH VALVE IDENTIFICATION AS REQUIRED BY CODE.
- 14. BEFORE FINAL ACCEPTANCE OF THE WORK, TEST EACH SYSTEM AS IN SERVICE TO DEMONSTRATE COMPLIANCE WITH 2021 INTERNATIONAL PLUMBING CODE AND LOCAL CODE REQUIREMENTS. ONCE TEST ARE IN COMPLIANCE WITH CONTRACT REQUIREMENTS DISINFECT WATER SYSTEM IN ACCORDANCE WITH AWWA C651.
- 15. CONTRACTOR TO VERIFY ALL LOCATIONS OF ROOF PENETRATIONS WITH ARCHITECTURAL DRAWINGS.

- 16. PIPE HANGERS AND SUPPORTS SHALL BE MSS SP-58 AND MSS SP-69, TYPE 1 OR 6, OF THE ADJUSTABLE TYPE, EXCEPT AS INDICATED OTHERWISE. ATTACHMENTS TO STEEL W OR S BEAMS SHALL BE WITH TYPE 21, 28, 29, OR 30 CLAMPS. ATTACHMENTS TO STEEL ANGLES AND CHANNELS (WITH WEB VERTICAL) SHALL BE WITH TYPE 20 CLAMP WITH A BEAM CLAMP CHANNEL ADAPTER. ATTACHMENTS TO STEEL CHANNEL (WITH WEB HORIZONTAL) SHALL BE WITH DRILLED HOLE ON CENTERLINE AND DOUBLE NUT AND WASHER. ATTACHMENTS TO CONCRETE SHALL BE WITH TYPE 18 INSERT OR A DRILLED HOLE WITH EXPANSION ANCHOR. HANGER RODS AND ATTACHMENTS SHALL BE FULL SIZE OF THE HANGER-THREADED DIAMETER. PROVIDE TYPE 40 INSULATION PROTECTION SHIELDS FOR INSULATED PIPING. PROVIDE STEEL SUPPORT RODS. PROVIDE NONMETALLIC, HAIR FELT, OR PLASTIC PIPING ISOLATORS BETWEEN COPPER TUBING AND THE HANGERS.
- 17. LABEL ALL WATER SERVICE VALVES IN ACCORDANCE WITH APPLICABLE CODES
- 18. COORDINATE EXACT FLOOR DRAIN LOCATIONS ARCHITECTURAL DRAWINGS. SLOPE ENTIRE ROOM TO DRAINS.
- 19. ALL TRAP PRIMER VALVES NOT LOCATED IN NORMALLY UNOCCUPIED SPACES SHALL BE MOUNTED ABOVE THE CEILING AND PROVIDED WITH A LABEL ON THE CEILING GRID TO INDICATE THE TRAP PRIMER LOCATION. NO TRAP PRIMERS SHALL BE INSTALLED EXPOSED IN NORMALLY OCCUPIED SPACES.
- 20. ALL WORK INSTALLED SHALL MEET THE REQUIREMENTS OF THE LOCAL AUTHORITY HAVING JURISDICTION, THE 2021 INTERNATIONAL PLUMBING CODE, AND THE 2015 INTERNATIONAL ENERGY CONSERVATION CODE.

SHEET NOTES

- \langle 1 \rangle EXISTING PLUMBING STUB UP THAT HAS BEEN ABANDONED. REMOVE PIPING TO A POINT BELOW THE SLAB INTO THE THIRD FLOOR CEILING SPACE BELOW AND CAP WATER TIGHT.
- $\left\langle 2 \right\rangle$ EXISTING FLOOR PENETRATION COVERED WITH A STEEL PLATE. COORDINATE REMOVAL OF ANY EXISTING ABANDONED UTILITIES WITH THE GENERAL CONTRACTOR TO ALLOW FOR PATCHING OF THE FLOOR. REFERENCE ARCHITECTURAL PLANS FOR ADDITIONAL INFORMATION ON FLOOR PATCHING.
- 3 EXISTING HOT WATER, COLD WATER, OR HOT WATER RETURN PIPING PASSING FROM 4TH FLOOR CEILING SPACE, DOWN THROUGH SLAB INTO THIRD FLOOR CEILING. CONTRACTOR SHALL REMOVE PIPING FROM ITS PRESENT LOCATION AND RELOCATE IT INTO THE NEW RESTROOM WALL AND RECONNECT TO THE EXISTING PIPING IN THE THIRD FLOOR CEILING SPACE BELOW. FIELD VERIFY A SUITABLE LOCATION FOR CONNECTION OF NEW TO EXISTING PIPING IN THIRD FLOOR CEILING SPACE BELOW.
- \langle 4 \rangle EXISTING SANITARY WASTE STUB UP TO BE REMOVED ENTIRELY. REMOVE TO A POINT IN THE THIRD FLOOR CEILING SPACE BELOW. PREPARE REMAINING SANITARY WASTE PIPING IN THIRD FLOOR CEILING FOR REUSE, OR CAP AIR TIGHT.
- \langle 5 \rangle EXISTING SANITARY WASTE/VENT PIPING TO BE REMOVED TO A POINT INSIDE THE THIRD FLOOR CEILING BELOW AND ABANDONED IN PLACE. CAP AIR TIGHT. PATCH UNUSED ROOF PENETRATION WATER TIGHT TO MATCH SURROUNDING. IF SANITARY VENT PIPING IN THIRD FLOOR CEILING IS SERVING FIXTURES BELOW, REWORK VENT PIPING TO REMAIN SUCH THAT IT IS EXTENDED AS NECESSARY FOR CONNECTION TO A SANITARY VENT THAT REMAINS EXTENDING UP THROUGH THE ROOF.

- 6 EXISTING WATER CLOSET TO BE REMOVED. REMOVE ASSOCIATED WASTE, WATER, AND VENT PIPING TO A POINT BELOW THE SLAB OR ABOVE THE CEILING AND CAP AIR TIGHT OR PREPARE FOR REUSE.
- (7) EXISTING LAVATORY TO BE REMOVED. REMOVE ASSOCIATED WASTE, WATER, AND VENT PIPING TO A POINT BELOW THE SLAB OR ABOVE THE CEILING AND CAP AIR TIGHT OR PREPARE FOR REUSE.
- \langle 8 \rangle EXISTING CW/HW/HWR PIPING DOWN FROM PENTHOUSE BOILER ROOM. PREPARE PIPING IN FORTH FLOOR CEILING SPACE FOR RELOCATION AND RECONNECTION TURNING DOWN INSIDE NEW RESTROOM WALL. SEE NEW WORK PLAN.
- \langle 9 \rangle EXISTING FORTH FLOOR CW/HW/HWR PIPING IN FORTH FLOOR CEILING TO BE REMOVED. SEE NEW WORK PLAN FOR REWORKING/RECONNECTION TO PIPING IN THE THIRD FLOOR CEILING.



CONTRACTOR SHALL VISIT THE SITE PRIOR TO SUBMITTING A BID FOR THE WORK. THE

CONTRACTOR SHALL BECOME AWARE OF ALL EXISTING CONDITIONS AND HAVE AN

UNDERSTANDING OF THE PLUMBING WORK REQUIRED IN THE THIRD FLOOR CEILING

Consulting & Design MOBILE, AL 36602 (251) 402-1364 ROGER J. SMITH, PE 24744 roger@smitheng.us



One Houston Street Mobile, Alabama 36606 TEL 251.433.9600



AUTHORITY
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MARK	DATE			

SHEET NAME 4th FLOOR PLUMBING **DEMO PLAN**

PROJECT NO. 2024-01


DATE JUNE 6, 2024


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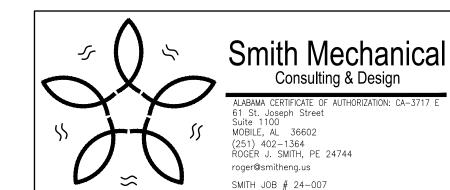
P2.0

ACTUAL SHEET SIZE IS 22" x 34'


SPACE BELOW. SOME WATER, SANITARY WASTE, AND SANITARY VENT PIPING WILL REQUIRE MODIFICATION AND RELOCATION SO THAT IT CAN BE RECONNECTED FOR CONTINUED USE. THE PIPING REQUIRING THIS MODIFICATION TO REMAIN IN USE IS IDENTIFIED TO THE GREATEST EXTENT POSSIBLE. THE CONTRACTOR WILL BE REQUIRED TO OFFSET AND ROUTE THE REWORKED PIPING AS NECESSARY TO ACCOMMODATE EXISTING CONDITIONS. NO PVC OR PEX PIPING SHALL BE INSTALLED ON THIS PROJECT.



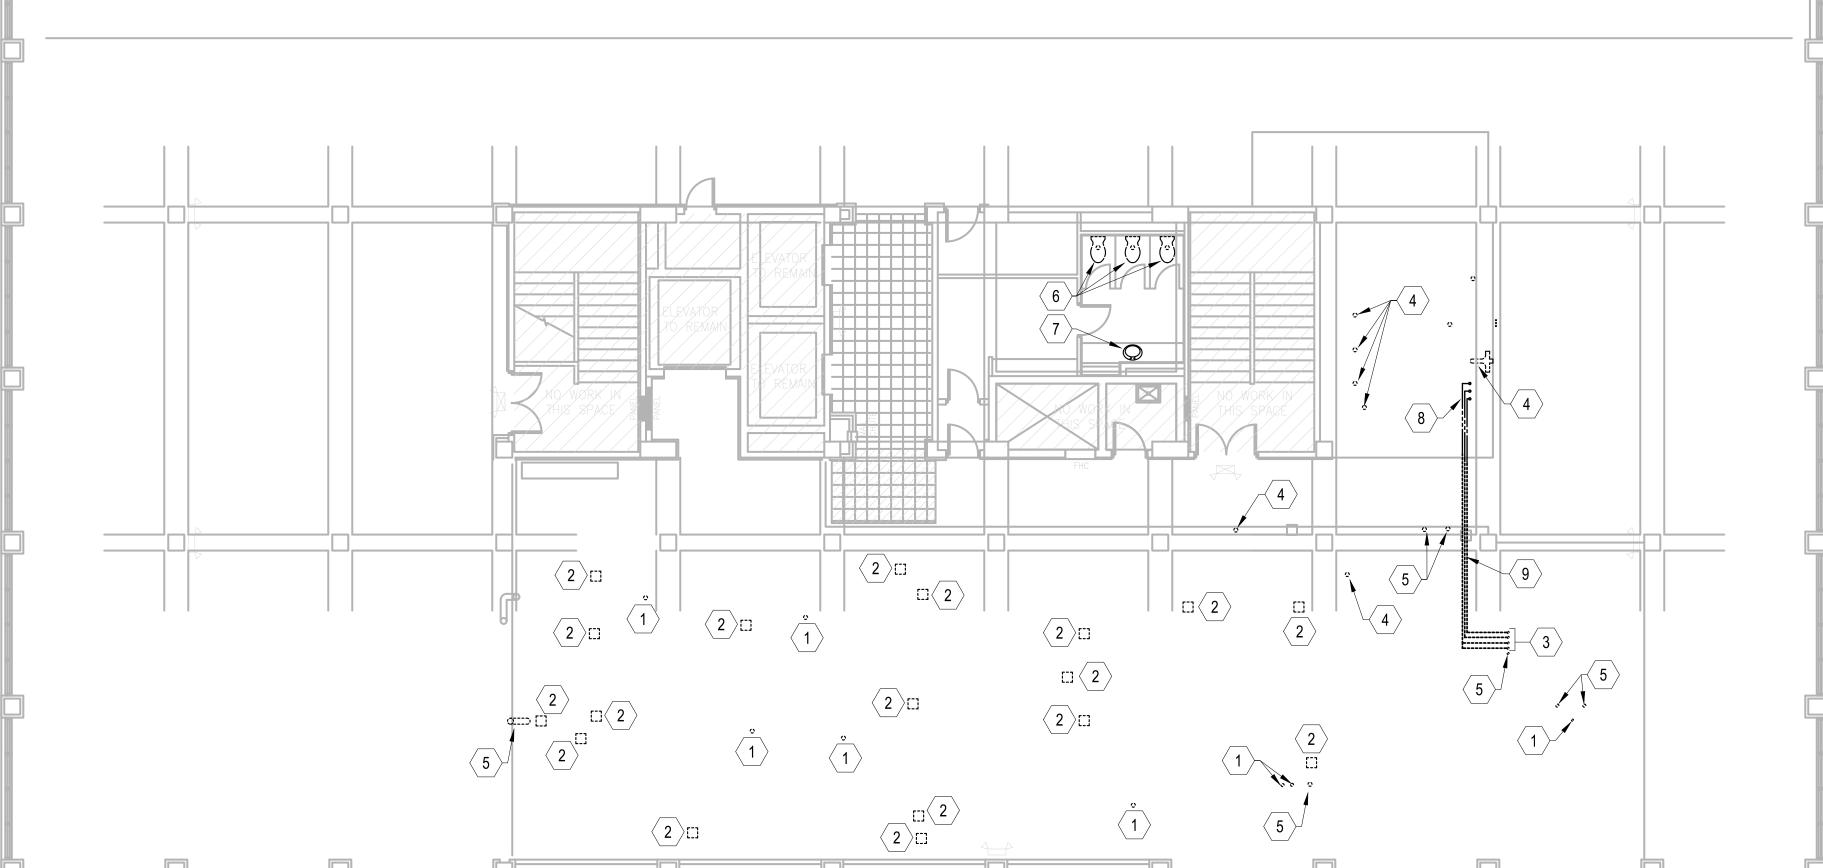

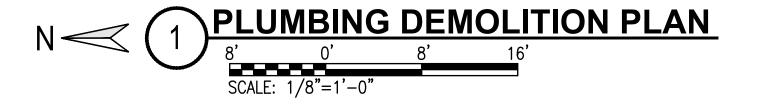



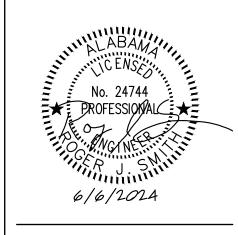

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4th FLOOR INTERIOR - PHASE 1
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SHEET NAME

4th FLOOR PLUMBING NEW WORK PLAN

PROJECT NO. 2024-01

JUNE 6, 2024

SHEET NO.

ACTUAL SHEET SIZE IS 22" x 34'

P3.0

SHEET NOTES


igg(1igg) 1/2" HW/CW DOWN INSIDE WALL FOR CONNECTION TO LAVATORY.

 \langle 2 \rangle 1" CW DOWN INSIDE WALL FOR CONNECTION TO WATER CLOSET.


 \langle 3 \rangle 3/4" CW DOWN INSIDE WALL FOR CONNECTION TO URINAL.

4 EXISTING HW/CW/HWR PIPING DOWN FROM PENTHOUSE BOILER ROOM TO BE RELOCATED INTO NEW RESTROOM WALL AND EXTENDED AS NECESSARY FOR RECONNECTION TO THE PIPING IN THE 3RD FLOOR CEILING. FIELD VERIFY A SUITABLE ROUTE FOR THE PIPING TO BE RECONNECTED TO THE EXISTING SERVICES TO REMAIN. CORE DRILL 4TH FLOOR AT NEW RESTROOM WALL AS NECESSARY TO ACCOMMODATE INSTALLATION. FIELD VERIFY EXISTING PIPING SIZE AND NEW PIPING TO DUPLICATE THE EXISTING SIZE.


CONTRACTOR SHALL COORDINATE
ALL WORK IN THE 3RD FLOOR CEILING
WITH THE OWNER FOR ACCESS.

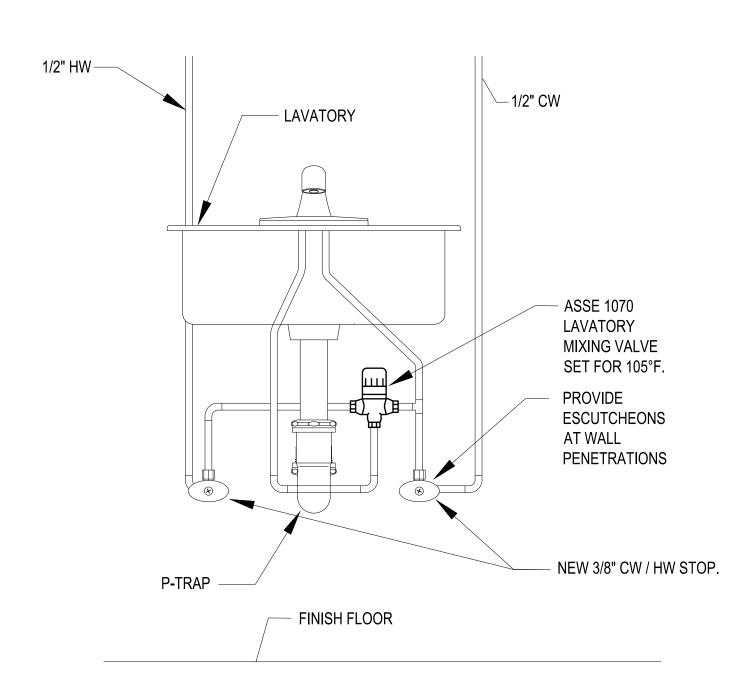




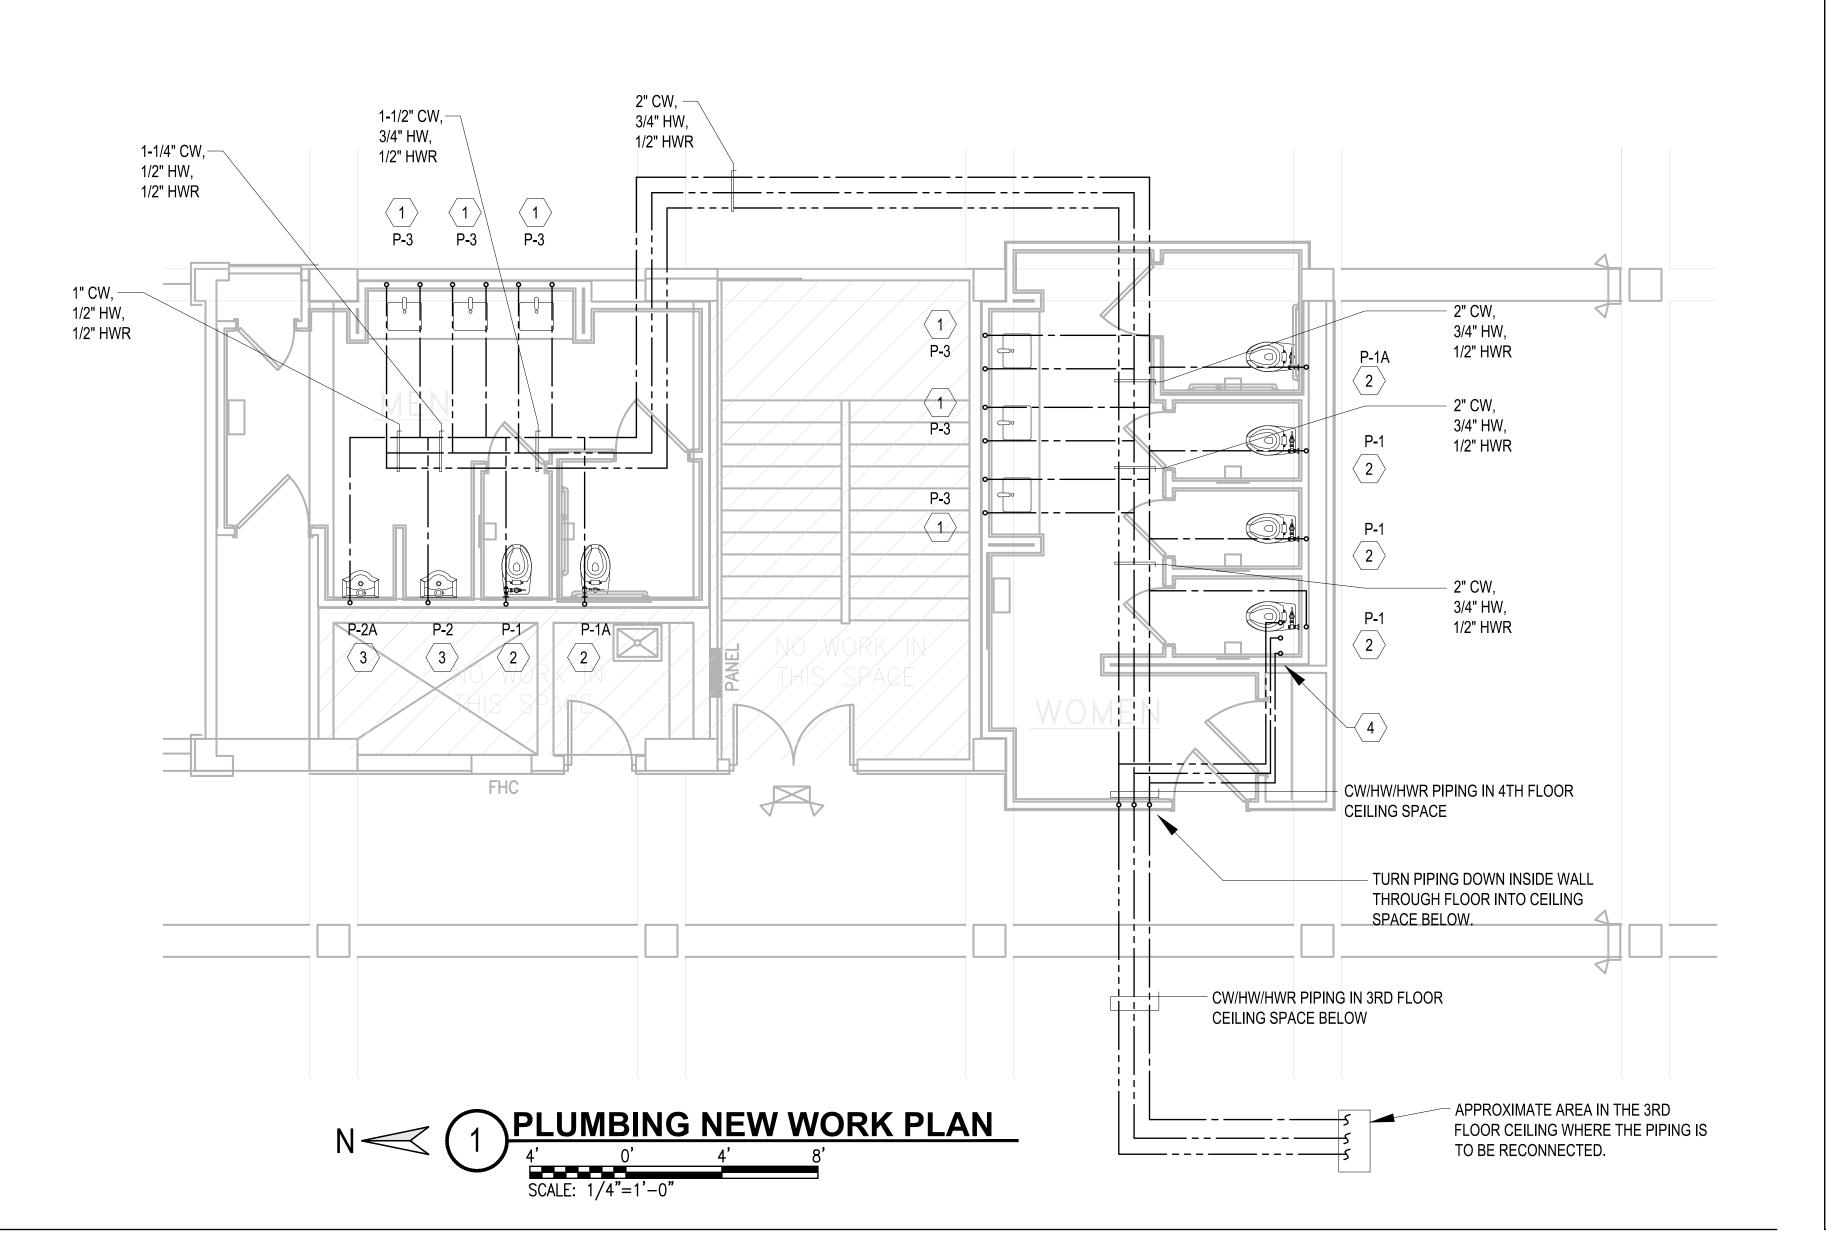

Smith Mechanical Consulting & Design ALABAMA CERTIFICATE OF AUTHORIZATION: CA-3717 E 61 St. Joseph Street Suite 1100 MOBILE, AL 36602 (251) 402-1364 ROGER J. SMITH, PE 24744 roger@smitheng.us SMITH JOB # 24-007

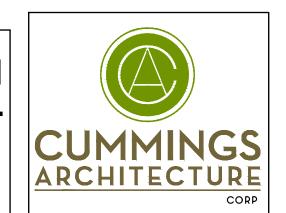

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4th FLOOR
SANITARY
NEW WORK PLAN

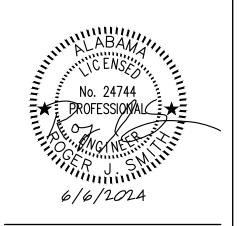PROJECT NO. 2024-01


DATE
JUNE 6, 2024

P4.0

ACTUAL SHEET SIZE IS 22" x 34'


SHEET NOTES

- 1 EXTEND SANITARY VENT PIPING AS NECESSARY FOR CONNECTION TO EXISTING SANITARY VENT THROUGH THE ROOF. FIELD VERIFY A SUITABLE LOCATION FOR CONNECTION TO EXISTING VENT PIPING OR LOCATION OF EXISTING VENT THROUGH THE ROOF.
- 2 EXTEND SANITARY WASTE PIPING IN THIRD FLOOR CEILING AS NECESSARY FOR CONNECTION TO EXISTING SANITARY WASTE PIPING. FIELD VERIFY A SUITABLE LOCATION FOR CONNECTION OF NEW TO EXISTING.

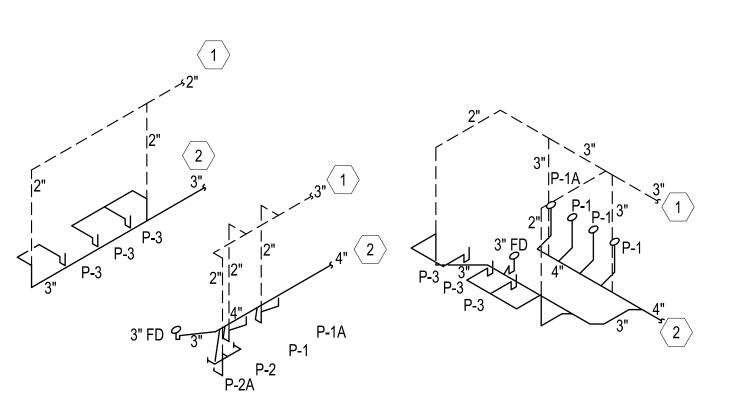

2 SANITARY WASTE RISERS

NOT TO SCALE

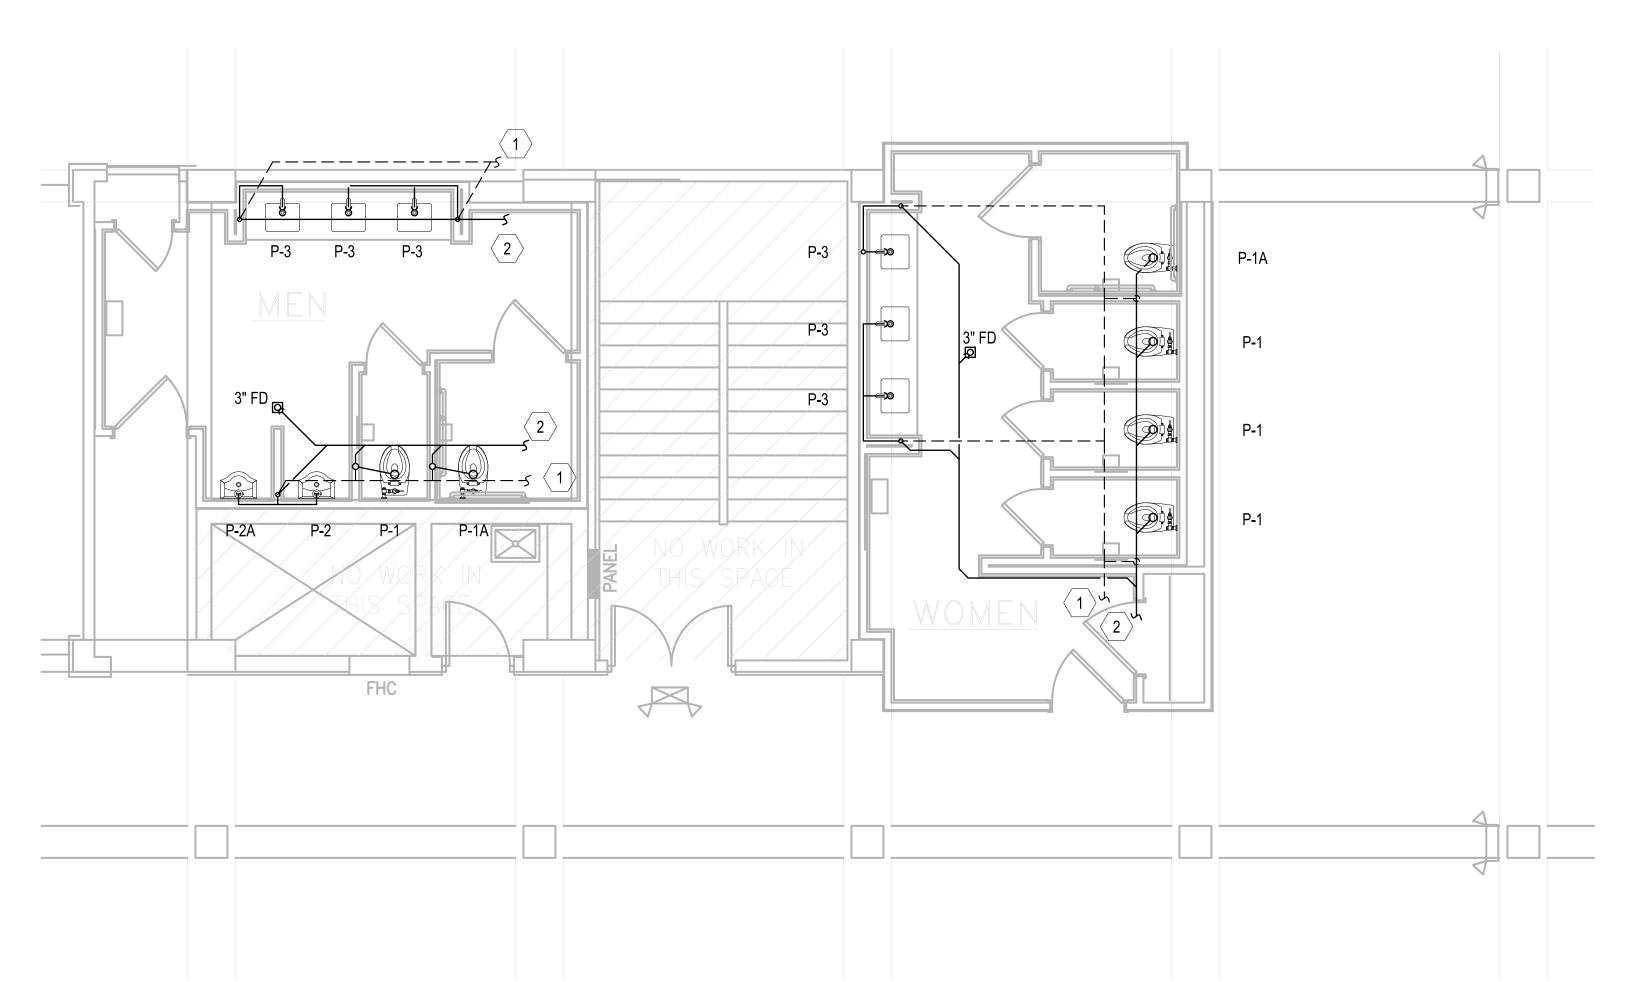

CONTRACTOR SHALL COORDINATE
ALL WORK IN THE 3RD FLOOR CEILING
WITH THE OWNER FOR ACCESS.



GENERAL PIPING NOTES

- A. ALL BALL VALVES, INCLUDING THOSE USED FOR DRAIN/BLOWDOWN VALVES, GAGE, AIR VENT, COLD WATER MAKE-UP, CHEMICAL TREATMENT AND EXPANSION TANK SERVICE SHALL BE BRONZE BODY, THREADED ENDS, ALL STAINLESS STEEL TRIM AND STAINLESS STEEL LATCH-LOCK HANDLE, MILWAUKEE 20BSOR-02-LL, OR EQUAL BY KITZ OR HAMMOND.
- B. ALL TAPS FOR P/T PORTS, GAGES, DIFFERENTIAL PRESSURE SWITCHES, DRAIN VALVES ETC. SHALL BE MAKE WITH FORGED STEEL THREDOLETS OR WELDED REDUCING TEE IN PIPING SIZE 2 1/2" AND LARGER, GALVANIZED MALLEABLE IRON SCREWED REDUCING TEE IN STEEL PIPING SIZE 2" AND SMALLER. AND SOLDERED TEES IN COPPER PIPING. MOUNT P/T PORTS IN VERTICAL POSITION.
- C. ALL GAGE (INTERIOR), AIR VENT, DRAIN VALVE, STRAINER BLOWDOWN AND DIFFERENTIAL PRESSURE CONNECTION PIPING SHALL BE SCREWED BRASS PIPE. AIR VENT DISCHARGE PIPING MAY BE HEAVY WALL SOFT COPPER TUBING IF RUN STRAIGHT AND PERPENDICULAR TO BUILDING LINES AND PROPERLY SUPPORTED AT REGULAR INTERVALS.
- PRESSURE/TEMPERATURE TEST PORTS SHALL BE BRASS BODY 1/4" MPT WITH DUAL NORDEL SEALS AND BRASS CAP W/RETAINER STRAP, FLOW DESIGN INC. SUPERSEAL. PROVIDE 2-3/4" LENGTH FOR INSULATED PIPING AND 1-1/4" LENGTH FOR NON-INSULATED PIPING. MOUNT P/T PORTS IN VERTICAL POSITION ACCESSIBLE FOR EASY INSERTION OF TEMPERATURE AND PRESSURE MEASURING DEVICES.
- E. THE USE OF BUSHINGS AND CLOSE NIPPLES FOR THREADED CONNECTIONS OF ANY KIND IS NOT ALLOWABLE.
- F. PROVIDE AUTOMATIC AIR VENTS AT ALL HIGH POINTS IN PIPING AND ELSEWHERE AS INDICATED, SEE TYPICAL DETAILS.
- G. SUPPORT PIPING FROM GROUND WITH GALVANIZED STEEL SCHEDULE 40 PIPE STANDS PRIOR TO FINAL CONNECTION TO PUMPS SUCH THAT NO PIPING WEIGHT IS CARRIED BY PUMP CONNECTIONS.
- H. MECHANICAL CONTRACTOR SHALL INSTALL THRED-O-LETS FOR DDC TEMPERATURE WELLS WHERE REQUIRED BY ENGINEER AND/OR DDC CONTRACTOR.
- I. ALL NEW HOT WATER PIPING SHALL BE INSULATED WITH 1-1/2" THICK SECTIONAL FIBERGLASS WITH AN ASJ JACKET. ALL FITTINGS AND VALVES TO BE PROVIDED WITH PREMOLDED INSULATION SECTIONS.
- J. ALL NEW HYDRONIC PIPING SHALL MATCH EXISTING PIPING MATERIALS.
- K. CONTRACTOR SHALL DRAIN AND REFILL EXISTING HOT WATER SYSTEM AS NECESSARY TO PERFORM THE NEW BRANCH CONNECTION WORK AND PROVIDE NEW CHEMICAL TREATMENT FOR REFILL.
- THE MECHANICAL CONTRACTOR PERFORMING WORK ON THIS PROJECT WILL BE RESPONSIBLE FOR ALL ASSOCIATED ELECTRICAL AND CONTROLS WORK REQUIRED TO SUPPORT THE INSTALLATION OF THE TWO NEW VAV BOXES AND THE INDEPENDENT ELECTRIC THERMOSTATS TO CONTROL THE NEW VAV BOXES. IN A FUTURE CONTROLS UPGRADE. THE BUILDINGS THERMOSTATS WILL BE MODIFIED OR REPLACED WITH A SINGLE SYSTEM. THE TWO NEW BOXES ON THE FOURTH FLOOR WILL OPERATE INDEPENDENT OF THE EXISTING BUILDING HVAC CONTROLS SYSTEM FOR NOW.

GENERAL NOTES

- THE MECHANICAL CONTRACTOR IS REQUIRED TO HAVE A GENERAL CONTRACTORS LICENSE AND SHALL COORDINATE WITH ASPA PROJECT MANAGER AND OTHER TRADES AS NECESSARY FOR REQUIRED OPENINGS IN WALLS, FOUNDATIONS, FLOORS, AND ROOFS.
- THE MECHANICAL CONTRACTOR TO VERIFY MECHANICAL EQUIPMENT LOCATIONS AND BE RESPONSIBLE FOR ALL RELATED CLEARANCES IN THE FIELD. PROVIDE ADEQUATE MAINTENANCE CLEARANCE AROUND EACH PIECE OF EQUIPMENT PER THE MANUFACTURER'S RECOMMENDATIONS, PROVIDE CLEARANCE IN FRONT OF ELECTRICAL PANELS AND OTHER ELECTRICAL EQUIPMENT PER THE NATIONAL ELECTRICAL CODE REQUIREMENTS. COORDINATE WITH THE CONTROLS CONTRACTOR AND ELECTRICAL CONTRACTORS IN THE FIELD.
- PIPING SHOWN IN THESE DRAWINGS ARE DIAGRAMMATIC. ARRANGE IN A NEAT AND ORDERLY MANNER.
- 4. PENETRATIONS THROUGH FIRE RATED FLOORS AND WALLS ARE TO BE FIRE SEALED SO AS TO MAINTAIN FLOOR OR WALL INTEGRITY IN THE EVENT OF A FIRE.
- VERIFY COLLAR SIZES ON ALL EQUIPMENT INLETS AND OUTLETS. TRANSITION DUCTWORK AS NECESSARY. EXTERNALLY INSULATE ALL TRANSITIONS AT EQUIPMENT CONNECTIONS.
- INSTALL EQUIPMENT AND DUCTWORK TO MANUFACTURERS RECOMMENDED CLEARANCES.
- 7. PENETRATIONS OF FIREWALLS, CEILINGS, FLOORS, ETC. FOR PIPING TO BE UL LISTED FIRESTOPS AND SHALL BE INSTALLED AS PER MANUFACTURER'S RECOMMENDATION. CONTRACTOR TO OBTAIN MANUFACTURER SHOP DRAWINGS AT JOBSITE FOR PENETRATIONS.
- 8. PROVIDE FLEXIBLE DUCT, PIPE CONNECTIONS, AND VIBRATION ISOLATORS FOR INTERNALLY ISOLATED UNITS.
- DO NOT MOUNT DISCONNECT SWITCHES ON HVAC EQUIPMENT.
- 10. ALL ROUND FLEXIBLE DUCT TO BE FACTORY PRE-INSULATED. MAXIMUM LENGTH OF ANY FLEXIBLE DUCT RUNOUT TO BE 6 FT. WHERE LENGTH REQUIRED EXCEEDS 6 FT, INSTALL EXTERNALLY INSULATED ROUND SNAPLOCK DUCT FOR BALANCE OF DISTANCE TO SPIN-IN TAP AT MAIN DUCT TRUNK.
- 11. SUPPLY AIR DUCTWORK TO BE SINGLE WALL LOW PRESSURE RECTANGULAR, SMACNA STATIC PRESSURE CLASS 250 Pa (1" W.G.). SEAL CLASS A. EXTERNALLY INSULATED WITH 2" THICK R-8 FIBERGLASS DUCT WRAP. DUCT SIZES INDICATED ARE INSIDE CLEAR DIMENSIONS.
- 12. RETURN AIR DUCTWORK TO BE SINGLE WALL LOW PRESSURE RECTANGULAR, SMACNA STATIC PRESSURE CLASS 250 Pa (1" W.G.), SEAL CLASS A. DUCT SIZES INDICATED ARE INSIDE CLEAR DIMENSIONS. PROVIDE 2" THICK R-8 EXTERNAL FIBERGLASS DUCT WRAP.
- 13. EXHAUST AIR DUCTWORK TO BE LOW PRESSURE SINGLE WALL RECTANGULAR, SMACNA STATIC PRESSURE CLASS 250 Pa (1" W.G.), SEAL CLASS A. EXHAUST DUCT IS NOT REQUIRED TO BE INSULATED.
- 14. AVOID ROUTING DUCTWORK OVER LIGHTS WHEREVER POSSIBLE. MAINTAIN MINIMUM 6" CLEARANCE BETWEEN DUCT INSULATION TO TOP OF LIGHTS.
- 15. WORK SHALL COMPLY WITH THE FOLLOWING AGENCIES
 - -2021 INTERNATIONAL BUILDING CODE
 - -2021 INTERNATIONAL MECHANICAL CODE
 - -2015 INTERNATIONAL ENERGY CONSERVATION CODE -NATIONAL FIRE PROTECTION AGENCY (NFPA)
 - -AMERICAN SOCIETY OF HEATING AND REFRIGERATION ENGINEERS (ASHRAE)
 - -NATIONAL ELECTRIC CODE NFPA 70
- 16. ALL WORK AND EQUIPMENT SHALL BE PROVIDED WITH A TWO YEAR WARRANTY STARTING FROM THE TIME OF SUBSTANTIAL COMPLETION OF THE PROJECT AS DETERMINED BY THE ASPA PROJECT MANAGER.



Consulting & Design

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AUTHORITY

- PHASE 1

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SHEET NAME HVAC **SCHEDULES** AND NOTES

PROJECT NO. 2024-01

DATE JUNE 6, 2024

SHEET NO.

M1.0

ACTUAL SHEET SIZE IS 22" x 34'


VAV BOX SCHEDULE


	MARK				MIN. INLET STATIC					Н	EATING CO	IL			INLET SIZE	MANUFACTURER	MODFI	
MARK	USE WITH	TOTAL CFM	COOL CFM MIN.	HEATING CFM MIN.	PRESS. (IN.)	EAT (°F)	LAT (°F)	MBH (MIN.)	EWT (°F)	LWT (°F)	GPM	MAX. UNIT APD (IN.)	MAX.WPD (FT.)	CONTROL VALVE TYPE AND SIZE	(IN.)		MODEL NUMBER	REMARKS
VAV 4-19	AHU-2	230	130	130	0.5"	55.0	95.0	5,600	180.0	140.0	0.56	0.35	2.0	2-WAY / 1/2"	5"Ø	TITUS	DESV	1, 2, 3
VAV 4-20	AHU-2	200	130	130	0.5"	55.0	95.0	5,600	180.0	140.0	0.56	0.35	2.0	2-WAY / 1/2"	5"Ø	TITUS	DESV	1, 2, 3

- 1. COORDINATE ALL ELECTRICAL REQUIREMENTS WITH THE ELECTRICAL CONTRACTOR. CONTROL VALVES SHALL BE PROVIDED WITH A TRANSFORMER. ON THE 4TH FLOOR, PROVIDE A 120V/1Ø TRANSFORMER.
- 2. BASIS OF DESIGN TITUS SDEV WITH HOT WATER COIL REHEAT.
- 3. VAV BOX TO BE CONTROLLED WITH A TWO WAY WAY CONTROL VALVE CONNECTED TO A LOCAL THERMOSTAT.

SHEET NOTES

- 1 EXISTING EXHAUST GRILLE TO BE REMOVED. REMOVE EXHAUST BRANCH DUCT TO A POINT ABOVE THE CEILING AND CAP AIR TIGHT. PREPARE REMAINING EXHAUST TRUNK DUCT FOR REUSE. SEE NEW WORK PLAN FOR ADDITIONAL INFORMATION.
- 2 EXISTING OPEN EXHAUST TRUNK DUCT TO BE REUSED. SEE NEW WORK PLAN FOR ADDITIONAL REQUIREMENTS.
- EXISTING EXHAUST TRUNK DUCT UP INSIDE CHASE TO EXISTING ROOF MOUNTED EXHAUST FAN ABOVE PENTHOUSE MECHANICAL ROOM. CONTRACTOR SHALL PROVIDE A FULL MAINTENANCE SERVICE ON THE ROOF MOUNTED EXHAUST FAN INCLUDING BUT NOT LIMITED TO CLEANING THE FAN BLADES, OILING THE MOTOR AND BEARINGS, AND REPLACING THE BELTS.
- EXISTING MEDIUM PRESSURE HVAC SYSTEM AS WELL AS EXISTING VAV BOXES, HOT WATER PIPING, LOW PRESSURE DISTRIBUTION DUCT TO REMAIN. SEE NEW WORK PLAN FOR THE TWO ADDITIONAL VAV BOXES REQUIRED FOR THIS PROJECT.

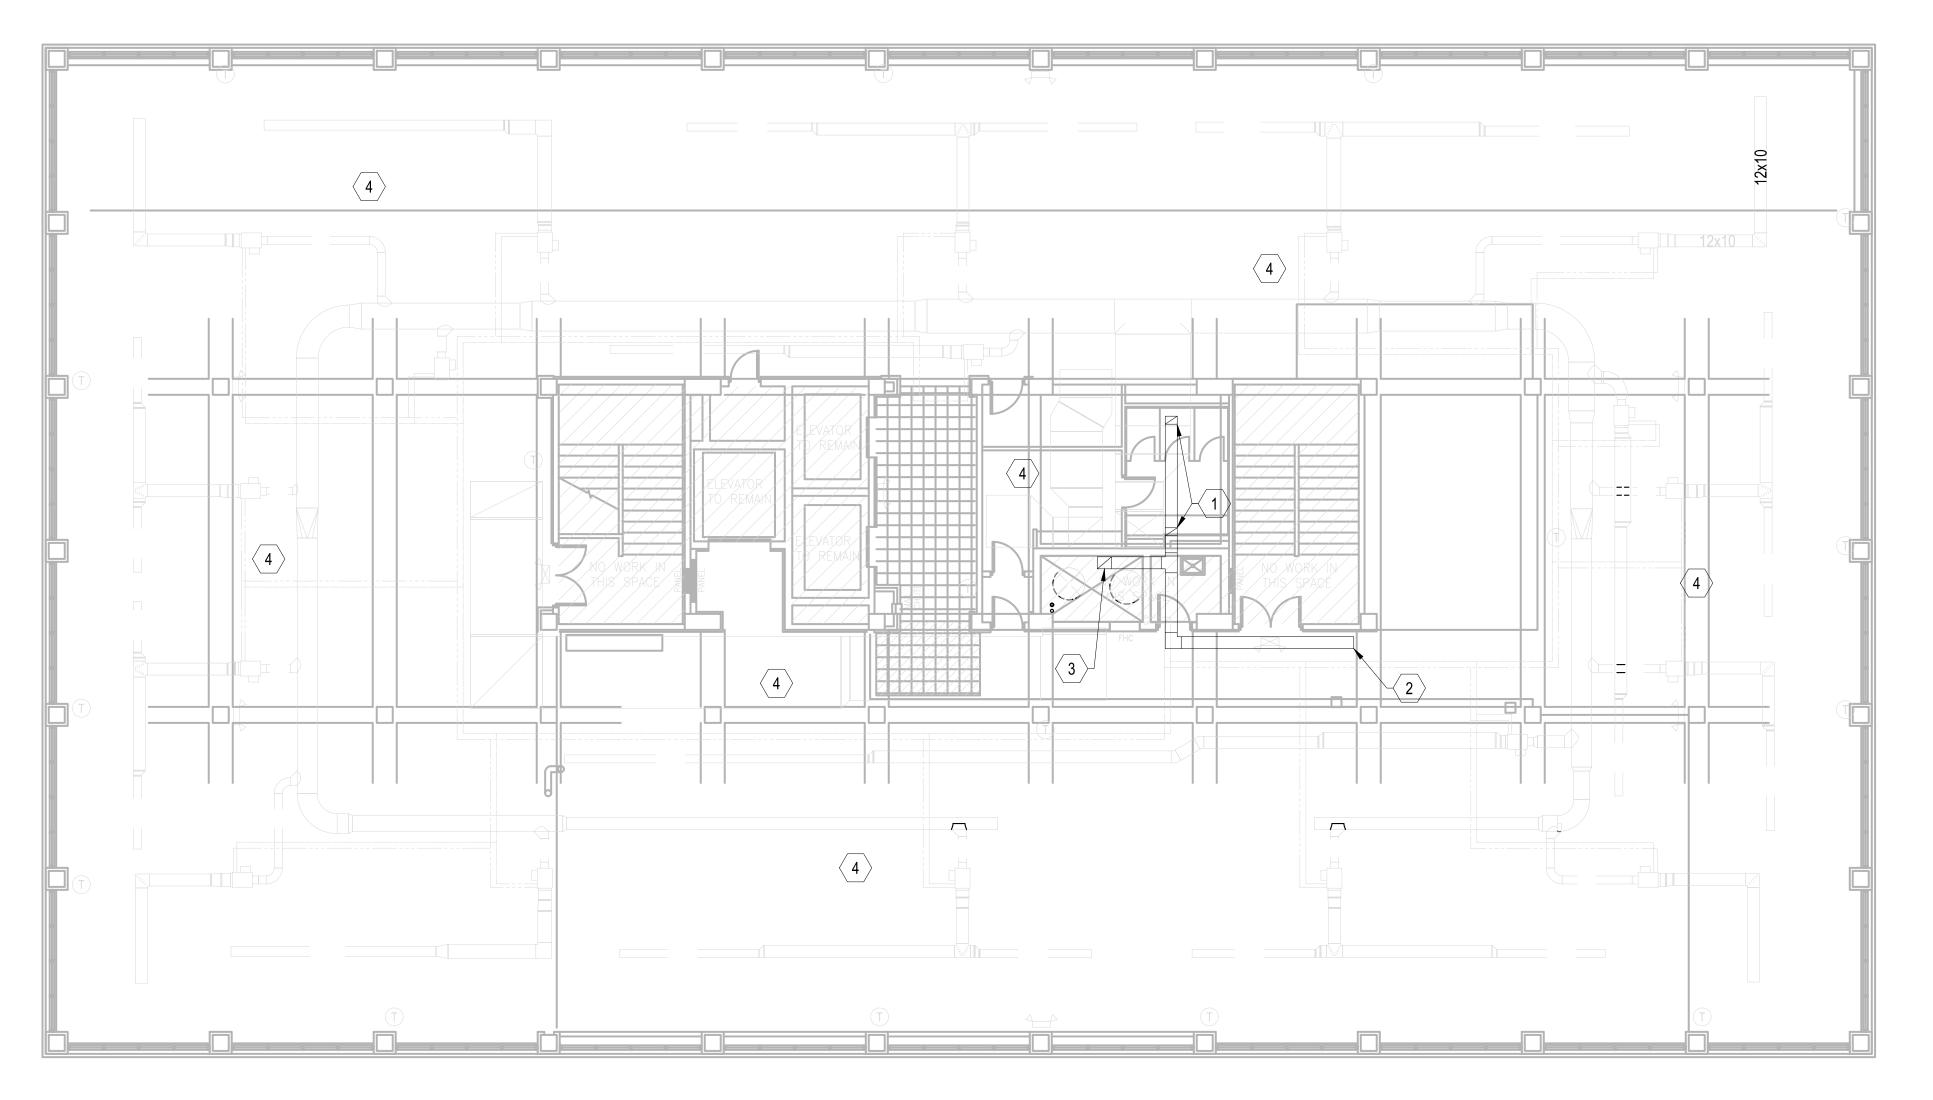

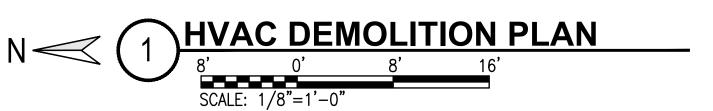





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4th FLOOR INTERIOR - PHASE 1
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4th FLOOR
HVAC
DEMO PLAN

PROJECT NO. 2024-01

DATE
JUNE 6, 2024

SHEET NO.

M2.0

SHEET NOTES


- 9"x9" TITUS TDC-AA CEILING GRILLE WITH 7"Ø CONNECTION TO BE CUT INTO PARTIAL 24"x24" CEILING TILE. GRILLE SHALL NOT BE PROVIDED WITH LAY-IN PANEL. PROVIDE SUPPLEMENTAL ANGLE BRACING BEHIND GRILLE TO PREVENT SAGGING OF CEILING TILE. BALANCE AIR DEVICE FOR 40 CFM.
- 9"X9" TITUS TDC-AA CEILING GRILLE WITH 7"Ø CONNECTION WITH 24"X24" LAY-IN PANEL. BALANCE AIR DEVICE FOR 150 CFM.
- 9"X9" TITUS TDC-AA CEILING GRILLE WITH 7"Ø CONNECTION WITH 24"X24" LAY-IN PANEL. BALANCE AIR DEVICE FOR 40 CFM.
- 6"x6" TITUS 350 FL EXHAUST GRILLE WITH BALANCING DAMPER TO BE CUT INTO PARTIAL 24"X24" CEILING TILE. GRILLE SHALL NOT BE PROVIDED WITH LAY-IN PANEL. PROVIDE SUPPLEMENTAL ANGLE BRACING BEHIND GRILLE TO PREVENT SAGGING OF CEILING TILE. BALANCE AIR DEVICE FOR 50 CFM.
- 5 CONNECT NEW 10x8 EXHAUST DUCT TO EXISTING EXHAUST TRUNK DUCT. TRANSITION NEW DUCT AS NECESSARY FOR CONNECTION TO EXISTING DUCT.
- 6 PROVIDE NEW 10x4 BRANCH EXHAUST DUCT TO NEW EXHAUST GRILLE.
- 7 PROVIDE NEW 10x8 BRANCH EXHAUST DUCT TO NEW EXHAUST GRILLES.
- 8 NEW 1/2" HOT WATER SUPPLY AND RETURN PIPING TO NEW VAV BOX. CONNECT TO EXISTING MAINS. FIELD VERIFY A SUITABLE LOCATION FOR CONNECTION OF NEW TO EXISTING.

9 NEW VAV BOX. INSTALL IN A LOCATION WHERE ACCESS THROUGH CEILING TILE IS AVAILABLE. COORDINATE FINAL INSTALLATION LOCATION WITH ARCHITECTURAL PLANS AND FINAL LIGHTING LAYOUT. EXTEND NEW MEDIUM PRESSURE BRANCH DUCT WITH NEW TAP FROM EXISTING MEDIUM PRESSURE DUCT GENERALLY WHERE SHOWN. FIELD VERIFY A SUITABLE LOCATION FOR CONNECTION OF THE NEW BRANCH TAP.





One Houston Street
Mobile, Alabama 36606
TEL 251.433.9600

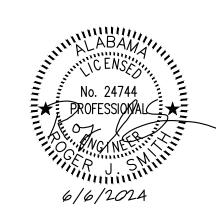

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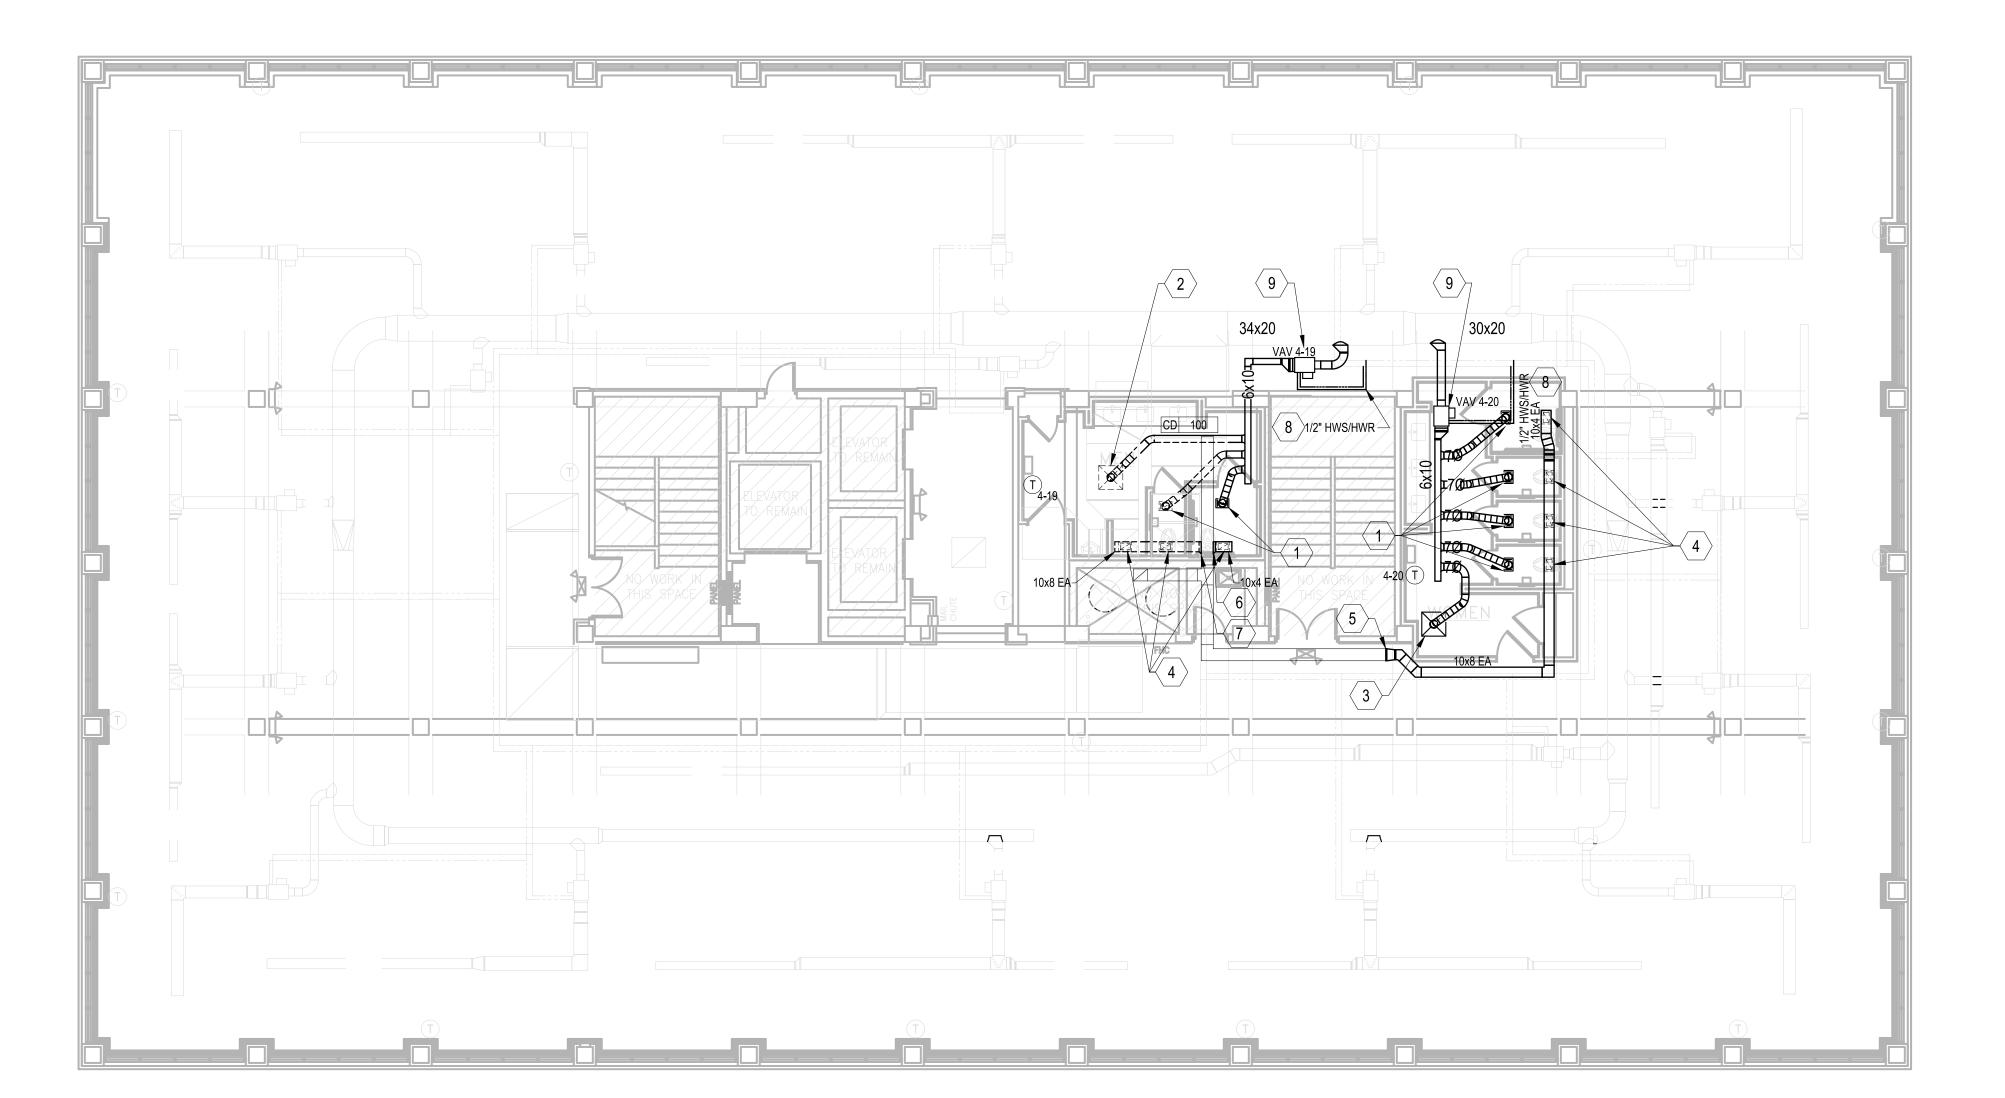
4th FLOOR
HVAC NEW
WORK PLAN


PROJECT NO. 2024-01

DATE
JUNE 6, 2024


SHEET NO.


M3.0



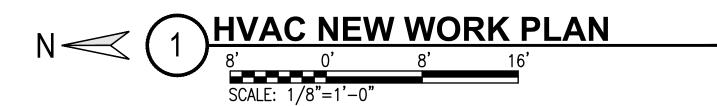



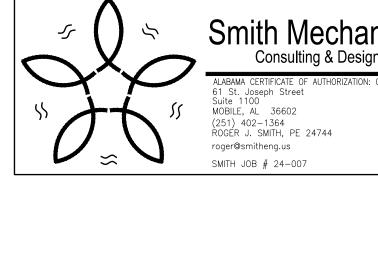

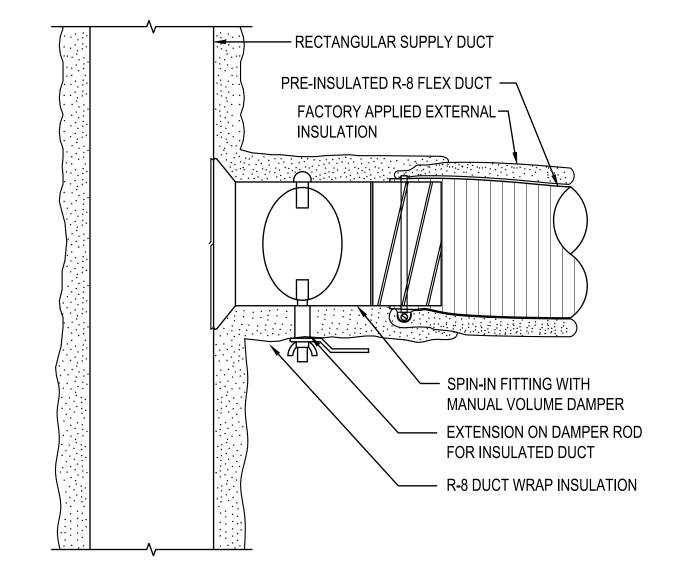

CONNECT FLEXIBLE DUCT TO FITTING WITH DRAWBAND AND SEALER. ROUND HARD DUCT RUNOUTS SHOULD START WITH SPIN-IN FITTINGS SIMILAR TO THIS DETAIL.

SEE PLAN FOR LAY-IN PANEL REQUIREMENTS TYPICAL CEILING DIFFUSER DETAIL TYPICAL FLEX DUCT TAKEOFF DETAIL

RADIUS = 1.5 x —

DUCT DIAMETER

PULL VAPOR BARRIER BACK AND— CLAMP TIGHTLY WITH PANDUIT

STRAP. PULL DUCT INSULATION

OVER CONNECTION AND BUTT FIRMLY AGAINST DIFFUSER BODY

TAPE JACKET.

NOTES:
FLEX DUCT SHALL BE NO LONGER THAN 5'-0".

PROVIDE BEVELED MOUNTING FRAME FOR

DIFFUSERS IN HARD CEILINGS.

LAY IN CEILINGS.

CEILING DIFFUSER


PROVIDE 24"x24" LAY IN PANEL FOR DIFFUSERS IN

- EXTERNALLY INSULATED ACOUSTIC


R-8 BLANKET INSULATION. LAY OVER

ENTIRE BACK OF DIFFUSER BODY.

DUCTWORK. INSTALL DUCTWORK WITH SEALER AND PANDUIT STRAP

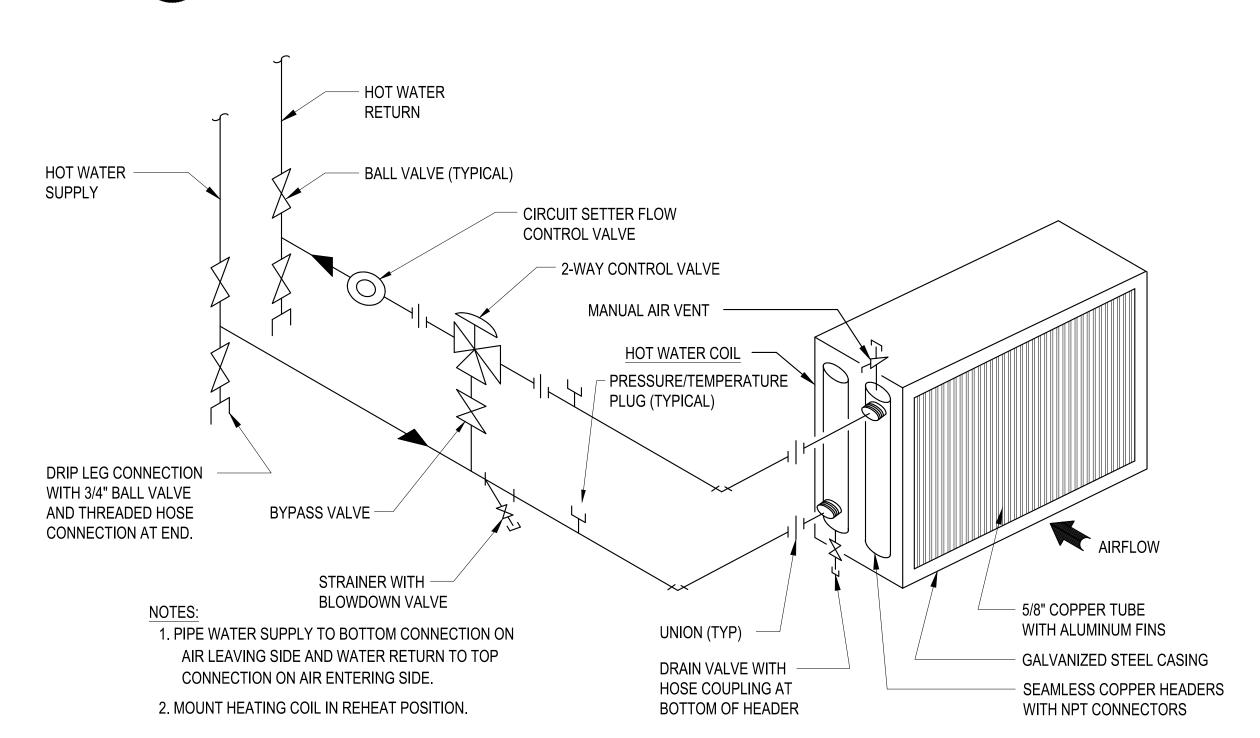



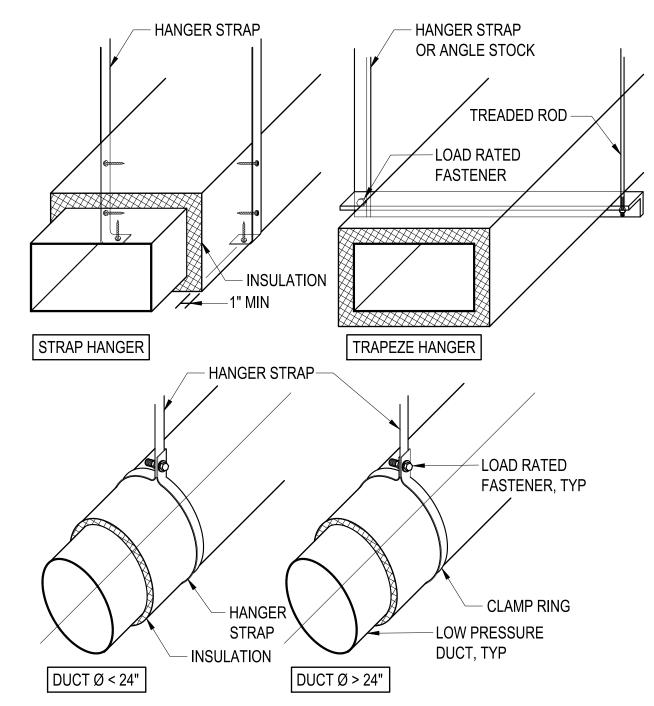


3 DUCT HANGER DETAIL

NOT TO SCALE



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AUTHORITY
A - PHASE 1
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SHEET NAME HVAC **DETAILS**

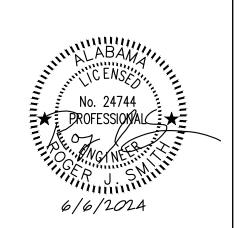PROJECT NO. 2024-01 DATE

JUNE 6, 2024 SHEET NO.

M4.0

ELECTRICAL SPECIFICATIONS

GENERAL ELECTRICAL:

- THE CONTRACTOR SHALL FURNISH ALL LABOR, MATERIALS AND EQUIPMENT NECESSARY FOR THE INSTALLATION OF A COMPLETE ELECTRICAL SYSTEM AS INDICATED WITHIN THESE DRAWINGS. ALL WORK SHALL BE INSTALLED IN STRICT ACCORDANCE WITH ALL APPLICABLE CODES AND ORDINANCES AND WITH MANUFACTURER'S RECOMMENDATIONS.
- THE CONTRACTOR SHALL CAREFULLY EXAMINE THE ARCHITECTURAL, STRUCTURAL, ELECTRICAL AND MECHANICAL DRAWINGS PRIOR TO SUBMITTING HIS BID. THE CONTRACTOR WILL BE REQUIRED TO FURNISH, INSTALL AND CONNECT ALL ITEMS AS INDICATED ON THE DRAWINGS
- THE ARCHITECT SHALL BE NOTIFIED OF ANY CONFLICTS, OR INTERFERENCES THAT OCCUR BETWEEN 1.3. INDIVIDUAL DRAWINGS.
- ALL MATERIALS AND EQUIPMENT SHALL BE INSTALLED IN A NEAT, FIRST CLASS, WORKMANLIKE MANNER, TO THE APPROVAL OF THE ARCHITECT/ENGINEER AND GOVERNING AUTHORITIES
- IN ADDITION TO THE MANUFACTURERS STANDARD GUARANTEES, THE CONTRACTOR SHALL GUARANTEE ALL MATERIALS, EQUIPMENT AND WORKMANSHIP AGAINST DEFECTS FOR ONE YEAR FROM THE DATE OF FINAL ACCEPTANCE, AND SHALL CORRECT ANY DEFECTS AT NO ADDITIONAL COST TO THE OWNER. ALL LAMPS SHALL BE GUARANTEED FOR 30 DAYS AFTER ACCEPTANCE.
- THE LOADS SHOWN FOR APPLIANCES AND EQUIPMENT ARE BASED ON DESIGN INFORMATION. THE CONTRACTOR SHALL VERIFY ALL APPLIANCE LOADS PRIOR TO RUNNING THE CIRCUIT. THE MINIMUM CIRCUIT REQUIREMENTS SHALL BE BASED ON THE APPLIANCE NAMEPLATE VALUE OR CODE REQUIREMENTS, WHICHEVER IS MORE STRINGENT. ADDITIONAL COMPENSATION SHALL NOT BE ALLOWED FOR APPLIANCE MODIFICATIONS BY THE CONTRACTOR.
- PRIOR APPROVAL: PRIOR APPROVAL SHALL BE REQUIRED FOR ANY MANUFACTURER OTHER THAN THOSE LISTED FOR ALL SPECIFIED ITEMS IN THESE DRAWINGS. SUBMIT ALL REQUESTS FOR PRIOR APPROVAL 2 WEEKS PRIOR TO BID OPENING. ENGINEER'S APPROVAL WILL BE IN THE FORM OF AN ADDENDUM.

CODES & STANDARDS:

- 2.1. INSTALLATION AND MATERIALS SHALL COMPLY WITH THE LATEST ADOPTED EDITION OF THE FOLLOWING **CODES & STANDARDS:**
- NATIONAL ELECTRICAL CODE.
- NFPA 72. NATIONAL FIRE PROTECTION CODE.
- 2.1.3. INTERNATIONAL BUILDING CODE.
- INTERNATIONAL ENERGY CONSERVATION CODE 2.1.4.
- 2.1.5. NFPA 101.
- 2.1.6.
- 2.1.7.
- 2.1.8. NEMA.
- 2.1.9. 2.1.10.
- ALTERATIONS & ADDITIONS TO EXISTING WORK:
- PROVIDE ALL NECESSARY ADDITIONS AND ALTERATIONS TO EXISTING WORK AS REQUIRED TO PROVIDE AND MAINTAIN A COMPLETE AND PROPER ELECTRICAL INSTALLATION
- AS NECESSARY, RELOCATE EXISTING ELECTRICAL WORK SO OTHER TRADES CAN PURSUE THEIR WORK. MAINTAIN POWER TO EXISTING PORTIONS OF BUILDINGS FED FROM OR THROUGH AREA IN SCOPE OF THIS 3.3.
- COORDINATE ALL REQUIRED OUTAGES WITH OWNER.

4. BASIC MATERIALS & METHODS:

- ALL POWER AND DISTRIBUTION CABLING SHALL BE COPPER TYPE THWN/THHN (NM NOT ALLOWED)
- ELECTRICAL CONTRACTOR SHALL PROVIDE ADEQUATE AND PROPER SUPPORT FOR ALL ELECTRICAL OUTLETS, DEVICES, LIGHT FIXTURES, ETC, BUILT IN OR MOUNTED ON CEILINGS, NO OUTLET BOX, DEVICE, LIGHT FIXTURE, ETC. SHALL BE SUPPORTED FROM ANY ACOUSTICAL CEILING TILE OR DRYWALL CEILINGS. PROVIDE METAL SUPPORTS THAT ARE MADE FOR USE WITH CEILING GRID SYSTEMS OR PROVIDE HANGERS FROM STRUCTURE ABOVE.
- CONDUIT ROUTINGS AND DEVICE / EQUIPMENT LOCATIONS SHOWN ARE DIAGRAMMATIC ONLY, CONTRACTOR SHALL FIELD ROUTE AND LOCATE AS REQUIRED, CONDUIT ROUTINGS SHALL BE PARALLEL OR PERPENDICULAR TO BUILDING LINES.
- JUNCTION BOXES LOCATED ABOVE CEILING SHALL BE INSTALLED FACING DOWN AND SHALL BE ACCESSIBLE AFTER INSTALLATION.
- COORDINATE ALL ELECTRICAL WORK WITH OTHER TRADES AND STRUCTURAL COMPONENTS.
- THE CONDUIT MATERIAL SHALL BE AS FOLLOWS:
- ABOVE GRADE SUBJECT TO PHYSICAL ABUSE RGS.
- ABOVE GRADE NOT SUBJECT TO PHYSICAL ABUSE OR WEATHER EMT. 4.6.2.
- INDOORS NOT SUBJECT TO PHYSICAL ABUSE EMT. OR METAL CLAD CABLE (AS ALLOWED BY LOCAL AUTHORITY HAVING JURISDICTION AND NO MC CABLE IS TO BE INSTALLED WHERE IT WILL BE EXPOSED).

FINAL CONDUIT CONNECTIONS TO HEAT PUMPS, AIR HANDLERS, EXHAUST FANS, AND WATER HEATERS SHALL BE LFMC WHETHER INTERIOR OR EXTERIOR.

- CONDUIT FITTINGS SHALL BE AS FOLLOWS:
- 4.7.1. EMT - <=2" USE STEEL SET SCREW WITH INSULATED THROATS FOR INTERIOR/ USE COMPRESSION FITTINGS WITH INSULATED THROATS FOR EXTERIOR, >2" USE SET-SCREW STEEL WITH INSULATED
- RGS THREADED GALVANIZED STEEL
- 4.7.3. PVC - PVC APPROVED FOR THE USE. 4.7.4. FMC - ZINC-PLATED STEEL OR CADMIUM-PLATED MALLEABLE IRON SCREW TYPE WITH INSULATED
- LFMC CADMIUM-PLATED MALLEABLE IRON OR STEEL COMPRESSION TYPE WITH INSULATED THROAT. ALL OUTLET BOXES SHALL BE 4"X4"X1-1/2" DEEP MINIMUM
- ELECTRICAL CONTRACTOR SHALL WORK CLOSELY WITH THE MASONRY CONTRACTOR ON THE 4.9. INSTALLATION OF ALL ELECTRICAL BOXES, CABINETS, RINGS, ETC. IN MASONRY WALLS. THE BOXES SHALI BE INSTALLED AT THE UNIFORM HEIGHTS CALLED FOR ON THE DRAWINGS AND SPECIFICATIONS. PROVIDE APPROPRIATE DEPTH MASONRY RINGS FOR ALL OUTLETS IN MASONRY WALLS TO INSURE PROPER CUTTING AND FITTING. THE FACE OF THE CABINETS, BOXES, RINGS, ETC. SHALL BE PLUMB AND FLUSH WITH THE FACE OF THE FINISH MATERIAL. ANY CABINET, OUTLET BOX, ETC. NOT MEETING THE ABOVE REQUIREMENT SHALL BE REMOVED AND REINSTALLED AT NO ADDITIONAL COST TO THE OWNER.
- ALL DIMENSIONS TO DEVICES AFF SHALL BE TO CENTERLINE UNLESS NOTED OTHERWISE.
- WALL OUTLETS SHALL NOT BE INSTALLED BACK TO BACK
- COORDINATE LOCATIONS OF ELECTRICAL EQUIPMENT, DEVICES, OUTLETS, FIXTURES, ETC., WITH ARCHITECTURAL PLANS, ELEVATIONS AND REFLECTED CEILING PLANS PRIOR TO ROUGH-IN WORK.

GROUNDING & BONDING:

- PROVIDE AN INSULATED EQUIPMENT GROUNDING CONDUCTOR IN ALL CONDUITS.
- ALL CABLES SHALL BE COPPER, ALL BOLTED CONNECTIONS SHALL BE BRONZE.
- WHERE AVAILABLE, BOND TO BUILDING STRUCTURAL STEEL, BUILDING FOUNDATION STEEL, METAL WATER SERVICE PIPING.

IDENTIFICATION:

- PROVIDE ENGRAVED 1"X3" PHENOLIC LABELS FOR ALL PANELBOARDS, SAFETY SWITCHES, TRANSFORMERS
- PAINT THE RACEWAY SYSTEM COUPLINGS AND BOX COVERS ABOVE CEILINGS FOR THE FOLLOWING SYSTEMS AS FOLLOWS:
- FIRE ALARM RED.
- 208 VOLT SYSTEMS BLACK.
- 480 VOLT SYSTEMS BROWN
- AFTER PAINTING, WRITE THE CIRCUIT NUMBER (I.E. "LPA-34") ON ALL BRANCH CIRCUIT JUNCTION BOX COVERS ABOVE CEILING WITH WHITE MARKER.

GENERAL WIRING DEVICES:

- SWITCHES SPECIFICATION GRADE, 20 AMP, COLOR BY ARCHITECT
- RECEPTACLES SPECIFICATION GRADE, 20 AMP, NEMA 5-20R, COLOR BY ARCHITECT.

SAFETY SWITCHES:

- 8.3. INTERIOR - NEMA 1.

9. PANELBOARDS:

- BAR, FULLY RATED (SERIES RATING NOT ALLOWED).
- INTERIOR NEMA 1. 9.2.
- PROVIDE UPDATED TYPE-WRITTEN DIRECTORY IN CLEAR SLEEVE ON INSIDE OF DOOR.
- APPROVED MANUFACTURERS SQUARE D, GENERAL ELECTRIC, SIEMENS.

- 10.1. PROVIDE A 6'-0" MAXIMUM FLEXIBLE CONNECTION FROM EACH RECESSED LIGHTING FIXTURE TO JUNCTION BOX ABOVE CEILING.
- 10.2. FOR FIXTURES IN LAY-IN CEILINGS, PROVIDE WIRE SUPPORTS AT ALL FOUR CORNERS OF FIXTURE SEPARATE FROM LAY-IN CEILING WIRE SUPPORTS

ABBREVIATION) JAGUARE'		
AMPS	MCM	THOUSAND CIRCULAR MILS	CHRISTINA MARIE P.E. PE 50660 - ECA 50377
ABOVE COUNTER	MH	MANHOLE	C: (251) 455-9189
AMP FRAME	MIN	MINIMUM	JaguarEngineers@Yahoo.Com
ABOVE FINISHED FLOOR	MISC	MISCELLANEOUS	
ABOVE FINISHED GRADE	MLO	MAIN LUGS ONLY	
AIR HANDLING UNIT	MNT	MOUNTING HEIGHT	
ALUMINUM	MTG	MOUNTING	
ARCHITECT OR ARCHITECTURAL	MTS	MANUAL TRANSFER SWITCH	
AMP TRIP	MV	MEDIUM VOLTAGE	
AUTOMATIC TRANSFER SWITCH	N1	NEMA 1	
AIR TERMINAL UNIT	N3R	NEMA 3R	
AMERICAN WIRE GAUGE	N/A	NOT APPLICABLE	
BUILDING AUTOMATION SYSTEM	NA	NOT APPLICABLE	
BELOW FINISHED GRADE	NEC	NATIONAL ELECTRICAL CODE	
BONDING JUMPER	NESC	NATIONAL ELECTRICAL SAFETY O	CODE
CIRCUIT BREAKER	NEU	NEUTRAL	
BUILDING	OCPD	OVERCURRENT PROTECTION DE	VICE
BASIS OF DESIGN	OFOI	OWNER FURNISHED OWNER INST	
CONDUIT	OFCI	OWNER FURNISHED CONTRACTO	OR INSTALLED
CIRCUIT BREAKER	ОН	OVERHEAD	
CURRENT LIMITING	OHE	OVERHEAD ELECTRIC	
CENTERLINE	OHP	OVERHEAD PRIMARY	
CEILING	OHS	OVERHEAD SECONDARY	
CIRCUIT	PBD	PANELBOARD	
CURRENT TRANSFORMER	PF	POWER FACTOR	
COPPER	PNL	PANELBOARD	
DIRECT DIGITAL CONTROL	PT	POTENTIAL TRANSFORMER	
DEMOLISH	PWR	POWER	
ELECTRICAL CONTRACTOR	REC	RECEPTACLE	
EQUIPMENT GROUNDING CONDUCTOR	REQD	REQUIRED	
ELECTRICAL	RM	ROOM	
ELECTRICAL MAIN GROUNDING BUSBAR	RGS	RIGID GALVANIZED STEEL CONDU	UIT
EXHAUST FAN	RNC	RIGID NON-METALLIC CONDUIT	
EXISTING TO REMAIN	RVSS	REDUCED VOLTAGE SOLID STATE	E
EXTERIOR	SA	SURGE ARRESTER	
ELECTRIC WATER COOLER	SCA	SHORT CIRCUIT AMPS	
	0-	0110011/1011	

SWGR

SUPPLY FAN

SPECIFICATION

SWITCHBOARD

SWITCHGEAR

OHMS

TELECOMMUNICATIONS BONDING BACKBONE

- COVER PLATES NYLON, COLOR BY ARCHITECT.
- APPROVED MANUFACTURERS HUBBELL, LEVITON, EAGLE, PASS & SEYMOUR.

- GENERAL DUTY, VISIBLE BLADE, LOCKABLE, QUICK-MAKE/QUICK-BREAK, HORSEPOWER RATED, FUSED WHERE INDICATED.
- PROVIDE WITH GROUND LUG KIT.
- APPROVED MANUFACTURERS SQUARE D, GENERAL ELECTRIC, SIEMENS

- FRONT ACCESSIBLE, BOLT-ON MOLDED CASE C/Bs, COPPER PHASE & NEUTRAL BUSSING, COPPER GROUND

10. LIGHTING:

FIRE ALARM TR TELECOMMUNICATIONS ROOM FULL LOAD AMPS TELECOMMUNICATIONS GROUNDING BUSBAR FLOOR TELECOMMUNICATIONS MAIN GROUNDING BUSBAR **TVSS** FULL VOLTAGE NON-REVERSING TRANSIENT VOLTAGE SURGE SUPPRESSION GROUND FAULT INTERRUPTER TYP TYPICAL GROUND (OR GFI FOR RECEPTACLE SUBSCRIPT) UFR UNDERFLOOR RACEWAY GENERAL CONTRACTOR UNDERGROUND GROUND UNDERGROUND ELECTRIC GROUNDING ELECTRODE CONDUCTOR UNDERGROUND PRIMARY **HANDHOLE** UNDERGROUND SECONDARY HAND-OFF-AUTOMATIC UNDERWRITERS' LABORATORIES HEAT PUMP OR HORSEPOWER UNLESS NOTED OTHERWISE HEATING, VENTILATION & AIR-CONDITIONING UNINTERRUPTIBLE POWER SUPPLY ISOLATED GROUND **VOLT-AMPERES** INTERMEDIATE METAL CONDUIT **VOLT-AMPERES REACTIVE** JUNCTION BOX VARIABLE AIR VOLUME UNIT KILO-AMPERE INTERRUPTING CAPABILITY WATTS THOUSAND CIRCULAR MILS **WORK AREA OUTLET** LIGHTING CONTROL PANEL WEATHERPROOF LIGHTING WITHSTAND RATING TRANSFORMER LIQUID TIGHT FLEXIBLE METAL CONDUIT LOW VOLTAGE EXPLOSION PROOF MAXIMUM PHASE MINIMUM CIRCUIT AMPACITY **DEGREES** MOTOR CONTROL CENTER DELTA

One Houston Street Mobile, Alabama 36606 Tel 251.433.9600 **PROFESSIONAL** O. NGINEE!

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SHEET NAME

ELECTRICAL LEGEND AND **SPECIFICATIONS**

PROJECT NO.

DATE JUNE 06, 2024

SHEET NO.

ACTUAL SHEET SIZE IS 22" x 34"

► ROUGH-IN FOR COMMUNICATIONS OUTLET (CO). MOUNT ON WALL AT 18" AFF UNLESS SUBSCRIPTED OTHERWISE. INCLUDE 1" EMT FROM ROUGH-IN BOX STUBBED ABOVE CEILING. TERMINATE WITH BUSHING (ON BOTH ENDS) AND PROVIDE PULL STRING.

\$ SINGLE POLE LIGHTING SWITCH. MOUNT 48" TO TOP OF BOX AFF UNLESS NOTED OTHERWISE. SUBSCRIPT

DUPLEX RECEPTACLE NEMA 5-20R. MOUNT 18" AFF UNLESS NOTED OTHERWISE. VERIFY DUPLEX MOUNTING

REQUIREMENTS WITH ARCHITECTURAL DRAWINGS PRIOR TO ROUGH-IN. SUBSCRIPT INDICATES AS

M - 30 AMP TWO POLE MOTOR RATED SWITCH MOUNTED AT THE EQUIPMENT. PROVIDE PHENOLIC LABEL

MAIN COMMUNICATIONS EQUIPMENT ROOM

DISTRIBUTION & POWER EQUIPMENT:

GENERAL ELECTRICAL DEVICES:

INDICATES AS FOLLOWS:

FOLLOWS:

DEMO

EGC

EXT

EMT

EQUIP

FACP

GND

kCMIL

LCP

MAX

MCE

ELECTRICAL METALLIC TUBING

FIRE ALARM SYSTEM CONTROL PANEL

FLEXIBLE METAL CONDUIT

EQUIPMENT

FUSE

PANELBOARD, MOUNT AS INDICATED, SEE PANELBOARD SCHEDULES.

G - GROUND FAULT CIRCUIT INTERRUPTER TYPE.

84" - MOUNTING HEIGHT OF DEVICE AFF.

21 - # INDICATES PANELBOARD CKT NUMBER

ELECTRICAL LEGEND

ÆP EXHAUST FAN. JUNCTION BOX.

MISCELLANEOUS EQUIPMENT

E ELECTRICAL CONNECTION TO EQUIPMENT. VERIFY LOCATION WITH EQUIPMENT PROVIDER.

FIRE ALARM SYSTEM:

- FIRE ALARM SYSTEM ADDRESSABLE SINGLE ACTION MANUAL PULL STATION. MOUNT 48" TO TOP OF
- FIRE ALARM SYSTEM AUDIO-VISUAL ALARM. MOUNT 80" AFF TO BOTTOM OF LENS OR 6" FROM THE CEILING, WHICHEVER IS LOWER. ALL STROBES SHALL BE SYNCHRONIZED.
- FIO- FIRE ALARM SYSTEM VISUAL ONLY APPLIANCE. MOUNT 80" AFF TO BOTTOM OF LENS OR 6" FROM THE CEILING, WHICHEVER IS LOWER. ALL STROBES SHALL BE SYNCHRONIZED.
- S FIRE ALARM SYSTEM ADDRESSABLE PHOTOELECTRIC SMOKE DETECTOR. CEILING MOUNT.

LIGHTING FIXTURES

SEE LIGHTING FIXTURE SCHEDULE FOR SYMBOLS AND DESCRIPTIONS. THE FIXTURE MARK IN AN ENCLOSED SPACE WITH SIMILAR FIXTURES WILL APPLY TO ALL FIXTURES IN THE SPACE

OTHER:

CIRCUIT RUN CONCEALED ABOVE CEILING OR IN WALL

CIRCUIT RUN CONCEALED IN OR BELOW FLOOR SLAB OR UNDERGROUND.

HOMERUN TO PANELBOARD. ANY CIRCUIT WITHOUT FURTHER DESIGNATION SHALL BE 2#12,#12G,3/4"C. TICK MARKS INDICATE # OF CONDUCTORS (EGC NOT SHOWN). MINIMUM SIZE ON 120V HOMERUNS GREATER THAN 50 FEET SHALL BE #10 AWG. MINIMUM SIZE ON 120V HOMERUNS GREATER THAN 100 FEET SHALL BE #8 AWG. MINIMUM SIZE ON 120V HOMERUNS GREATER THAN 160 FEET SHALL BE #6 AWG. MINIMUM SIZE ON 277V HOMERUNS GREATER THAN 100 FEET SHALL BE #10 AWG. INCREASE CONDUIT SIZE AS REQUIRED PER NEC. UNDERLINED TEXT INDICATES CIRCUIT DESIGNATION.

 \searrow \swarrow LOW VOLTAGE CABLE AS SPECIFIED BY THE MANUFACTURER.

OCCUPANCY SENSORS:

- D) WALL MOUNTED LINE VOLTAGE DUAL TECHNOLOGY SWITCH WITH SINGLE RELAY. MOUNT 48" AFF UNLESS NOTED OTHERWISE. SWITCH SHALL BE PROGRAMMED TO BE MANUAL ON.
- CEILING MOUNTED LOW VOLTAGE 360° DUAL TECHNOLOGY (PASSIVE INFRARED & ULTRASONIC) OCCUPANCY SENSOR.
- PP DIMMING POWER PACK. PROVIDE WITH NEMA 1 ENCLOSURE.







ALABAMA STATE PORT AUTHORITY

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4th FLOOR LTG PLAN - DEMOLITION

PROJECT NO.

DATE


D A T E JUNE 06, 2024

SHEET NO.

E2.0

2024-1

ACTUAL SHEET SIZE IS 22" x 34"

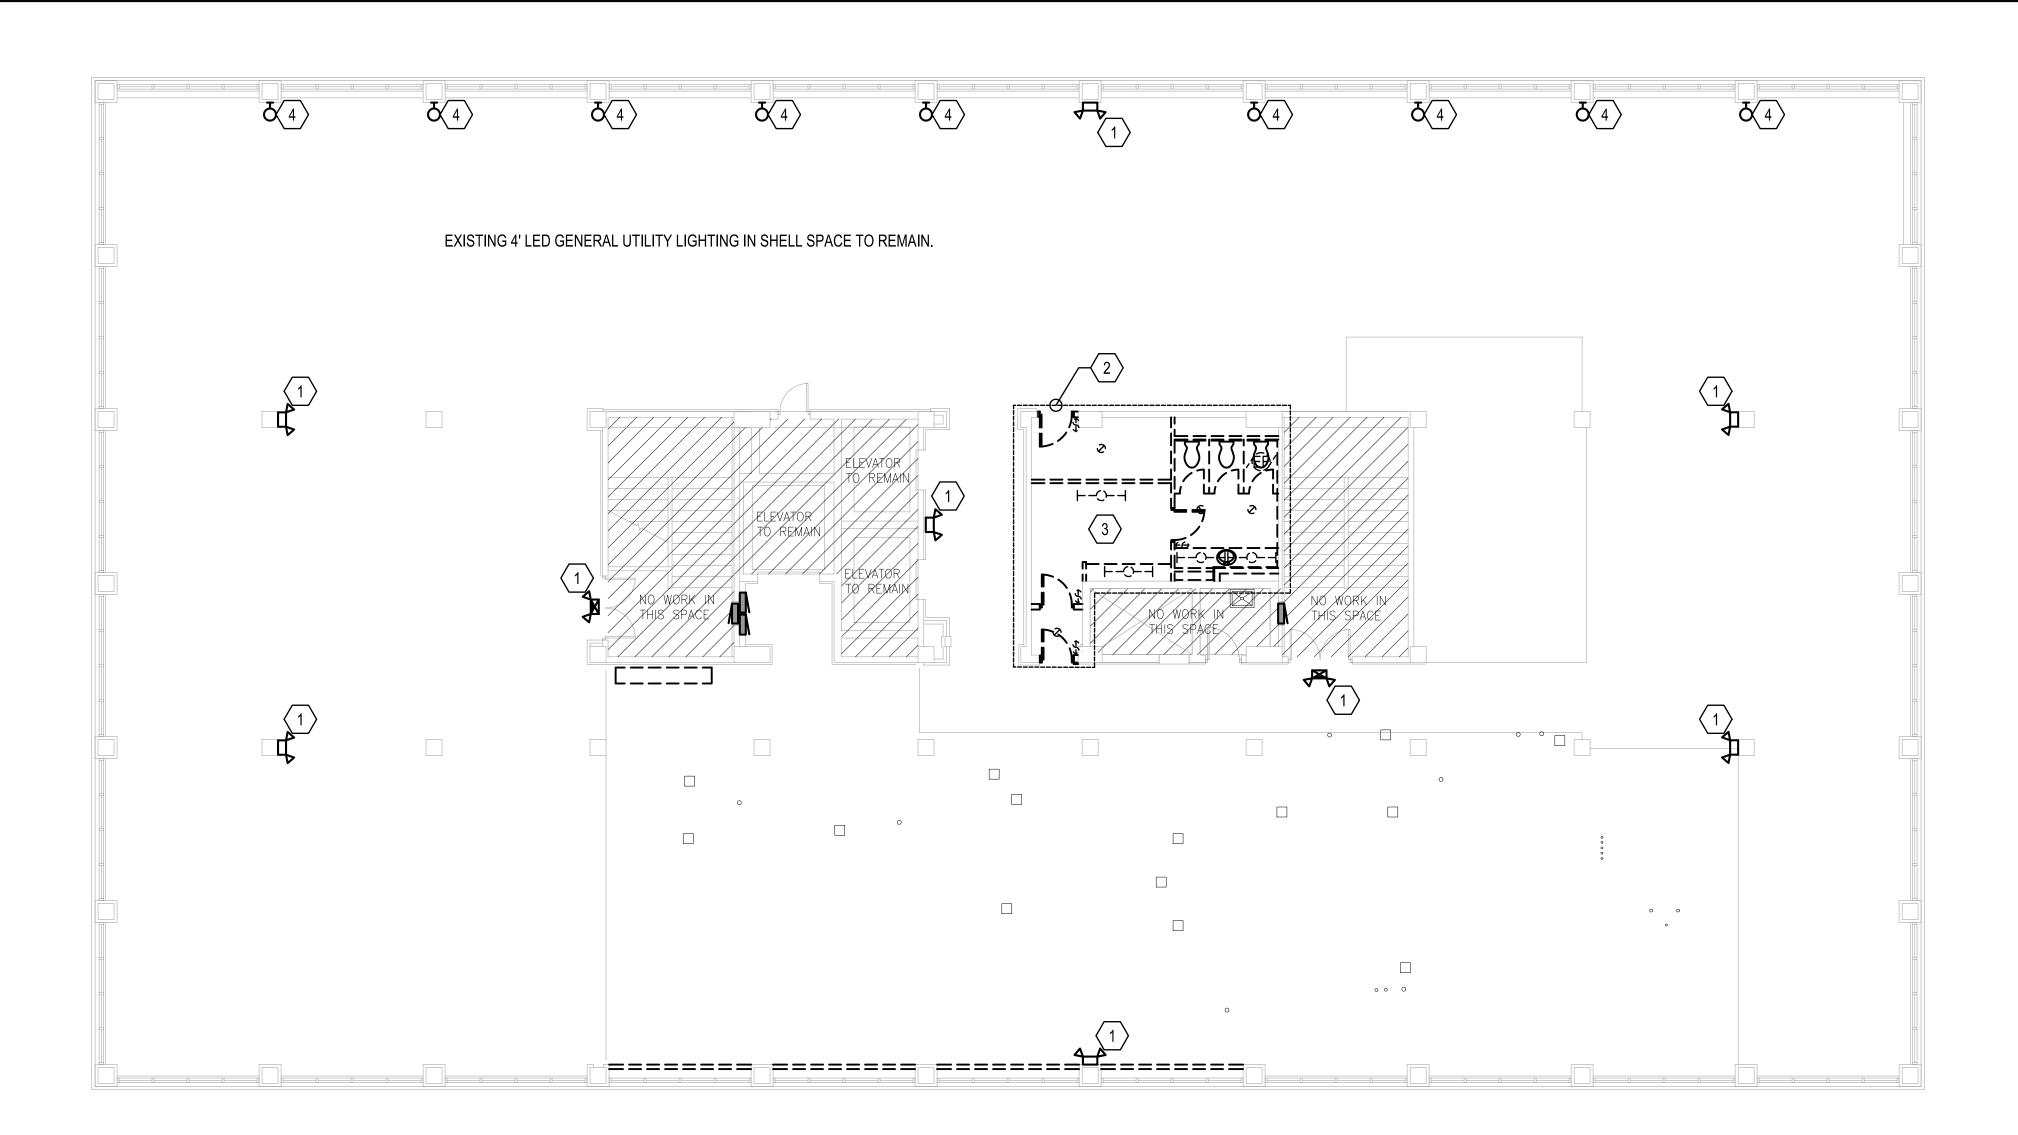


EXISTING WORK GENERAL NOTES

- 1. THE CONTRACTOR SHALL VISIT THE SITE TO FAMILIARIZE THEMSELVES WITH THE SCOPE OF WORK <u>PRIOR</u> TO SUBMITTING A BID. IT IS THE RESPONSIBILITY OF THE CONTRACTOR TO UNDERSTAND AND PROVIDE AND INSTALL ALL NECESSARY COMPONENTS TO FULFILL THE INTENT OF THE CONTRACT DOCUMENTS (INCLUDING BUT NOT LIMITED TO SUPPORTS, BRACING, PATCHING, ETC.).
- 2. THE ELECTRICAL CONTRACTOR SHALL VERIFY ALL WALLS TO BE DEMOLISHED AND TO REMAIN WITH ARCHITECTURAL PLANS PRIOR TO BEGINNING ANY WORK.

EXISTING WORK SHEET NOTES

- 1 EXISTING EMERGENCY EGRESS FIXTURE TO REMAIN. THE CONTRACTOR SHALL ENSURE THE OPERABILITY OF THE FIXTURE AND REPLACE TO MATCH EXISTING IF NOT OPERABLE. FIXTURES LOCATED ON WALLS BEING REFINISHED SHALL BE REMOVED AND PROTECTED DURING THE DEMOLITION PHASE AND REINSTALLED DURING THE NEW WORK PHASE.
- THIS RESTROOM AND ADJACENT STORAGE SPACE IS TO BE COMPLETELY RENOVATED AS A PART OF THIS PROJECT. THE ELECTRICAL CONTRACTOR SHALL COMPLETELY REMOVE ALL LIGHTING FIXTURES AND WIRING DEVICES. THE ELECTRICAL CONTRACTOR SHALL REMOVE ALL ASSOCIATED CONDUIT AND CONDUCTORS BACK TO NEAREST JUNCTION BOX TO REMAIN. PROVIDE NEW FIXTURES AND WIRING DEVICES PER NEW WORK PLANS.
- 3 SECURE AND PREPARE EXISTING LIGHTING CIRCUIT FOR CONNECTION TO NEW FIXTURES AND CONTROLS DURING THE NEW WORK PHASE.
- EXISTING WALL MOUNTED FIXTURE TO BE COMPLETELY REMOVED. REMOVE EXISTING CONDUCTORS BACK TO NEAREST JUNCTION BOX TO REMAIN. PATCH WALL OR PROVIDE BLANK PLATE FOR EXISTING BOX AS DIRECTED BY THE ARCHITECT.

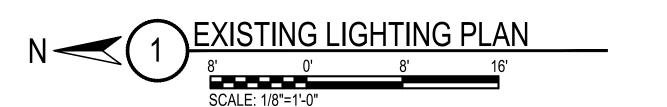








SAMA STATE PORT A

PLOOR INTERIOR
SO N. WATER S 4th FL 250

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SHEET NAME

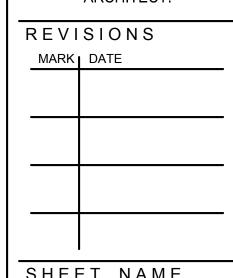4th FLOOR **POWER PLAN** - DEMOLITION

2024-1


PROJECT NO.

DATE

JUNE 06, 2024 SHEET NO.

E3.0

ACTUAL SHEET SIZE IS 22" x 34"

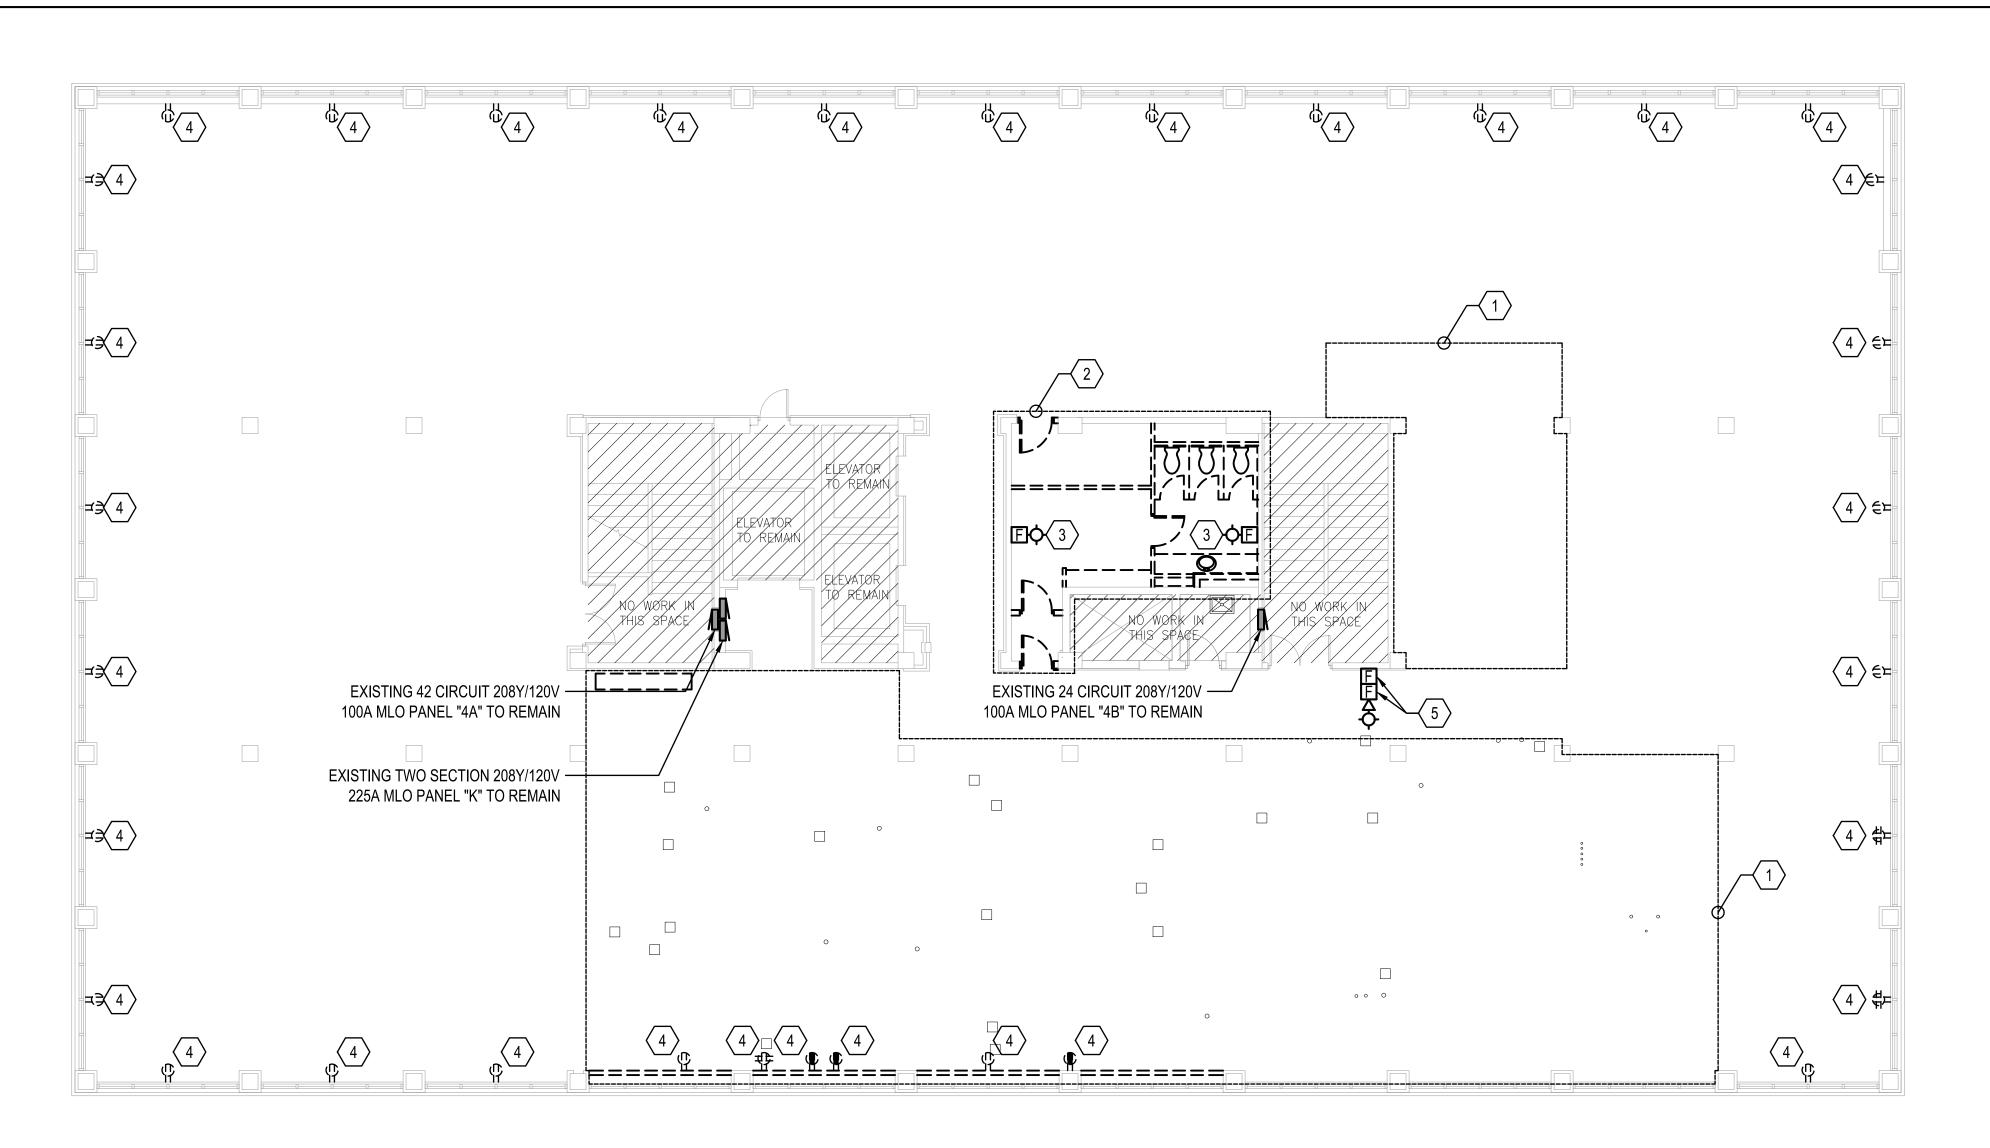


EXISTING WORK GENERAL NOTES

- 1. THE CONTRACTOR SHALL VISIT THE SITE TO FAMILIARIZE THEMSELVES WITH THE SCOPE OF WORK PRIOR TO SUBMITTING A BID. IT IS THE RESPONSIBILITY OF THE CONTRACTOR TO UNDERSTAND AND PROVIDE AND INSTALL ALL NECESSARY COMPONENTS TO FULFILL THE INTENT OF THE CONTRACT DOCUMENTS (INCLUDING BUT NOT LIMITED TO SUPPORTS, BRACING, PATCHING, ETC.).
- 2. THE ELECTRICAL CONTRACTOR SHALL VERIFY ALL WALLS TO BE DEMOLISHED AND TO REMAIN WITH ARCHITECTURAL PLANS PRIOR TO BEGINNING ANY WORK.

EXISTING WORK SHEET NOTES

- 1 THE SLAB IN THIS AREA IS TO BE PREPPED AND RE-POURED AS A PART OF THIS PROJECT BY OTHERS. THERE ARE MULTIPLE LOCATION WHERE EXISTING CONDUIT IS STUBBED UP THROUGH THE EXISTING SLAB. THE ELECTRICAL CONTRACTOR SHALL INVESTIGATE ALL STUB UP CONDUIT LOCATIONS AND PREPARE THEM FOR THE NEW SLAB:
 - 1. THE ELECTRICAL CONTRACTOR SHALL REMOVE ANY EXISTING CONDUCTORS FROM THE EXISTING CONDUITS.
 - 2. THE ELECTRICAL CONTRACTOR SHALL COORDINATE WITH THE GENERAL CONTRACTOR TO ENSURE EXISTING STUB UPS ARE CUT AND CAPPED AS REQUIRED FOR THE NEW SLAB.
- $\overline{2}$ THIS RESTROOM IS TO BE COMPLETELY RENOVATED AS A PART OF THIS PROJECT. THE ELECTRICAL CONTRACTOR SHALL COMPLETELY REMOVE ALL LIGHTING FIXTURES AND WIRING DEVICES. THE ELECTRICAL CONTRACTOR SHALL REMOVE ALL ASSOCIATED CONDUIT AND CONDUCTORS BACK TO NEAREST JUNCTION BOX TO REMAIN. PROVIDE NEW FIXTURES AND WIRING DEVICES PER NEW WORK PLANS.
- (3) EXISTING FIRE ALARM NOTIFICATION DEVICE TO BE REMOVED DURING THE DEMOLITION PHASE AND REINSTALLED PER NEW WORK PHASE.
- 4 EXISTING RECEPTACLE ON PERIMETER WALL TO BE REMOVED AND REPLACED NEW PER NEW WORK PLANS.
- 5 EXISTING FIRE ALARM DEVICE TO BE REMAIN.

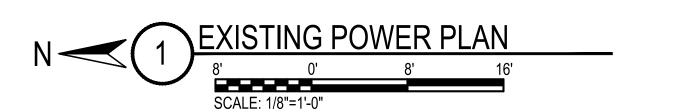







AUTHORITY
- PHASE 1
STREET ALABAMA STATE PORT A 4th FLOOR INTERIOR -250 N. WATER S MOBILE, AL

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REVISIONS
MARK DATE
CHEET NAME

SHEET NAME

4th FLOOR LTG PLAN - NEW WORK

2024-1


PROJECT NO.

DATE

JUNE 06, 2024 SHEET NO.

E4.0

ACTUAL SHEET SIZE IS 22" x 34"

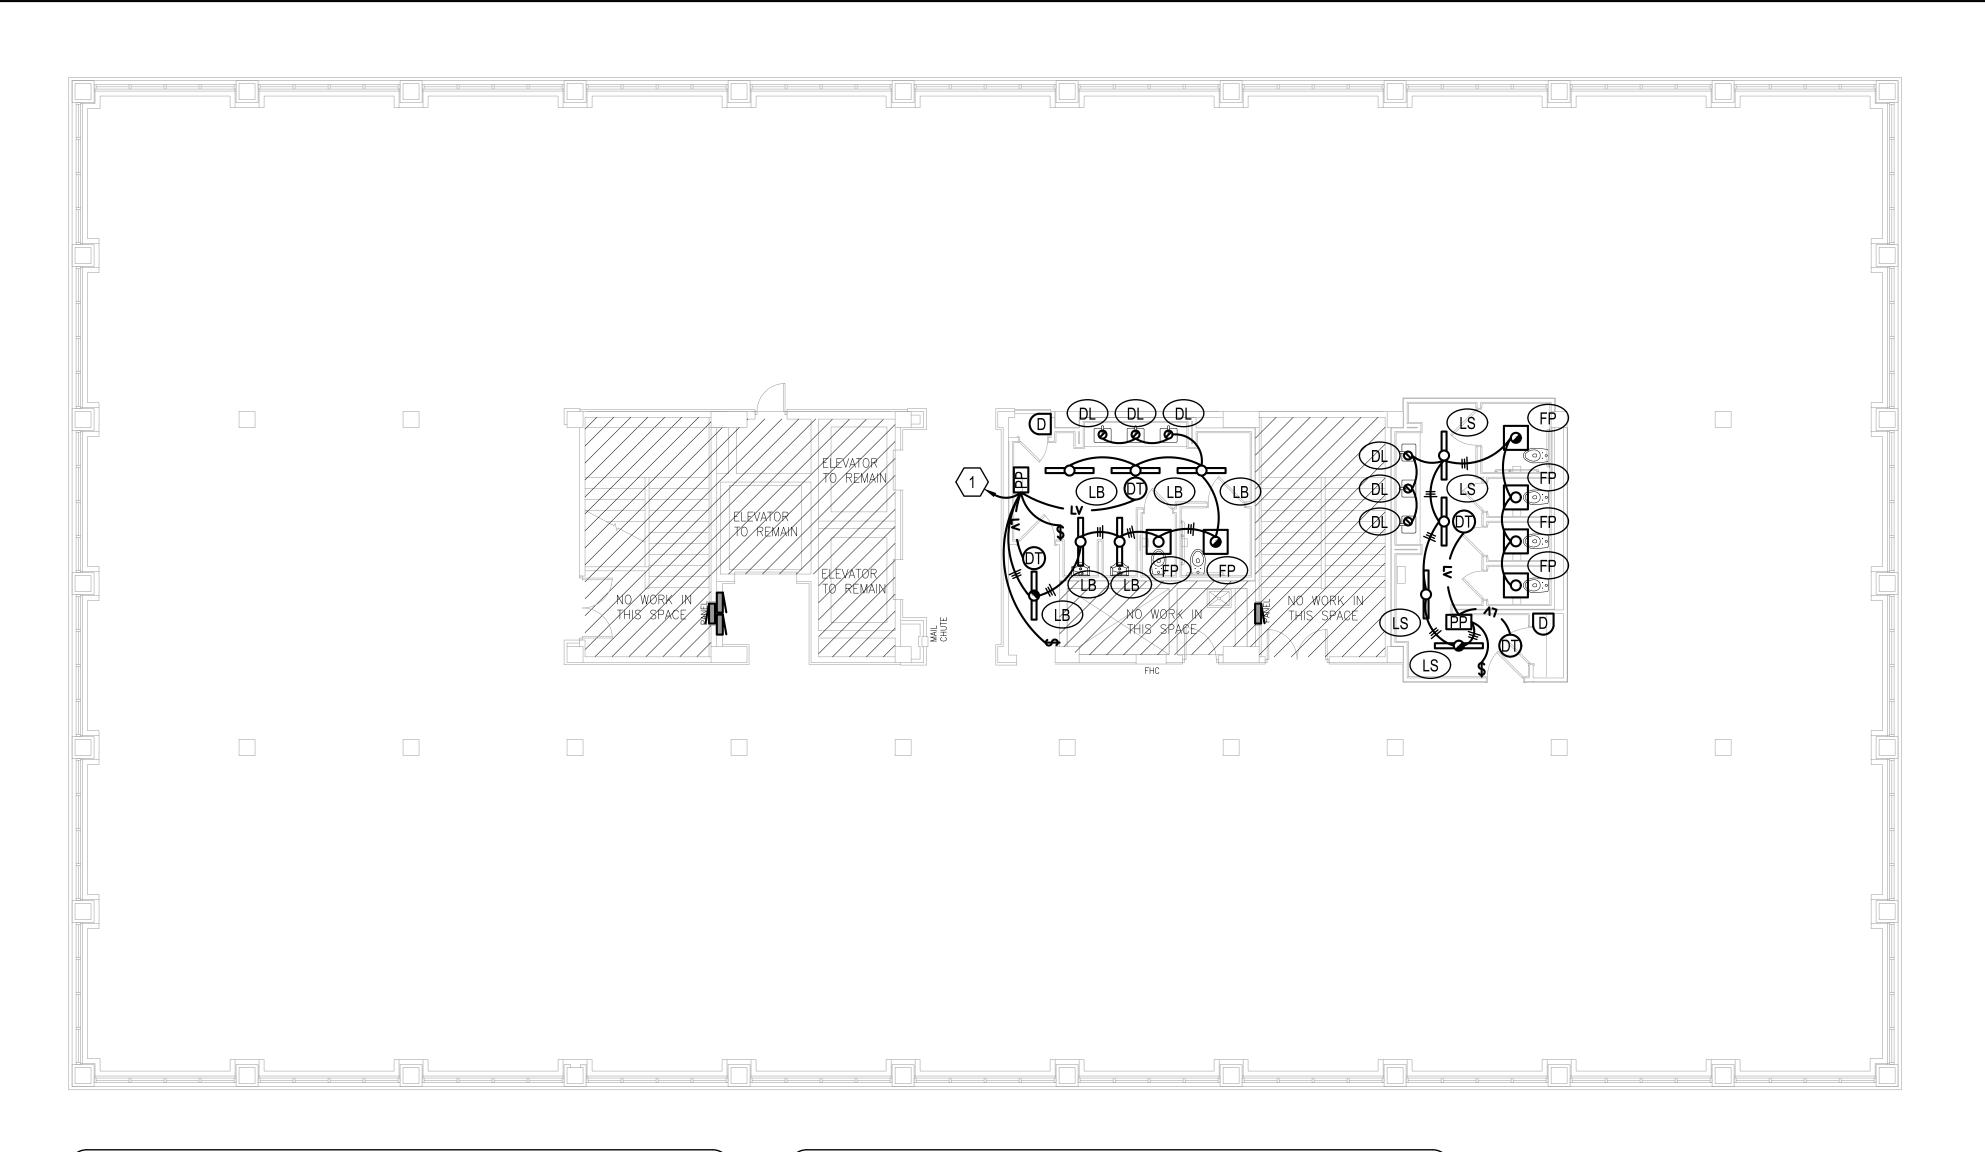


NEW WORK GENERAL NOTES

1. THE FOURTH FLOOR (OUTSIDE THE CORE STAIR / RESTROOM AREA) HAS BEEN GUTTED INTO A SHELL SPACE. EXISTING BREAKERS MADE AVAILABLE DURING THE DEMOLITION OF THE FOURTH ARE TO BE UTILIZED FOR NEW WORK. ALL NEW WORK IS TO BE PROVIDED WITH NEW CONDUIT AND CONDUCTORS. THE CEILING IN THE SHELL SPACE WILL BE EXPOSED AND OPEN TO STRUCTURE, ALL NEW CONDUIT TO EMT AND ROUTED PERPENDICULAR WITH THE BUILDING STRUCTURE IN A NEAT AND WORKMANSHIP MANNER.

NEW WORK SHEET NOTES

1 CONNECT TO EXISTING LIGHTING CIRCUIT MADE AVAILABLE DURING THE DEMOLITION PHASE.

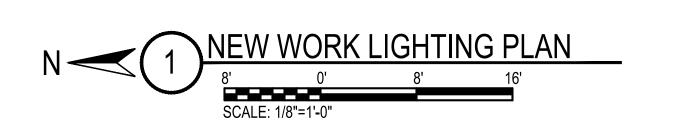








Ath FLOOR INTERIOR - 250 N. WATER S

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SHEET NAME

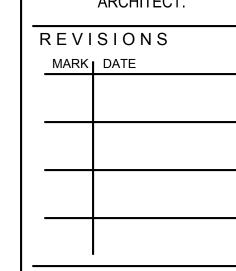4th FLOOR **POWER PLAN** - NEW WORK

PROJECT NO.

DATE


JUNE 06, 2024

2024-1

SHEET NO.

E5.0

ACTUAL SHEET SIZE IS 22" x 34"

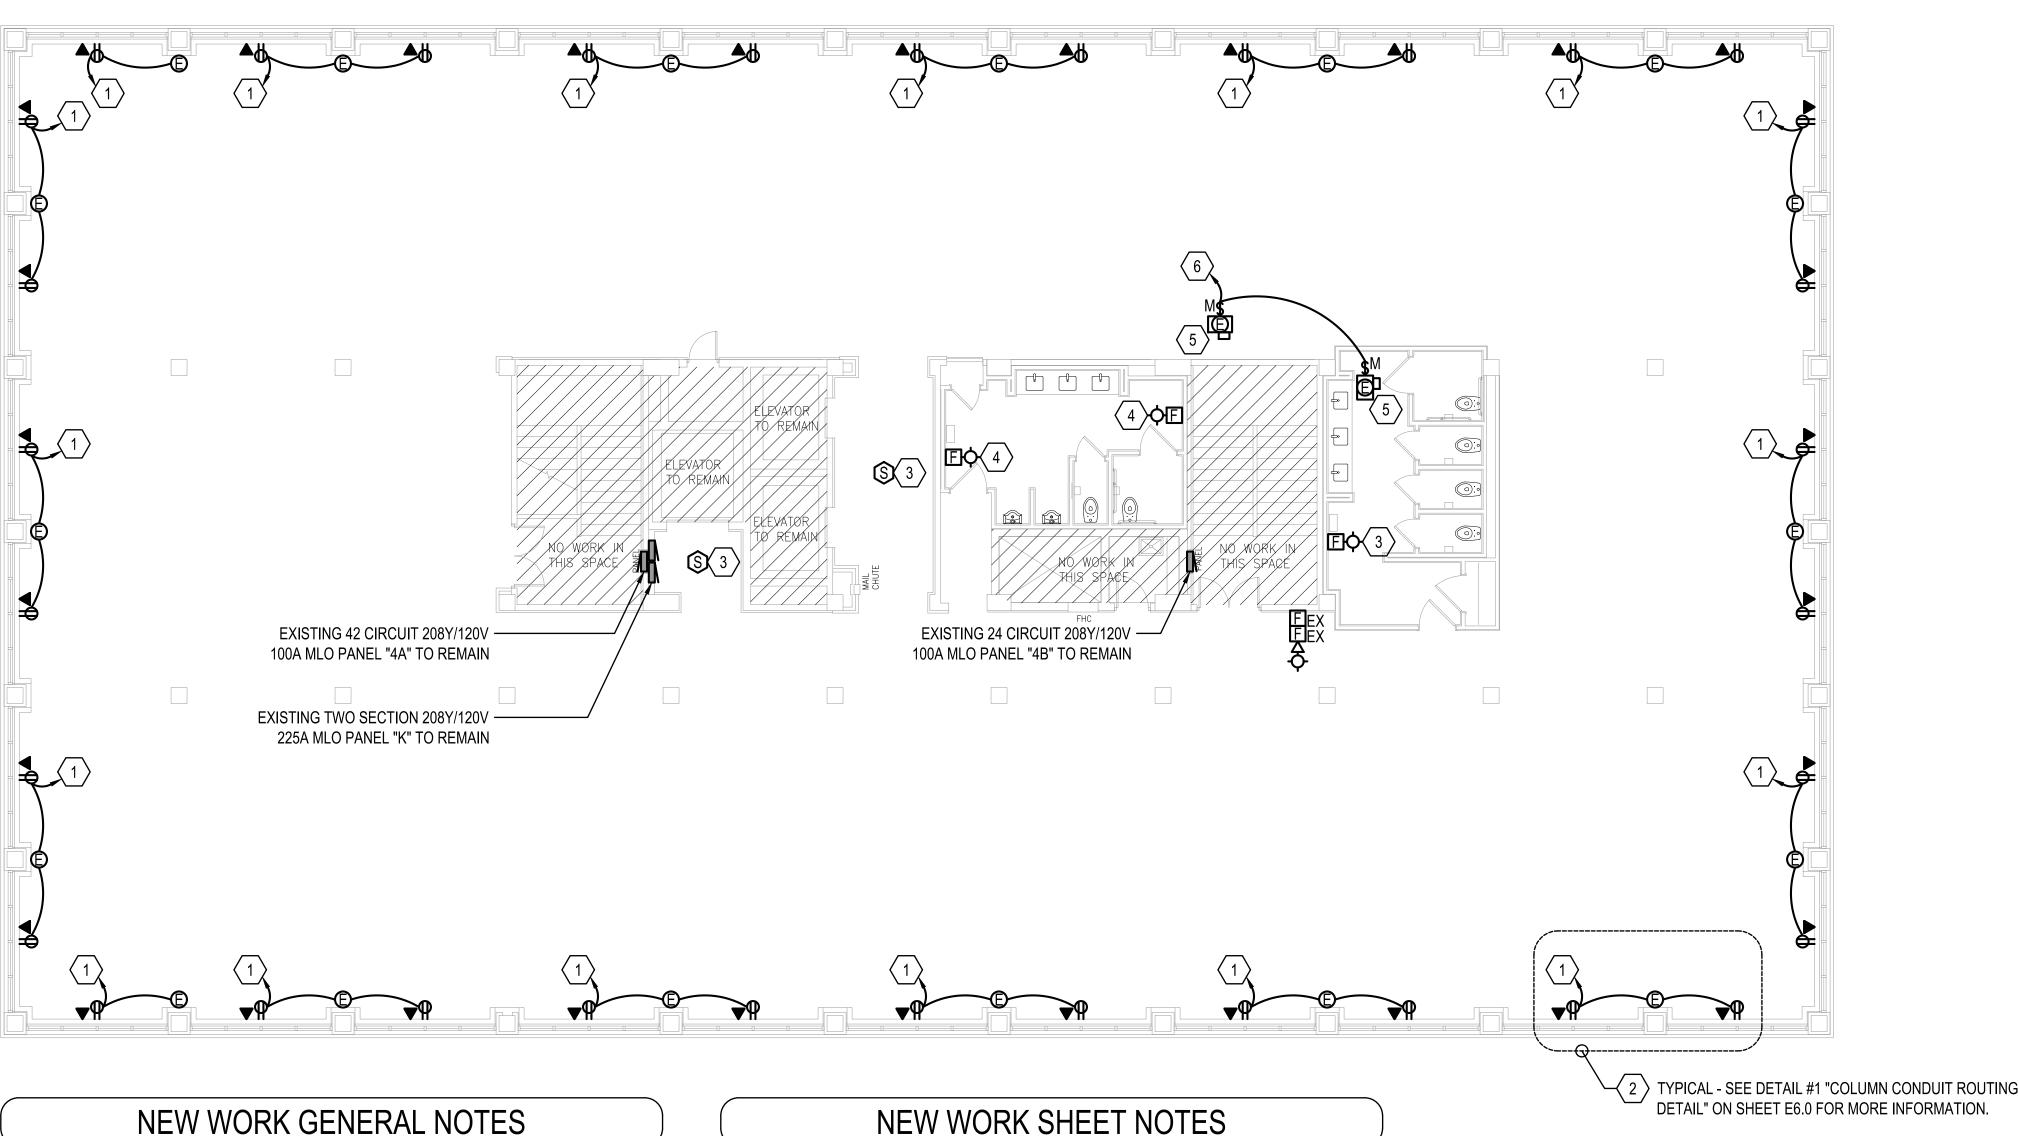

1. THE FOURTH FLOOR (OUTSIDE THE CORE STAIR / RESTROOM AREA) HAS BEEN GUTTED INTO A SHELL SPACE. EXISTING BREAKERS MADE AVAILABLE DURING THE DEMOLITION OF THE FOURTH ARE TO BE UTILIZED FOR NEW WORK. ALL NEW WORK IS TO BE PROVIDED WITH NEW CONDUIT AND CONDUCTORS. THE CEILING IN THE SHELL SPACE WILL BE EXPOSED AND OPEN TO STRUCTURE, ALL NEW CONDUIT TO EMT AND ROUTED PERPENDICULAR WITH THE BUILDING STRUCTURE IN A NEAT AND WORKMANSHIP MANNER.

- CONNECT TO EXISTING RECEPTACLE CIRCUIT MADE AVAILABLE DURING THE DEMOLITION
- 2 THE PERIMETER WALLS ARE GOING TO BE REFINISHED AS A PART OF THIS PROJECT BY OTHERS. THE NEW RECEPTACLES CENTERED UNDER THE WINDOWS ARE TO BE FED BY A NEW CIRCUIT THAT IS ROUTED DOWN THE FACE OF THE COLUMN (CONCEALED BY THE NEW WALL FINISH MATERIAL) TO A JUNCTIONS BOX WITH A BLANK PLATE AND THEN FROM THE NEW JUNCTION BOX, AROUND THE COLUMN, TO THE RECEPTACLE LOCATION.
- 3 NEW FIRE ALARM DEVICE PROVIDED AND INSTALLED BY OWNER. THE ELECTRICAL CONTRACTOR SHALL PROVIDE AND INSTALL A JUNCTION BOX AT THIS LOCATION WITH A 3/4" CONDUIT TO ABOVE ACCESSIBLE CEILING (WITH PULL STRING) IN PREPARATION FOR THE NEW DEVICE. SEE LEGEND FOR MOUNTING HEIGHT.
- 4 NEW LOCATION FOR EXISTING FIRE ALARM DEVICE. EXISTING SYSTEM TO BE TESTED AND RECERTIFIED PER NFPA 72 UPON COMPLETION OF DEVICE INSTALLATION. SEE LEGEND FOR MOUNTING HEIGHT. COORDINATE WITH OWNER FOR COMPANIES APPROVED FOR RECERTIFYING SYSTEM IN BUILDING.
- (5) APPROXIMATE LOCATION OF NEW VAV BY OTHERS. THE ELECTRICAL CONTRACTOR SHALL FIELD COORDINATE FINAL LOCATION AND POWER CONNECTION WITH MECHANICAL CONTRACTOR PRIOR TO ROUGH IN.
- 6 THE ELECTRICAL CONTRACTOR SHALL PROVIDE AND INSTALL A NEW 20/1 BREAKER IN EXISTING PANEL "4A" TO SERVE THE NEW VAV CIRCUIT. THE ELECTRICAL CONTRACTOR SHALL PROVIDE AND INSTALL NE W2#12,. #12G IN 3/4" CONDUIT FROM THE NEW 20/1 (10K AIC) BREAKER TO THE NEW VAV LOCATION.


NEW WORK POWER PLAN SCALE: 1/8"=1'-0"


			LIC	SHTING	FIXTURE	SCHEDULE
MARK	MANUFACTURER AND CATALOG NUMBER	LAMPS	TOTAL	VOLTAGE	MOUNTING	NOTES
		TYPE	WATTS			
						4" SEMI RECESSED DIMMABLE LED DECORATIVE FIXTURE
DL	SHAPER LIGHTING	LED	22.6	MVOLT	SEMI	GLASS TRIM OPTION TO BE SELECTED BY ARCHITECT PRIOR TO ORDER
	340-4C-20-D010				RECESSED	PROVIDE INTEGRAL BATTERY BACK UP AS INDICATED
						2" WIDE 4' LONG SLIM BEAM DIMMABLE LED FIXTURE
LS	STARTEK LIGHTING AMERICA	LED	25	MVOLT	SUSPENDED	COLOR & MOUNTING TO BE COORDINATED WITH ARCHITECT PRIOR TO ORDER
	SLIMD-4-750-WD-35K-80-PX-XX-U-1C					PROVIDE INTEGRAL BATTERY BACK UP AS INDICATED
						2" WIDE 4' LONG SLIM BEAM DIMMABLE SURFACE MOUNTED LED FIXTURE
LB	STARTEK LIGHTING AMERICA	LED	25	MVOLT	SURFACE	PROVIDE ALL MOUNTING HARDWARE FOR A SECURE INSTALLATION ON A GRID CEILING
	SBEAMD-4-750-WD-35K-80-PX-SM-U-1C					PROVIDE INTEGRAL BATTERY BACK UP AS INDICATED
	LITUONIALIOLITINO	. 50	40.0	N. (OLT		OVO DIMMARI E I ED EL AT DANIEL
FP	LITHONIA LIGHTING	LED	19.3	MVOLT	RECESSED	2X2 DIMMABLE LED FLAT PANEL
	CPX-2X2-AL07-80CRI-SWW7-SWL-MVOLT-					PROVIDE INTEGRAL BATTERY BACK UP AS INDICATED
WL	LITHONIA LIGHTING	LED	7.5	MVOLT	SURFACE	2' LED DIMMABLE UTILITY FIXTURE
	WL2-08L-GZ1-LP835-PAF					TO BE MOUNTED ON WALL ABOVE DOOR IN CLOSET SPACE
NOTES	FIXTURES WITH HALF FILLED IN CENTER A	ND DENOTE	O WITH AN "E	" SHALL BE P	ROVIDED WITH AN	EMERGENCY BALLAST, 1100 LUMENS OR THE MAXIMUM AVAILABLE FOR THE FIXTURE.
ALL FIXTURES ARE TO BE DIMMABLE.						
	ALL FIXTURES TO BE APPROVED BY ARCHITECT PRIOR TO ORDER.					


IT IS THE RESPONSIBILITY OF THE ELECTRICAL CONTRACTOR TO ENSURE ADEQUATE SPACE IS AVAILABLE FOR THE INSTALLATION OF ALL FIXTURES AND THAT ALL FIXTURES AND ASSOCIATED HOUSING CAN BE INSTALLED IN THE EXISTING SPACE PRIOR TO ORDER. ALL CONFLICTS ARE TO BE BROUGHT TO THE ATTENTION OF THE ARCHITECT / ENGINEER PRIOR TO FIXTURE ORDER.


ENSURE ALL FIXTURES ARE SUPPORTED FROM THE STRUCTURE AND NOT FROM THE CEILING GRID SYSTEM.


PROVIDE ALL MOUNTING HARDWARE AS REQUIRED FOR A FULL AND NEAT INSTALLATION.

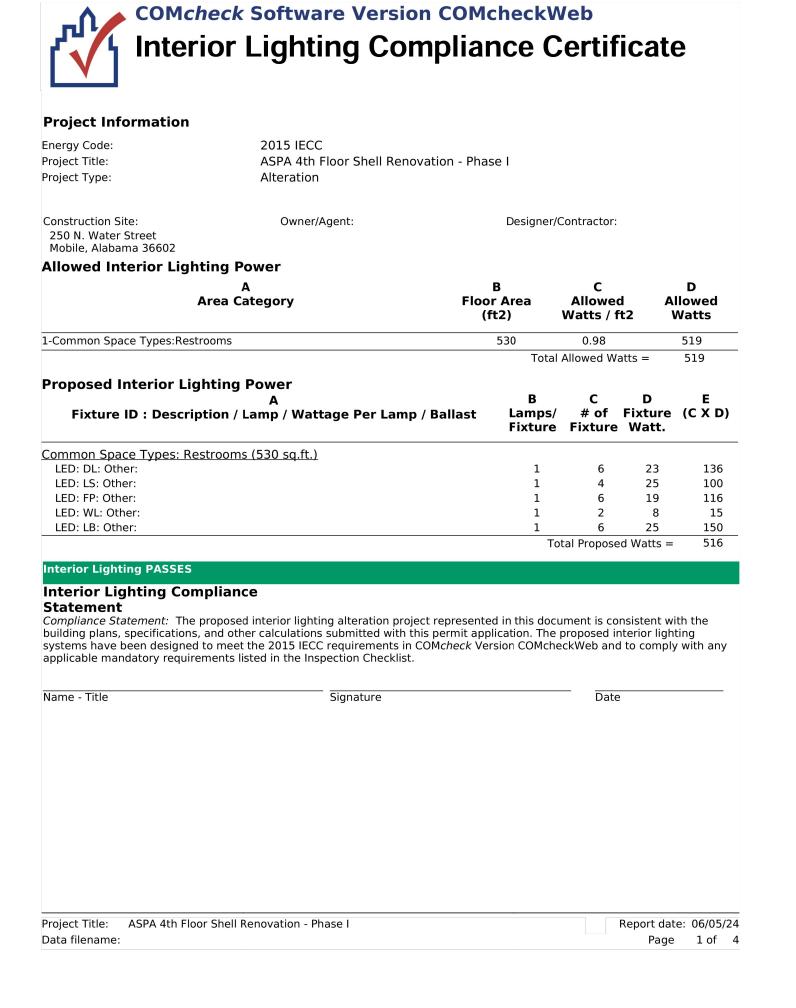

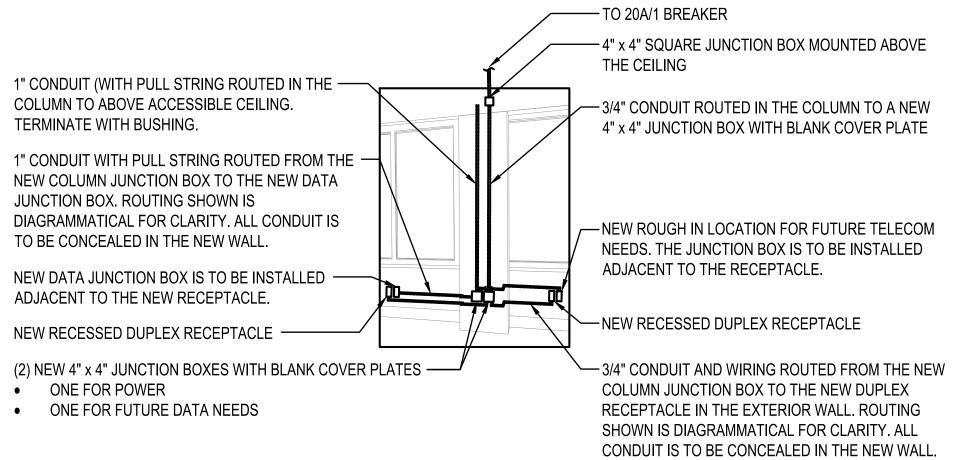


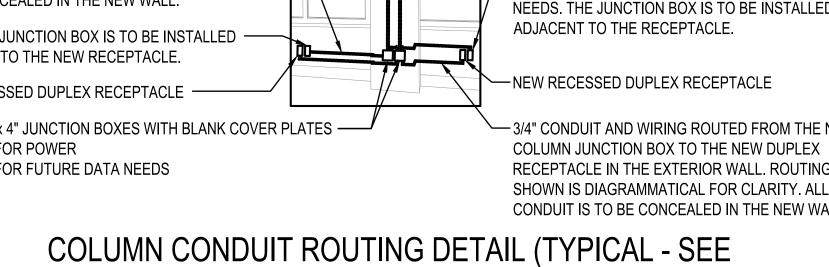

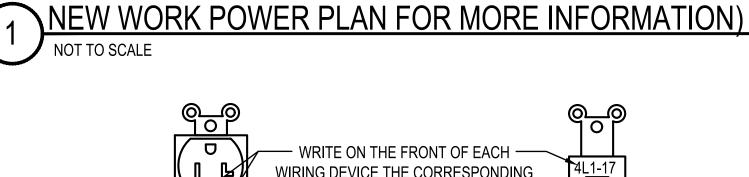


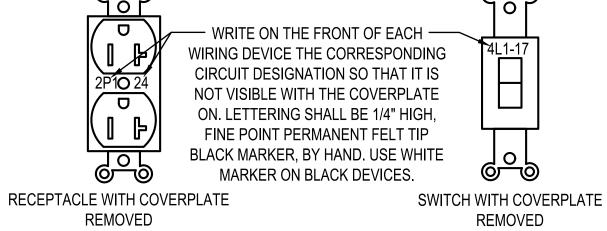



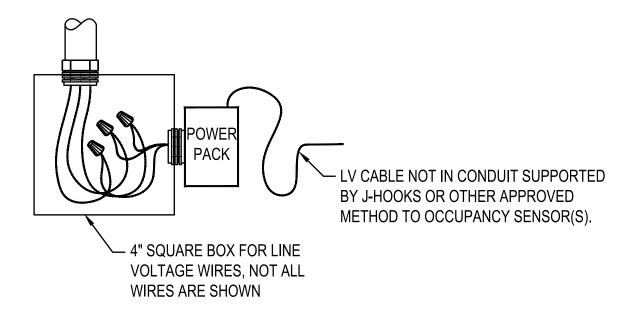

OCCUPANCY SENSOR POWER PACK DETAIL

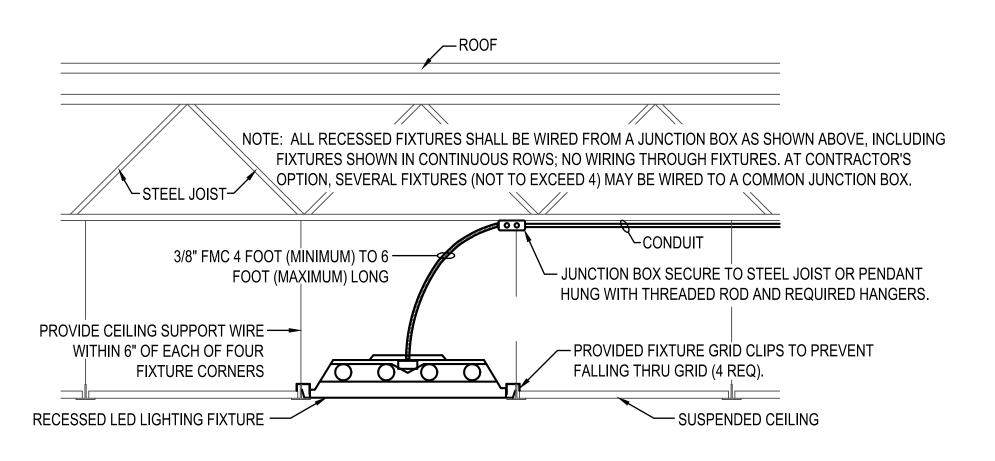





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REVISIONS						
MARK DATE						
SHEET NAME						

ELECTRICAL DETAILS AND SCHEDULES

PROJECT NO.

DATE

JUNE 06, 2024 SHEET NO.

2024-1

E6.0